GENERAL PROJECT NOTES

- 1. All work performed shall comply with these general notes unless otherwise noted on the drawings and specifications. The general contractor shall coordinate the general notes with the work of all trades, including but not limited to the mechanical and electrical trades.
- 2. The contractor shall visit the site and be knowledgeable of conditions thereof. The contractor shall investigate verify and be responsible for all conditions of the project and shall notify the owner/architect of conditions requiring modification before proceeding with the work.
- 3. The contractor shall be responsible for accurate placement of the new building additions on the site.
- Where discrepancies exist between drawings by various disciplines the contractor shall consult the architect before proceeding with the work.
- 5. Conditions which are not detailed shall be assumed to be similar in character to those which are. Where specific dimensions, details or design cannot be determined the contractor shall notify the architect prior to proceeding with the work.
- 6. Construction of work indicated on drawings as NIC is not in contract. The contractor shall coordinate all trades of his work, whether directly or indirectly involved, with NIC work.
- 7. All work shall conform to the requirements of all applicable codes and governing authorities and shall be of best practice of each trade.
- All dimensions shall take precedence over scale.
- 9. All dimensions shall be verified in the field prior to proceeding with the work. The contractor is to notify the architect of any discrepancies.
- 10. Finished floor elevations are top of concrete unless noted otherwise.
- 11. The flame spread rating for all materials shall conform to all applicable codes.
- 12. Any decorations on interior walls or ceilings shall be noncombustible or fire retardant
- treated to comply with flame spread and smoke development code requirements. 13. Refer to mechanical and electrical drawings and manufacturer's template drawings for mechanical and electrical equipment supports, bolt setting templates, spring and vibration isolators, or other equipment not shown on drawings.
- 14. Provide proper anchorage of all equipment in accordance with applicable codes.
- 15. All pipe ducts, buss ducts and conduits that penetrate floor slabs and/or rated walls shall be installed in a manner which will preserve the fire resistive and structural integrity of the
- 16. Coordinate placement of all ceiling elements with mechanical, electrical and ceiling installer. Where discrepancies exist between drawings and installation the general contractor shall consult with the architect prior to proceeding with the work.
- 17. The contractor shall provide and install all stiffeners, bracings, back-up plates and supporting brackets required for the installation of all toilet room accessories and partitions and all wall mounted or suspended items including hardware, mechanical, electrical, and miscellaneous equipment.
- 18. The contractor shall verify all concrete and masonry openings in the field prior to fabrication of doors and frames.
- 19. All dissimilar metals shall be effectively isolated from each other to prevent molecular breakdown and galvanic action.
- 20. The building may be open to the public during construction. Contractor shall protect the public from work and staging areas at all times. Co-ordinnate with the Owner concerning access and work hours. Secure construction areas at the end of each workday.
- 21. Use of tobacco products and controlled substances are prohibited on school property by state law.

PROJECT DESCRIPTION

Project includes demolition of southern portion of existing building at 200 Sleater-Kinney Rd NE and remodel of approximately 5,000 sf of additional space in the remaining portion. An approximately 30,000 square foot two story addition will be constructed within the previous building's footprint. The new addition houses administrative spaces, classrooms, and ancillary support / accessory spaces to support North Thurston Public School functions. New mechanical and electrical systems will serve these areas. A tenant improvement within the remaining space will include a new shipping and receiving area and storage for district records and books. These spaces will connect to the existing mechanical and electrical systems. Site work includes grading of South lot and new access lane to connect to existing West parking lot, relocation and extension of existing site utilities, restoration and extension of existing sidewalks.

PROJECT INFORMATION

FIVOULGI							
Project Address:	200 Sleater Kinney Rd. NE	Parking spaces provided:		104 c			
Parcel No.:	Olympia, WA 98506 11817130200			- incl			
Legal Description:	Section 17 Township 18 Range 1W Quarter SW NE			- incl			
Legal Description.	BLA150021OL TR A Document 4437623			218 a			
Parcel Area:	3.54 Acres (158,558 SF)			322 a			
Zoning:	HDC-4 High Density Corridor 4			255 ı			
Codes:	2018 IEBC Adjacent spaces are located across Kasey Keller s						
	2018 IBC	NTHS campus (same owner)					
	ICC/ANSI A117.1 - 2009 ADA	Bicycle spaces provided: Long	g Term	14 pr			
	2018 Washington State Energy Code			13 re			
Occupancy:	B, S, E	Shor	rt Term	36 pr			
Landscape Area:	19,516 SF			35 re			
Impervious Surfaces:	128,806 SF						
Hard Surfaces:	128,806 SF						
Construction type:	Type II-B (sprinklered)						

65,790 sf

75,832 sf

52,063 sf

18,519 sf

70,582 sf

5,002 sf

Gross Existing Area

First Floor

Second Floor

Gross New Area

Second Floor Existing (not used) 10,042 sf

on parcel cluding 6 ADA cluding 4 EV 8 adjacent 2 available

5 required on the

provided

required provided

required

Kevin McFarland

1250 Pacific Ave, Suite 701 Tacoma, WA 98402 T: 253.383.2797 F: 253.383.1557 Jeff Klein, PE

PROJECT TEAM

dmartinolich@nthurston.k12.wa.us Rick Hultz

North Thurston Public Schools

305 College St. NE

Lacey, WA 98516

T: 360.412.4500

Dean Martinolich

ARCHITECT

609 A Columbia St. SW

Trent Hart, Project Architect

818 Steward St. Suite 1120

fjwall@huitt-zollars.com

aardourel@huitt-zollars.com

Olympia, WA 98501

trent@tovanihart.com

CIVIL ENGINEER

Huitt-Zollars, Inc.

Seattle, WA 98101

T: 206.324.5500

Alyssa Ardourel

P.O. Box 489

T: 360.870.2511

URBAN FORESTRY

Tahuya, WA 98588

Sound Urban Forestry

suf1234@comcast.net

STRUCTURAL ENGINEER

jklein@pcs-structural.com

VICINITY MAP

MARTIN WAY E

PCS Structural Solutions

Francis Wall

Tovani Hart, PC

T: 360.339.8274

F: 360.350.5614

DRAWING INDEX

DR000 COVER SHEET

MECHANICAL ENGINEER

Hultz BHU Engineers, Inc.

Tacoma, WA 98402

rickh@hultzbhu.com

brianw@hultzhbu.com

BCE Engineers, Inc

6021 12th st. E.

Fife, WA 98424

Henry Santos

HARDWARE

2337 N. 57th St.

T: 206.528.0244

F: 206.528.0138

Gordon Adams

ACOUSTICS

241 S. Lander St.

Seattle, WA 98134

Mohammed Ait Allaoua

mohamed@a3acoustics.com

6TH AVE NE

-PROJECT SITE

A3 Acoustic

Suite 200

Seattle, WA 98103

gadams@w-link.net

Consulting

T: 253.922.0446

Suite 200

ELECTRICAL ENGINEER

henry.santos@bceengineers.com

Gordon Adams Estimating &

T: 253.383.3257

Brian White

DR001 SITE CONTEXT PLAN 1111 Fawcett Ave, Suite 100 DR011 SITE CONTEXT ELEVATIONS DR010 DESIGN REVIEW SITE PLAN DR200 DESIGN REVIEW ELEVATIONS DR201 DESIGN REVIEW ELEVATIONS

DR202 DESIGN REVIEW ELEVATIONS

CIVIL L8.01 LANDSCAPE PLAN

TOVANI HART

609 A COLUMBIA ST. SW. OLYMPIA, WA 98501 P 360.339.8274 • F 360.350.5614

SCH00 UBLIC

NORTH

NOT FOR CONSTRUCTION

2022-012 DRAWN BY DATE 09.30.2022 REVISIONS

DESIGN DEVELOPMENT

DESIGN REVIEW COVER SHEET

DR000

NORTH

ABBREVIATIONS SYMBOLS

Perforate(d)

Panel Joint

Property Line or Plate

Plastic Laminate

Stories:

New Building Areas:

Tenant Improvement Area:

Existing Building Areas: First Floor Existing

NB NC	Anchor Bolt		Elevation or Elevator	INV	Invert
VC	Asphaltic Concrete Air Conditioner	ELEV ENAM	Enamel	JAN	Janitor
CT	Acoustical Ceiling Tile	EP	Ероху	JNT	Joint
DD'L	Additional	EQ	Equal	JST	Joist
DJ _	Adjustable	ĒQUIP	Equipment		
FF	Above Finish Floor	ES	Each Side or	K	Kips or 1000 Pounds
.GG	Aggregate		Exposed Structure	KD	Knock Down or Kiln Dried
LT.	Alternate	EW.	Each Way	KIT	Kitchen
LUM	Aluminum	EXH	Exhaust	KO	Knock Out
NOD PPROX	Anodized	EXIST	Existing	KP KSI	Kick plate or King Post
RCH		(E) EXP	Exposed	NOI	Kips per Sq. Inch
11/011	Architect(ural)	EXT	Exterior	L	Length of Span or
D	Board		Exterior	_	Structural Angle
ĒDG	Building	FB	Flat Bar	LAV	Lavatory
LKG	Blocking	FD	Floor Drain	LB	Pound or LAG Bolt
M	Beam	FE	Fire Extinguisher	LBS	Pounds_
<u>O</u> .	Bottom Of or By Owner	FEC	Fire Extinguisher Bracket	LF	Linear Foot
TM	Bottom	FEM	Fire Extinguisher Cabinet	LH LKR	Left Hand
RG TWN	Bearing Between	FEIM FF	Feminine Factory Finish or	LKK	Locker Live Load
U	Built-Up		Finish Floor	LOC	Location
•	Built Op	FG	Fiberglass	LP	Light Pole
AB	Cabinet	FH	Fire Hydrant	LS	Landscaping
B	Catch Basin	FIO	Furnished & Installed by Owner	LSD	Liquid Soap Dispenser
C/C	Center to Center	FJ	Floor Joist		
G	Corner Guard	FLR	Floor	MAT	Material
HAMF	Chamfer	FND FNTD	Foundation	MAX MBR	Maximum
,J	Ceiling Joist or Control Joint	FINID	Feminine Napkin Disposal Fem. Napkin Tampon Dispenser		Member Marker Board
LG	Ceiling	FOC	Face of Concrete or	MBM	Metal Building Manufacturer
LR	Clear	. 00	Face of Column	MDO	Medium Density Overlay
МÙ	Concrete Masonry Unit	FOIC	Furnished By Owner	M/E	Mechanical/Electrical
O	Clean out		Installed by Contractor	MECH	Mechanical or Mechanically
OL	Column	FOS	Face of Stud	MED	Medium
ONC	Concrete	FOW	Face of Wall	MFG	Manufacturing
ONF	Conference	FR FRG	Frame	МН	Manufacturer Manhole
ONST ONT	Construction Continuous	FRP	Framing Fiber Reinforced Panels	MIN	Minimum
JOINT	Contract(or)	FRT	Fire Retardant Treated	MIR	Mirror
P	Cement Plaster	FT	Feet or Foot	MISC	Miscellaneous
PT	Carpet	FTG	Footing	MOD	Modular
PT-T	Carpet Tile	FUR	Furred or Furring	MTG	Mounting or Meeting
RS	Cold Rolled Steel	FV	Field Verify	MTL	Metal
T	Ceramic Tile or Porcelain Tile	GA	Gauge	MULL	Mullion
IK	Center Cultured Stone	GALV	Galvanized	N	North
TR S VG	Clitured Storie Clear Vertical Grain	GB	Grab Bar	NIC	Not in Contract
WT	Ceramic Wall Tile	ĞĈ	General Contractor	NO	Number
	Goranno Tran Tilo	GEN	General	NOM	Nominal
)	Depth	GL	Glass or Glazed	NTS	Not to Scale
BL	Double	GLB	Glue-Laminated Beam	01	0
EMO	Demolition	GR	Grading	0/	Over
ET	Detail	GWB GYP	Gypsum Wallboard	OC OD	On Center Overflow Drain or
F	Douglas Fir or Drinking Fountain	GIF	Gypsum	OD	Overnow Drain of Outside Diameter
IAG	Diagonal	Н	Height	OFF or OF	
IA IA	Diameter	НВ	Hose Bibb	OFOI	Owner Furnish Owner Install
IM	Dimension	HBD	Hardboard	OH	Overhead
ISP	Dispenser	HC	Hollow Core	OPNG	Opening
L	Dead Load	HDCP	Handicap(ped)	OPH	Opposite Hand
N	Down	HDR	Header	OPP	Opposite
R	Door	HDWB	Hardware		
S W	Downspout Dish Washer	HDWR HF	Hardwood Hem-Fir	Р	Polished
WG	Dish washer Drawing	пг HM	Hollow Metal	PAV	Paving
	Diawing	HÖRIZ	Horizontal	PAR	Parallel
	East	HT	Height	PART	Partition or Partial
Α	Each	HVAC	Heating/Ventilation/	PBD_	Particle Board

Inside Diameter

INSUL or I Insulation or Insulated

Expansion Bolt Exterior Insulation and


Finish System

Expansion Joint Elevation

Electrical




T = D D/R	Plywood Paint Pair Pounds Per Square Foot Pounds Per Square Inch Pressure Treated Paper Towel Dispenser Paper Towel Dispenser W/ Receptacle Paper Towel Receptacle Polyvinyl Chloride	TOPL TOS TPD TS TSD TV TOW TYP	Top of Parapet or Top of Pavement Top of Plate Top of Slab Toilet Paper Dispenser Tube Steel Toilet Seat Dispenser Television or TW Top of Wall Typical Unless Noted Otherwise
Y	Quarry Tile Quantity	VB	Vapor Barrier
P CPT F	Radius or Riser Rubber Base Reflected Ceiling Plan Roof Drain Receptacle or Reception Reference or Refrigerator Rubber Flooring Rafter Joist	VG VIN VP	Vinyl Composition Tile Vertical Vertical Grain Vinyl Veneer Plaster West, Wide or Width With Water Closet
INF QD SIL G	Roof Rafter Reinforcing Required Resilient Roofing Right Hand Rain Leader Room	WP WRB	With Water Closet Wood Wide Flange Wire Glass Water Heater Without Walk-off Mat Waterproof Weather Resistant Barrier
W BB	Rough Opening Right of Way Rubber	WT	Weight 1 Welded Wire Mesh
T T T T T T T T T T T T T T T T T T T	South or Structural Self Adhered Flashing Solid Core Self-Coved Base Schedule Soap Dispenser or Storm Drain Square Foot or Storefront Safety Glass Sheet Sheeting or Sheathing Similar Sealer Slab on Grade Specification Square Stainless Steel See Structural Drawings Stain Standard Storage Steel Structural Suspended Sheet Vinyl System	e e ± Ø	Center Line Property Line Plus or Minus Round, Diameter
MP G B	Tread or Top or Trimmer or Tempered Tackboard Telephone Temporary or Tempered Tongue & Groove Thickness Tight Knot Top Of Top of Beam Top of Concrete or Top of Curb		

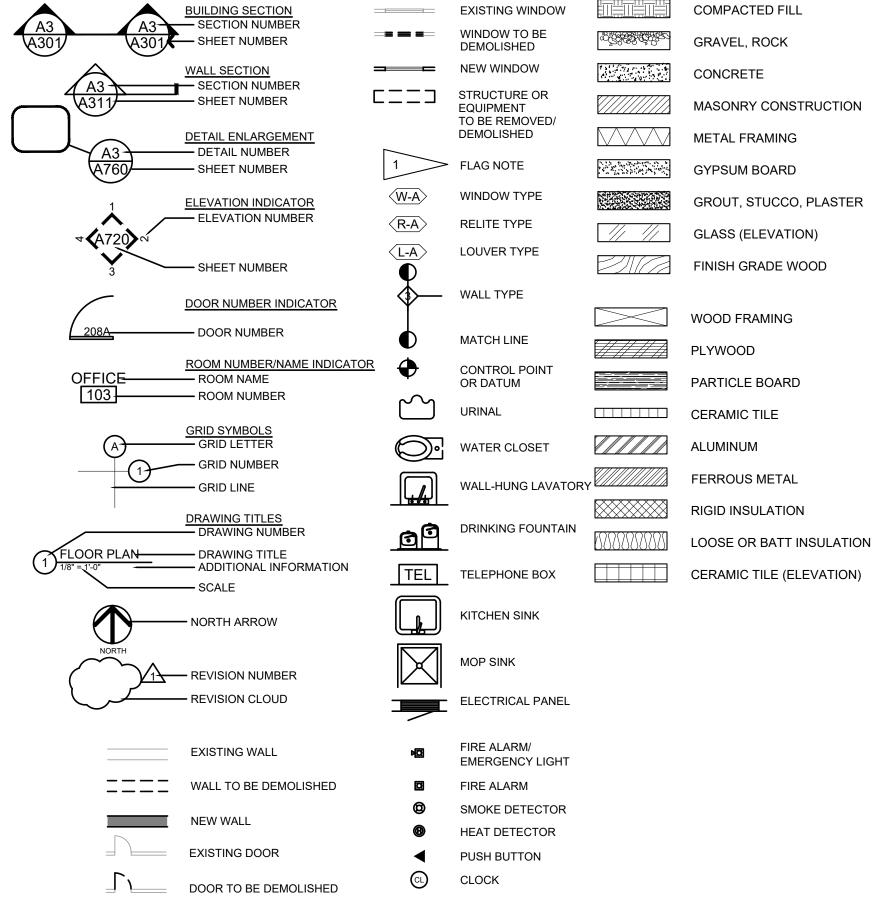

DESIGN
DEVELOPMENT
SITE CONTEX

SITE CONTEXT PLAN

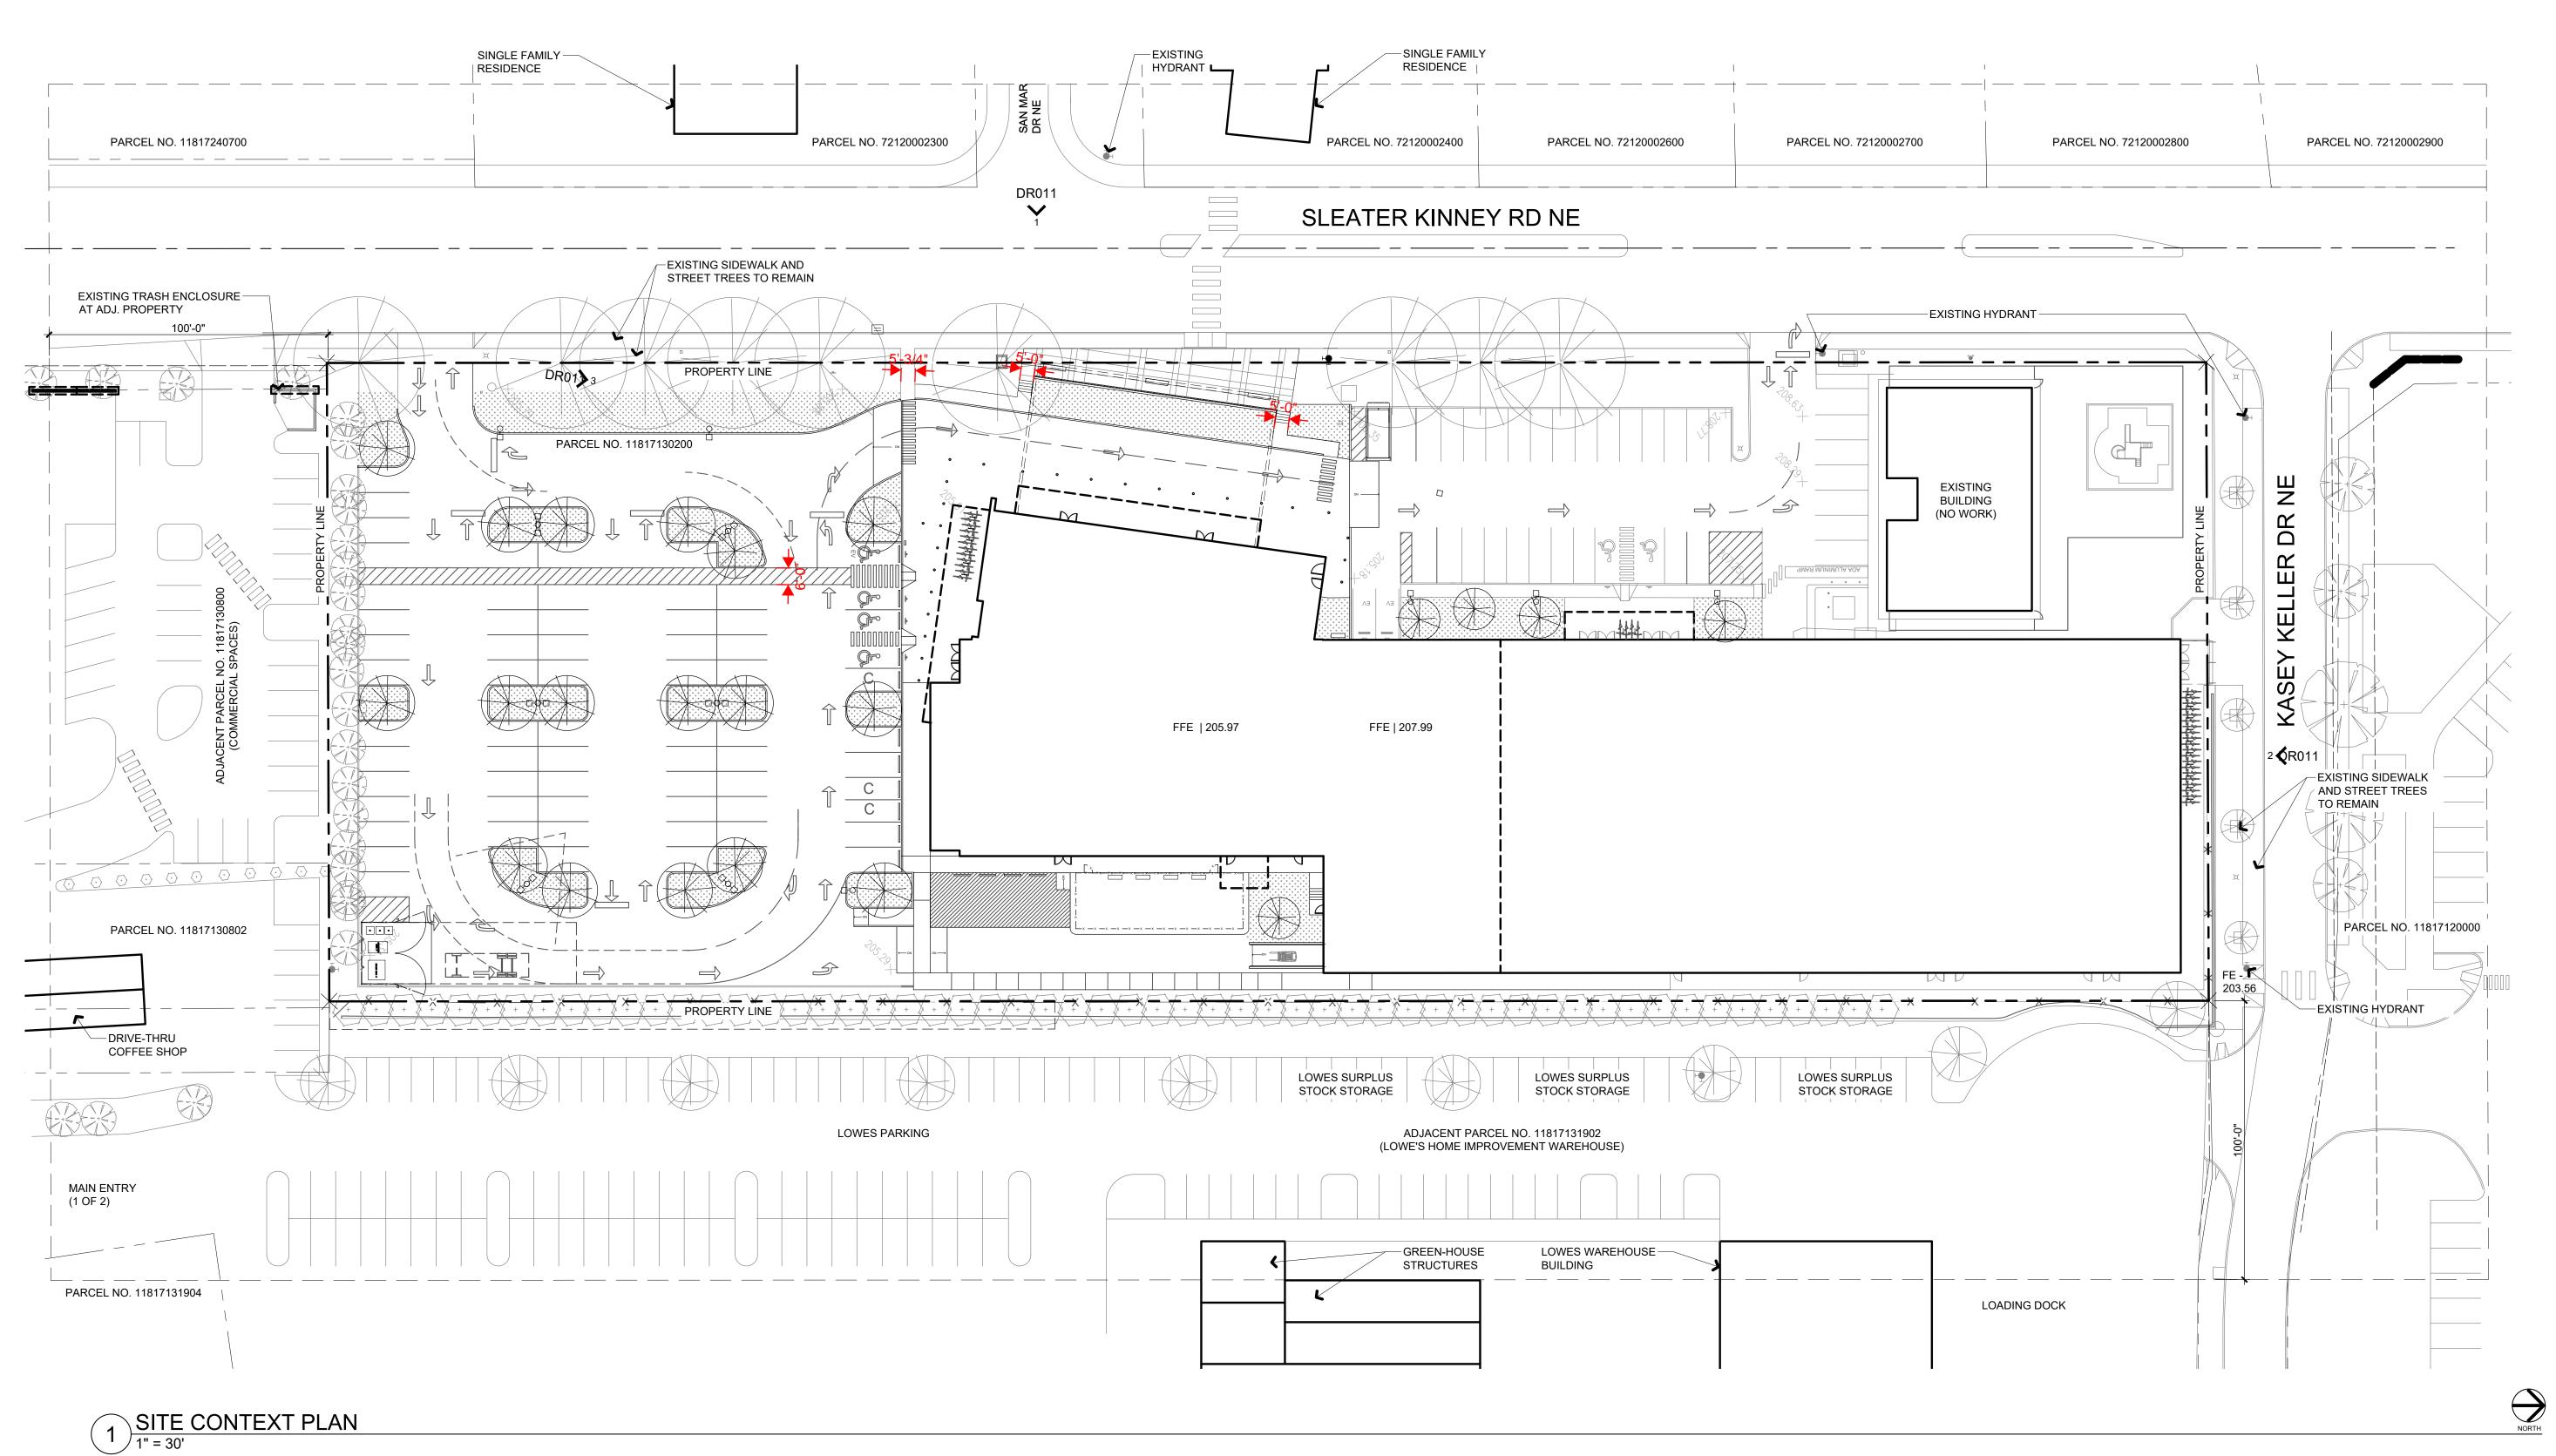

NOT FOR

JOB NO.
2022-012

DRAWN BY
KNF


DATE
09.30.2022


REVISIONS


CONSTRUCTION

DESIGN DEVELOPMENT SITE CONTEXT

ELEVATIONS

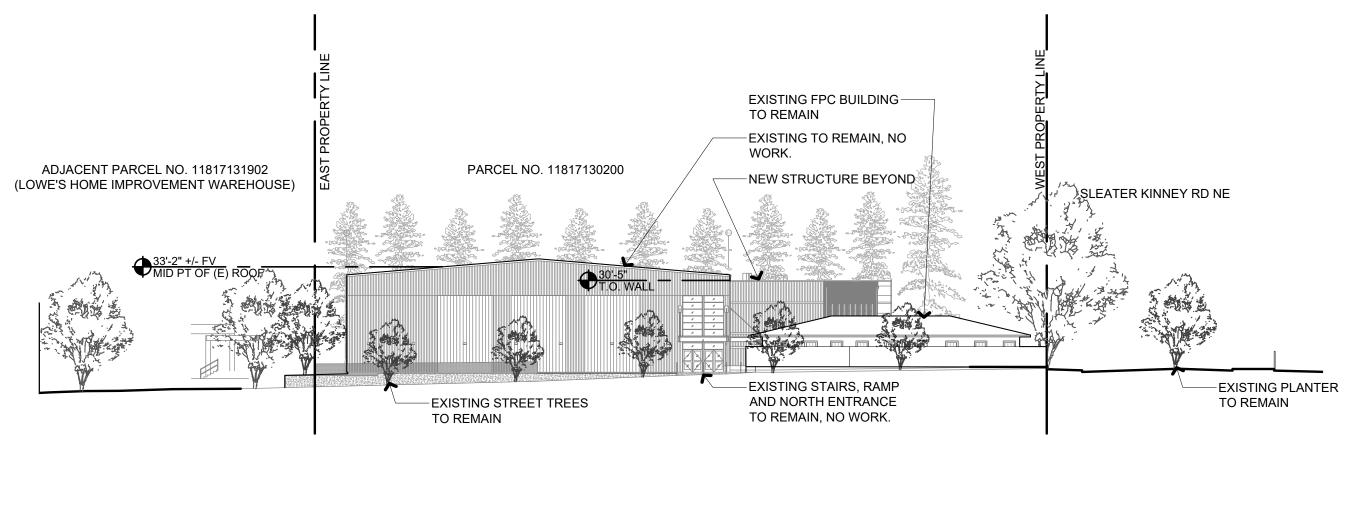

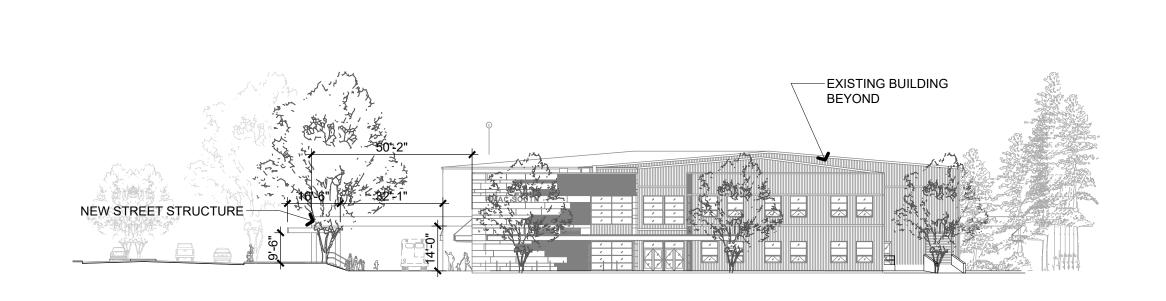

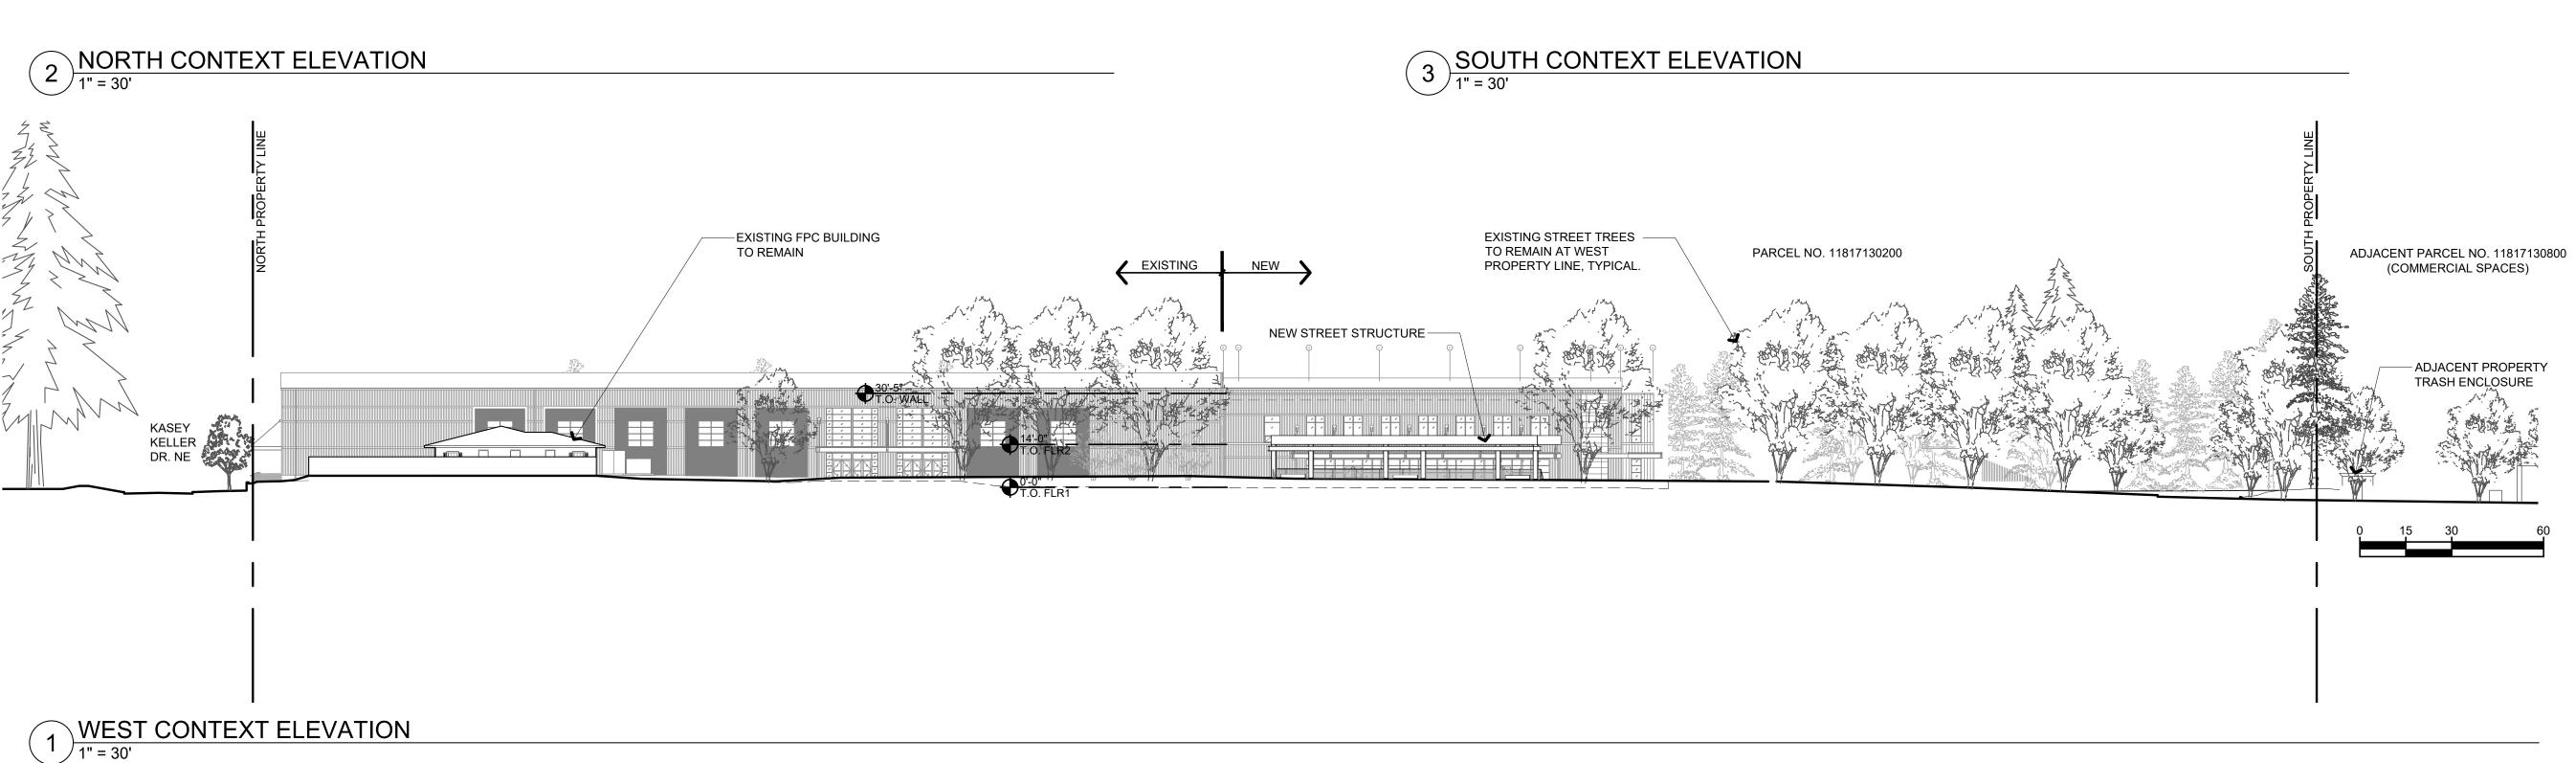

SITE PLAN LEGEND



PROJECT INFORMATION

Project Address: 200 Sleater Kinney Rd. NE Olympia, WA 98506

Olympia, WA 98506
Parcel No.: 11817130200

Legal Description: Section 17 Township 18 Range 1W Quarter SW NE BLA150021OL TR A Document 4437623

Acres: 3.54

Zoning: HDC-4 High Density Corridor 4

Codes: 2018 IEBC

2018 IBC

First Floor

ICC/ANSI A117.1 - 2009 ADA 2018 Washington State Energy Code

Occupancy: B, S, E

Construction type: Type II-B (sprinklered)

Stories:

Existing Building Areas: First Floor Existing 65,790 sf

Second Floor Existing (not used) 10,042 sf Gross Existing Area 75,832 sf

New Building Areas:

52,063 sf 18,519 sf

Second Floor18,519 sfGross New Area70,582 sf

Tenant Improvement Area:
Parking spaces provided:

5,002 sf
104 on parcel
- including 6 ADA
- including 4 EV
218 adjacent

322 available 255 required

Adjacent spaces are located across Kasey Keller st. on the


NTHS campus (same owner)


Bicycle spaces provided:

Long Term 14 provided 13 required

Short Term 36 provided

35 required

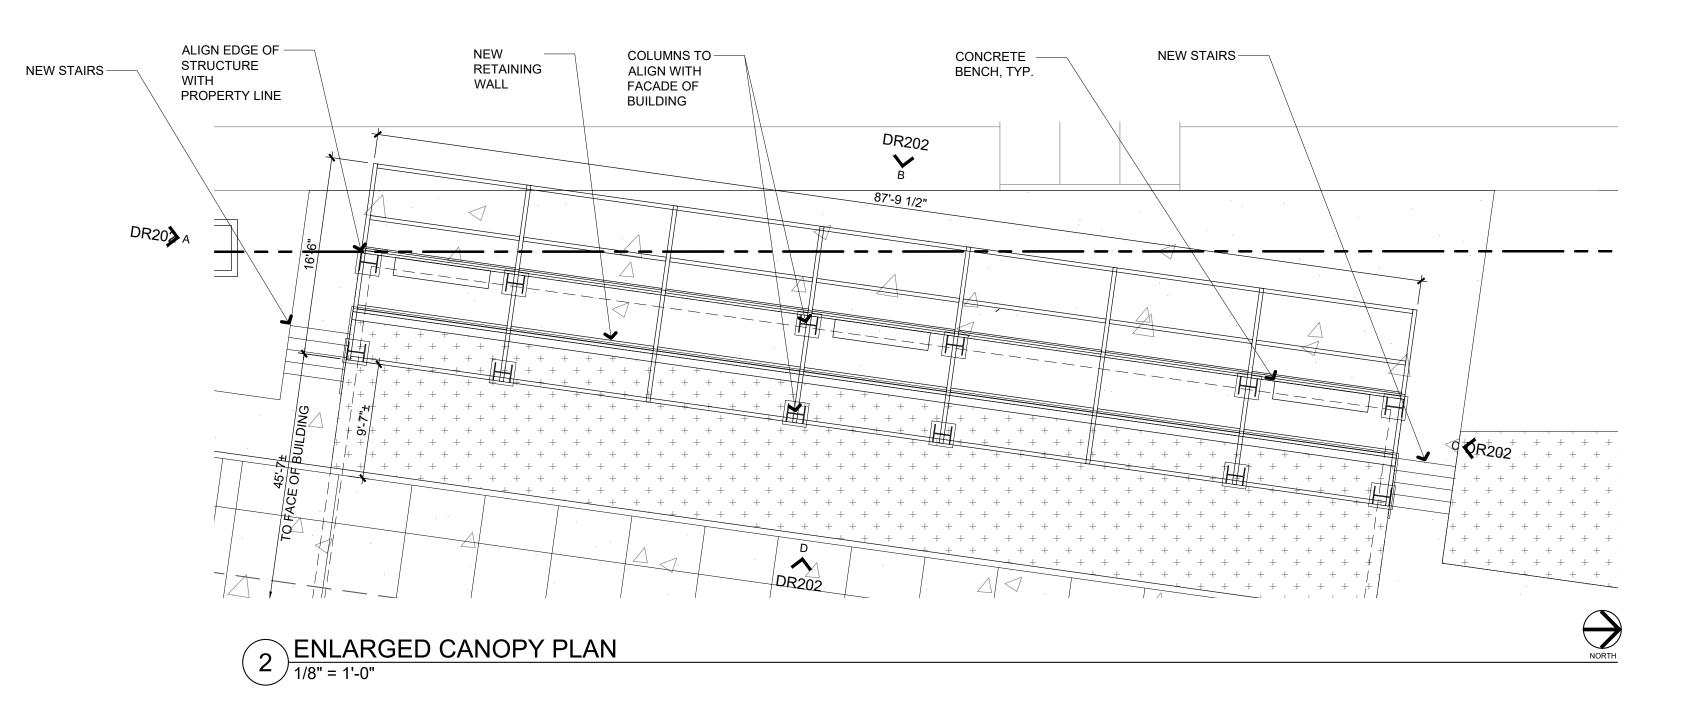

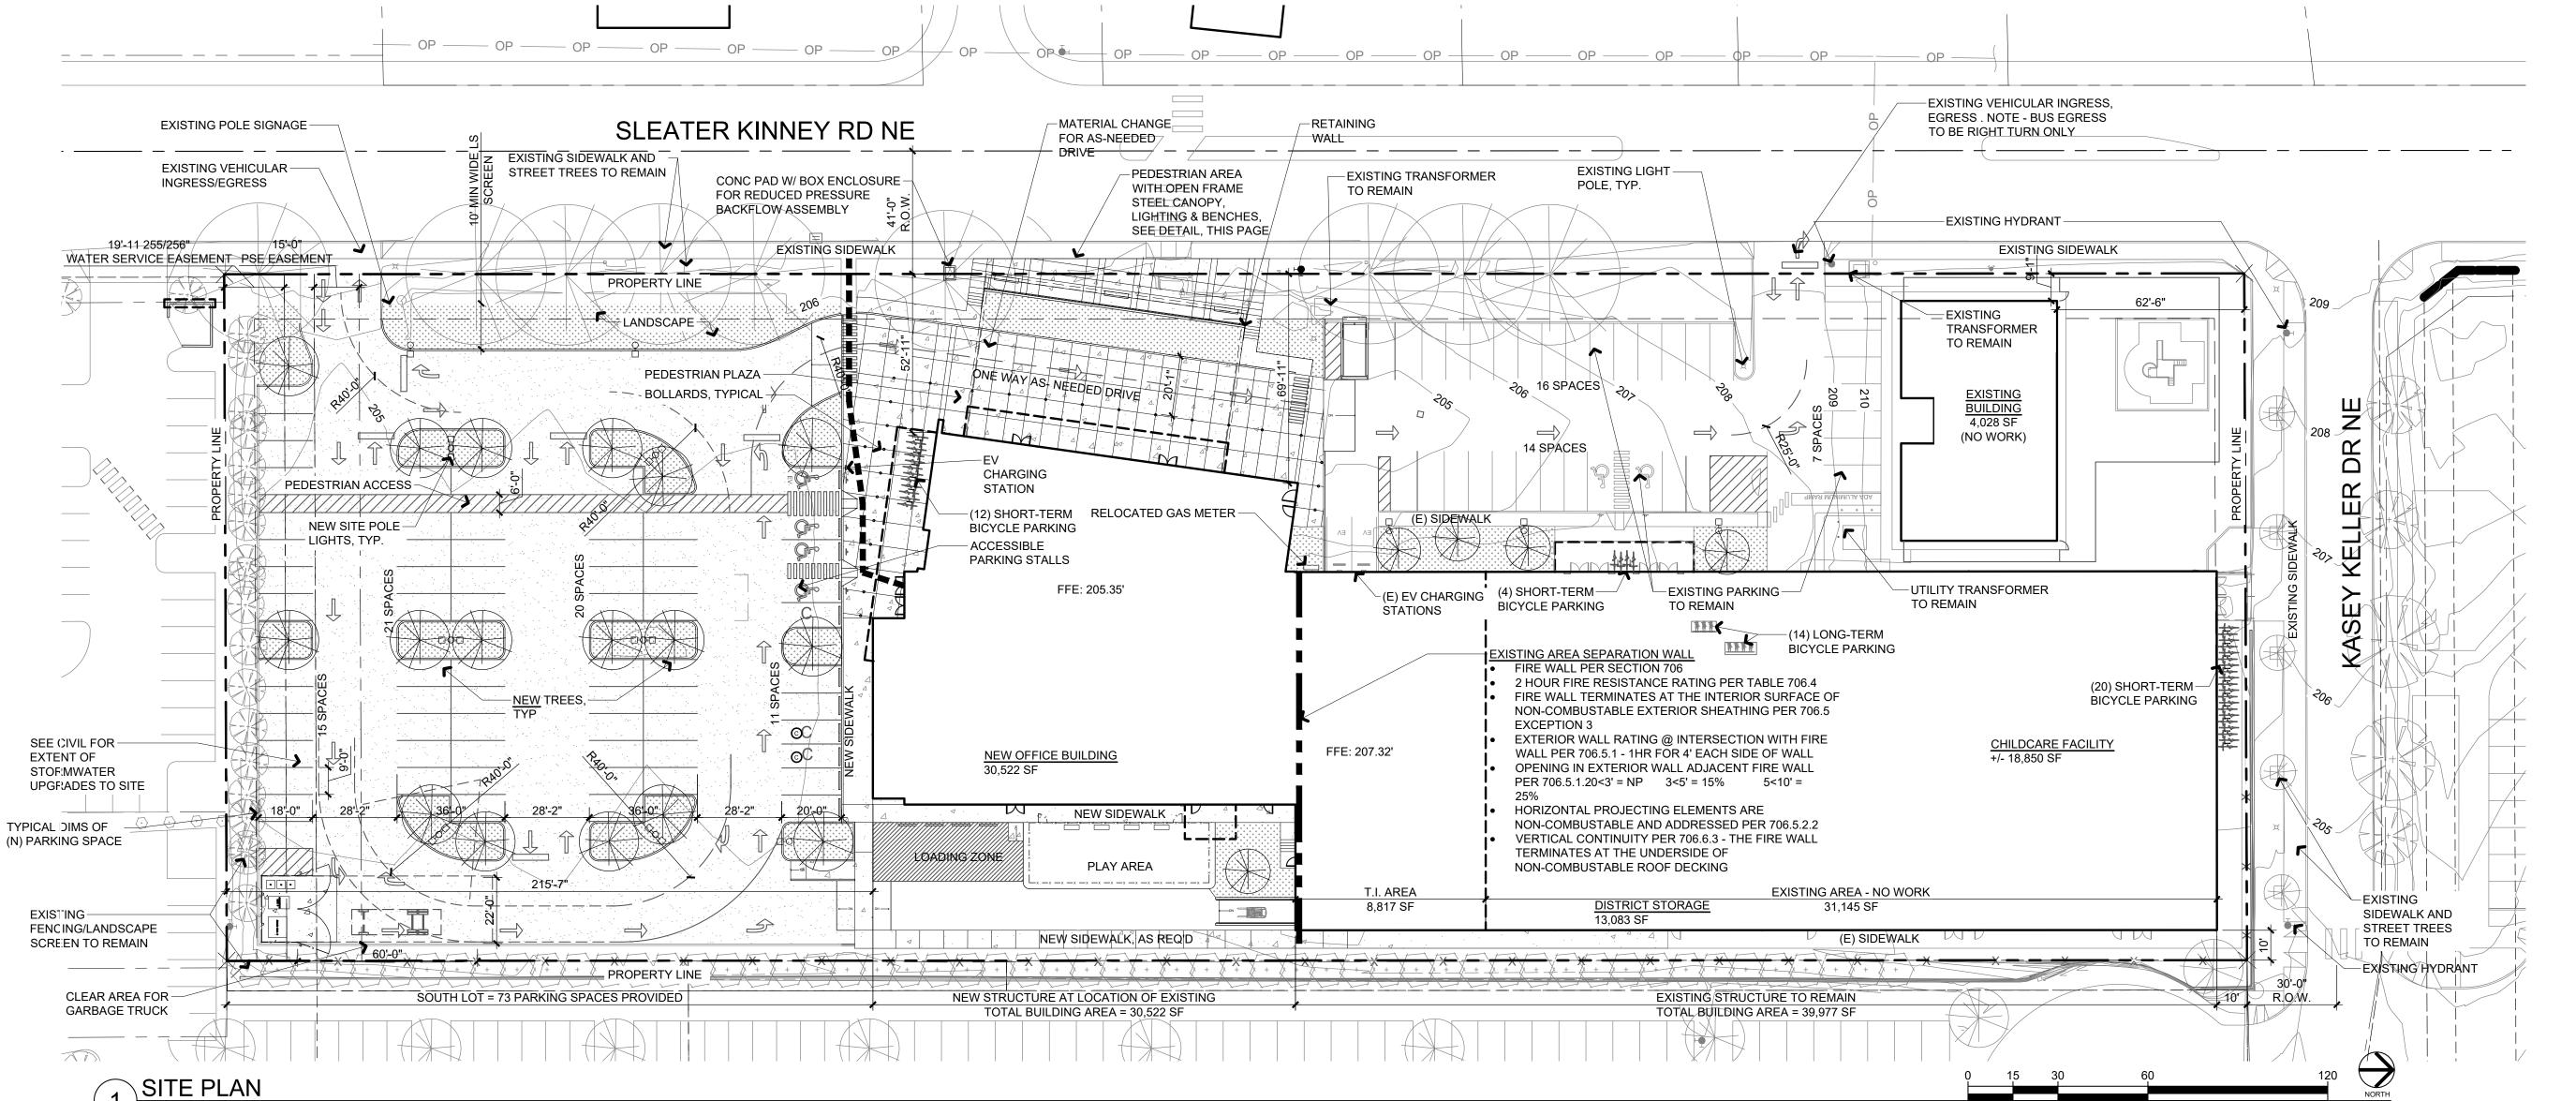

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KNF

DATE

09.30.2022

REVISIONS

DESIGN
DEVELOPMENT

DESIGN REVIEW SITE PLAN

PUBLIC HURSTO

SCHOOL

TOVANI HART

609 A COLUMBIA ST. SW. OLYMPIA, WA 98501 P360.339.8274 • F360.350.5614


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200 Sleater Kinney Rd NE Olympia, WA 98506

JOB NO. 2022-012 DRAWN BY KNF DATE 09.30.2022 REVISIONS

DESIGN DEVELOPMENT


DESIGN REVIEW ELEVATIONS

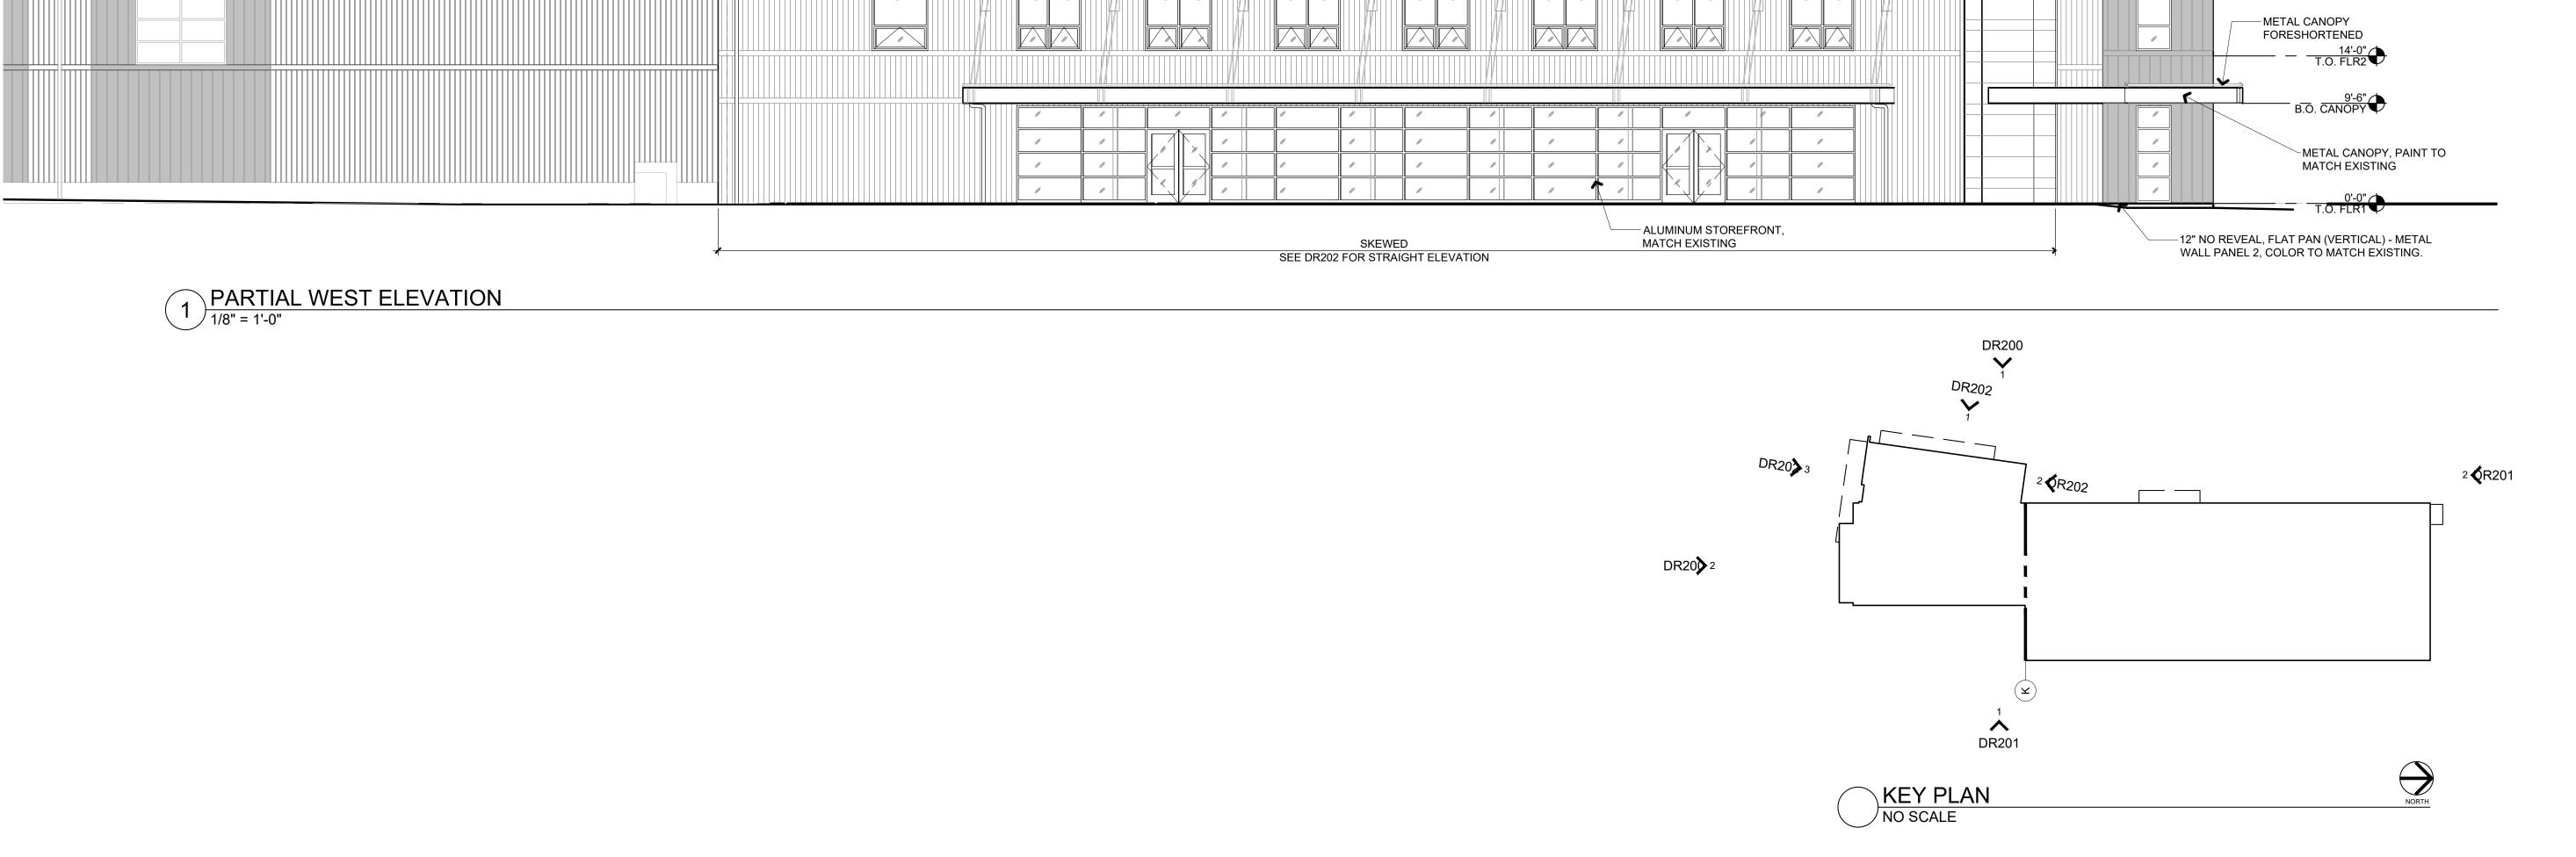

TOVANI HART

609 A COLUMBIA ST. SW.
OLYMPIA, WA 98501
P360.339.8274 • F360.350.5614

2 OVERALL NORTH ELEVATION
1/8" = 1'-0"

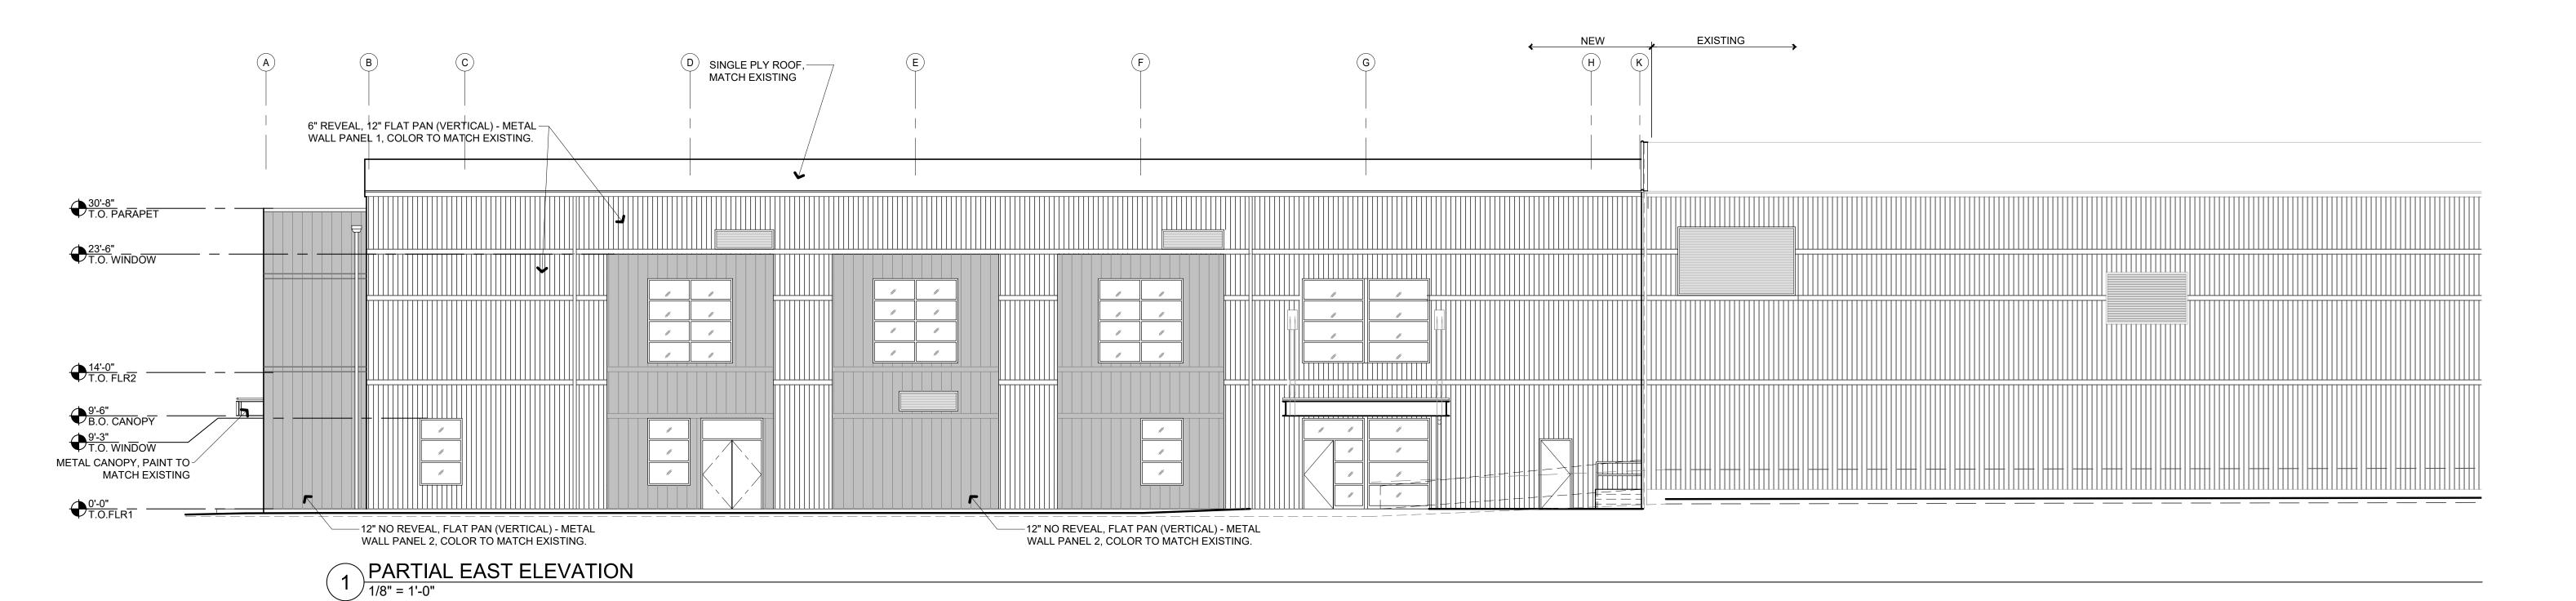

NORTH THURSTON PUE RMAC SOUTH

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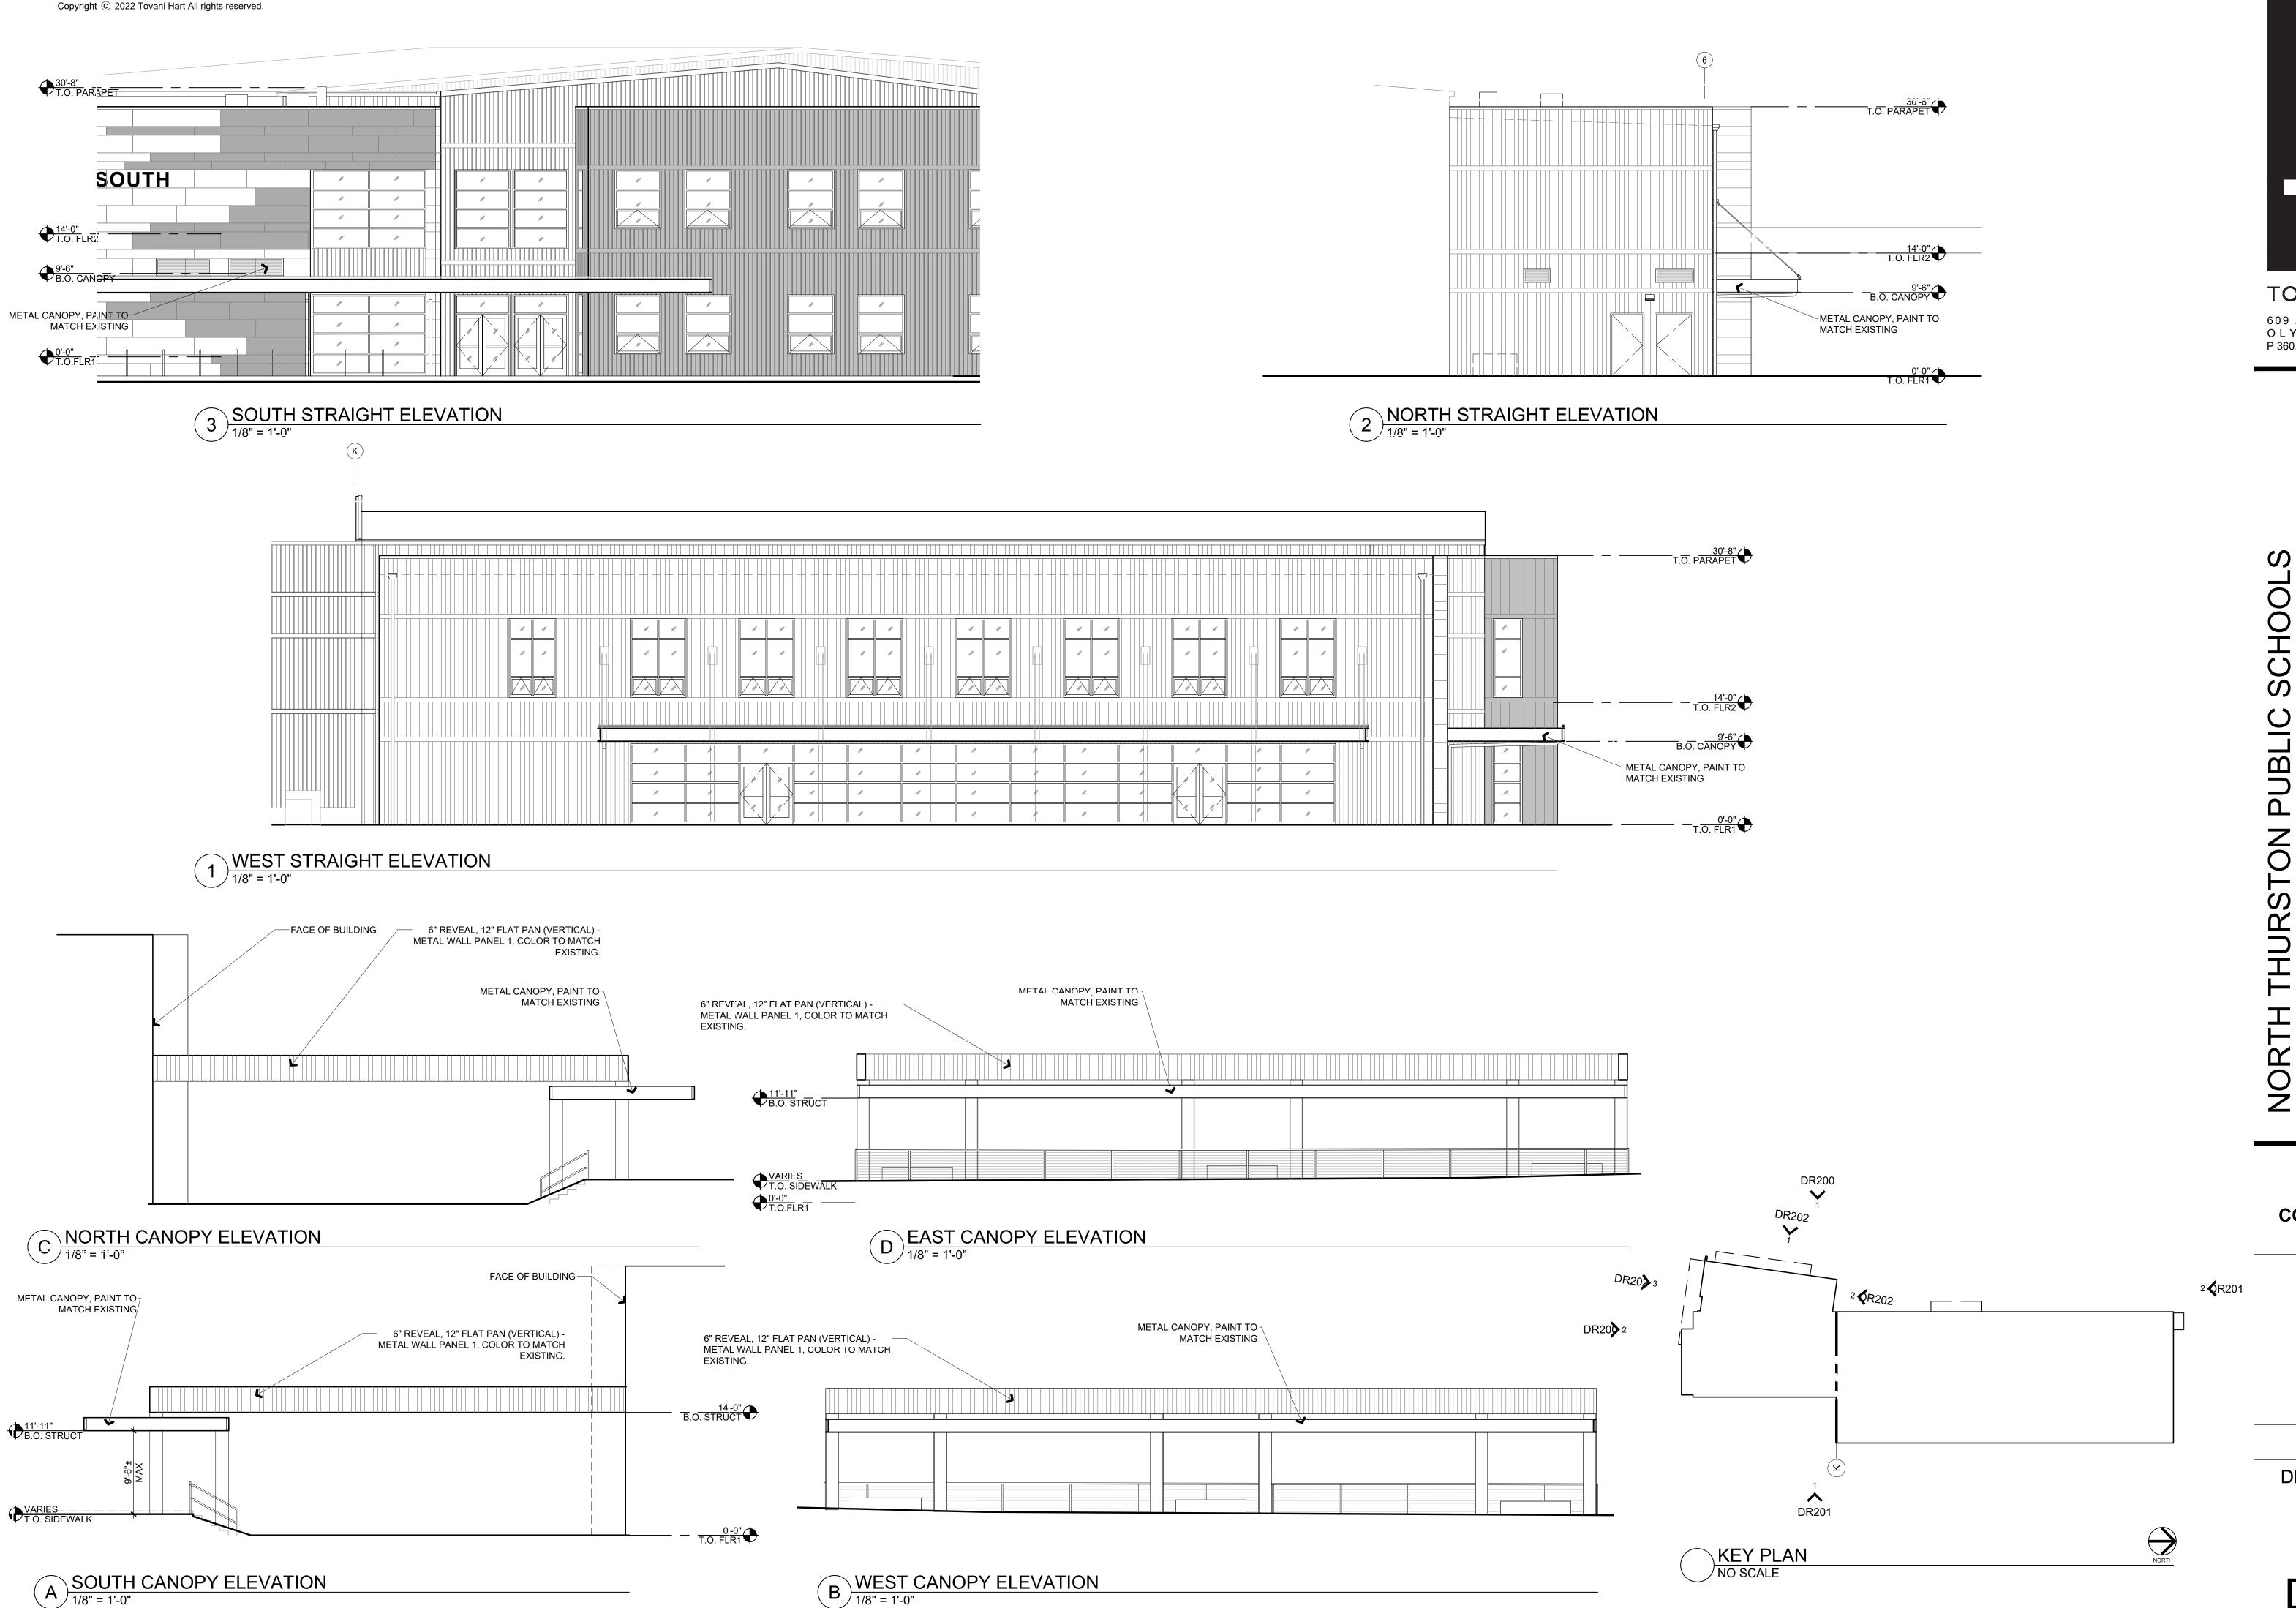
200 Sleater Kinney Rd NE Olympia, WA 98506

JOB NO. 2022-012 DRAWN BY KNF DATE 09.30.2022 REVISIONS

DESIGN
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DESIGN REVIEW

ELEVATIONS



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NORTH THURSTON PUBLIC RMAC SOUTH

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