## SOUTH PUGET SOUND COMMUNITY COLLEGE HEALTH AND WELLNESS CENTER **CUP SUBMITTAL** OLYMPIA, WASHINGTON

OWNER / APPLICANT SOUTH PUGET SOUND COMMUNITY COLLEGE 2011 MOTTMAN RD SW OLYMPIA, WA 98512

## PHONE: 360.596.5227 CONTACT: DEXTER JOHNSON CONSULTANTS

SCJ ALLIANCE 8730 TALLON LANE NE, SUITE 200 LACEY, WA 98516 PHONE: 360.352.1465 CONTACT: ROSS JARVIS, P.E.

ARCHITECT: KMB ARCHITECTS 906 COLUMBIA STREET SW, SUTIE 400 OLYMPIA, WA 98501 PHONE: 360.292.1217 CONTACT: JAMES HILL

SURVEYOR: 612 WOODLAND SQUARE LOOP SE, SUITE 100 LACEY, WA 98503 PHONE: 360.292.7230 CONTACT: JEREME CHAPMAN, P.L.S.

GEOTECH: GEOTECH:
GEOENGINEERS
1101 FAWCETT AVE #200
TACOMA, WA 98402
PHONE: 425.8616002
CONTACT: KYLE SMITH SITE INFORMATION

PARCEL NUMBER: 12828110500 ACRES: ±86.49

SITE ADDRESS: 2011 MOTTMAN RD SW OLYMPIA, WA 98512

STORMWATER/SEWER/WATER/SOLID WASTE CITY OF OLYMPIA

EMERGENCY SERVICE: 360.753.8333

EMERGENCY SERVICE: 888.225.5773

CONTACT: DAVE LESINKSI, ENGINEERING SPECIALIST, CONSTRUCTION SERVICES, PH: 253.476.6425

PH: 360.754.5912 CONTACT: WAYDE HOLMQUIST, SR DESIGN ENGINEER

ELECTRIC/NATURAL GAS: PUGET SOUND ENERGY – PSE 10885 NE 4TH ST

UTILITIES

CITY UTILITIES

PH: 360.753.8588

BELLEVUE, WA 98009 PH: 425.452.1234

CUSTOMER CONSTRUCTION:

TELEPHONE: CENTURY LINK 711 CAPITOL WAY S, STE 307 OLYMPIA, WA 98501

3130 S 38TH ST TACOMA, WA 98409

9247TH AVENUE, STE A OLYMPIA, WA 98507

BASIS OF MERIDIAN: NAD 83/91 - PER THURSTON COUNTY HIGH PRECISION NETWORK CONTROL POINTS 8204 AND 476AZ.

> CABLE: COMCAST 410 VALLEY AVE NW. STE 9 PUYALLUP, WA 98371

CONTACT: ERIC PARTON, COMCAST BUSINESS SERVICES GROUP

DATUM:


NAVD 88 - PER THURSTON COUNTY HIGH PRECISION

NETWORK CONTROL POINT 8204.

SHEET INDEX			
SHEET NO.	SHEET TITLE	SHEET DESCRIPTION	
1	CV-01	COVER SHEET	
2	EX-01	TOPOGRAPHIC SURVEY	
3	EC-01	DEMOLITION AND TESC PLAN	
4	SP-01	SITE IMPROVEMENT PLAN	
5	CG-01	GRADING PLAN	
6	SD-01	DRAINAGE PLAN	
7	SD-02	DRAINAGE DETAILS	
8	UT-01	WATER AND SEWER PLAN	

UT-02 WATER AND SEWER DETAILS

Olympia, Washington 98501 360.352.8883

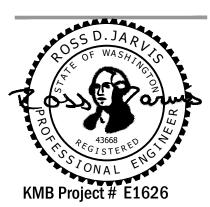

**ADDITION** S CENTER RENOVATION AND COMMUNITY COLLEGE
WA 98512

Hotel RL by Red Li Sound ston County Family & Juvenile Court

> A PORTION OF SEC 28, T18N., R2W., W.M. OLYMPIA, WA

## CALL BEFORE YOU DIG

THE CONTRACTOR SHALL BE FULLY RESPONSIBLE FOR THE LOCATION AND PROTECTION OF ALL EXISTING UTILITIES. THE CONTRACTOR SHALL VERIFY ALL UTILITY LOCATIONS PRIOR TO CONSTRUCTION BY CALLING THE UNDERGROUND LOCATE LINE AT (800) 424-5555 A MINIMUM OF 48 HOURS PRIOR TO ANY EXCAVATION.




8730 TALLON LANE NE, SUITE 200, LACEY, WA 98516 P: 360.352.1465 F: 360.352.1509 SCJALLIANCE.COM

DATE: 05/02/2018 **DESIGN DEVELOPMENT** SHEET NO.


ORIGINAL SHEET SIZE = 24 x 36 HALF SIZE REDUCTIONS = 11 x 17

SOUTH PUGET SOUND 2011 MOTTMAN ROAD SW, OLYMPIA, STATE PROJECT NO. 2018-111A

CV-01 **COVER SHEET** 

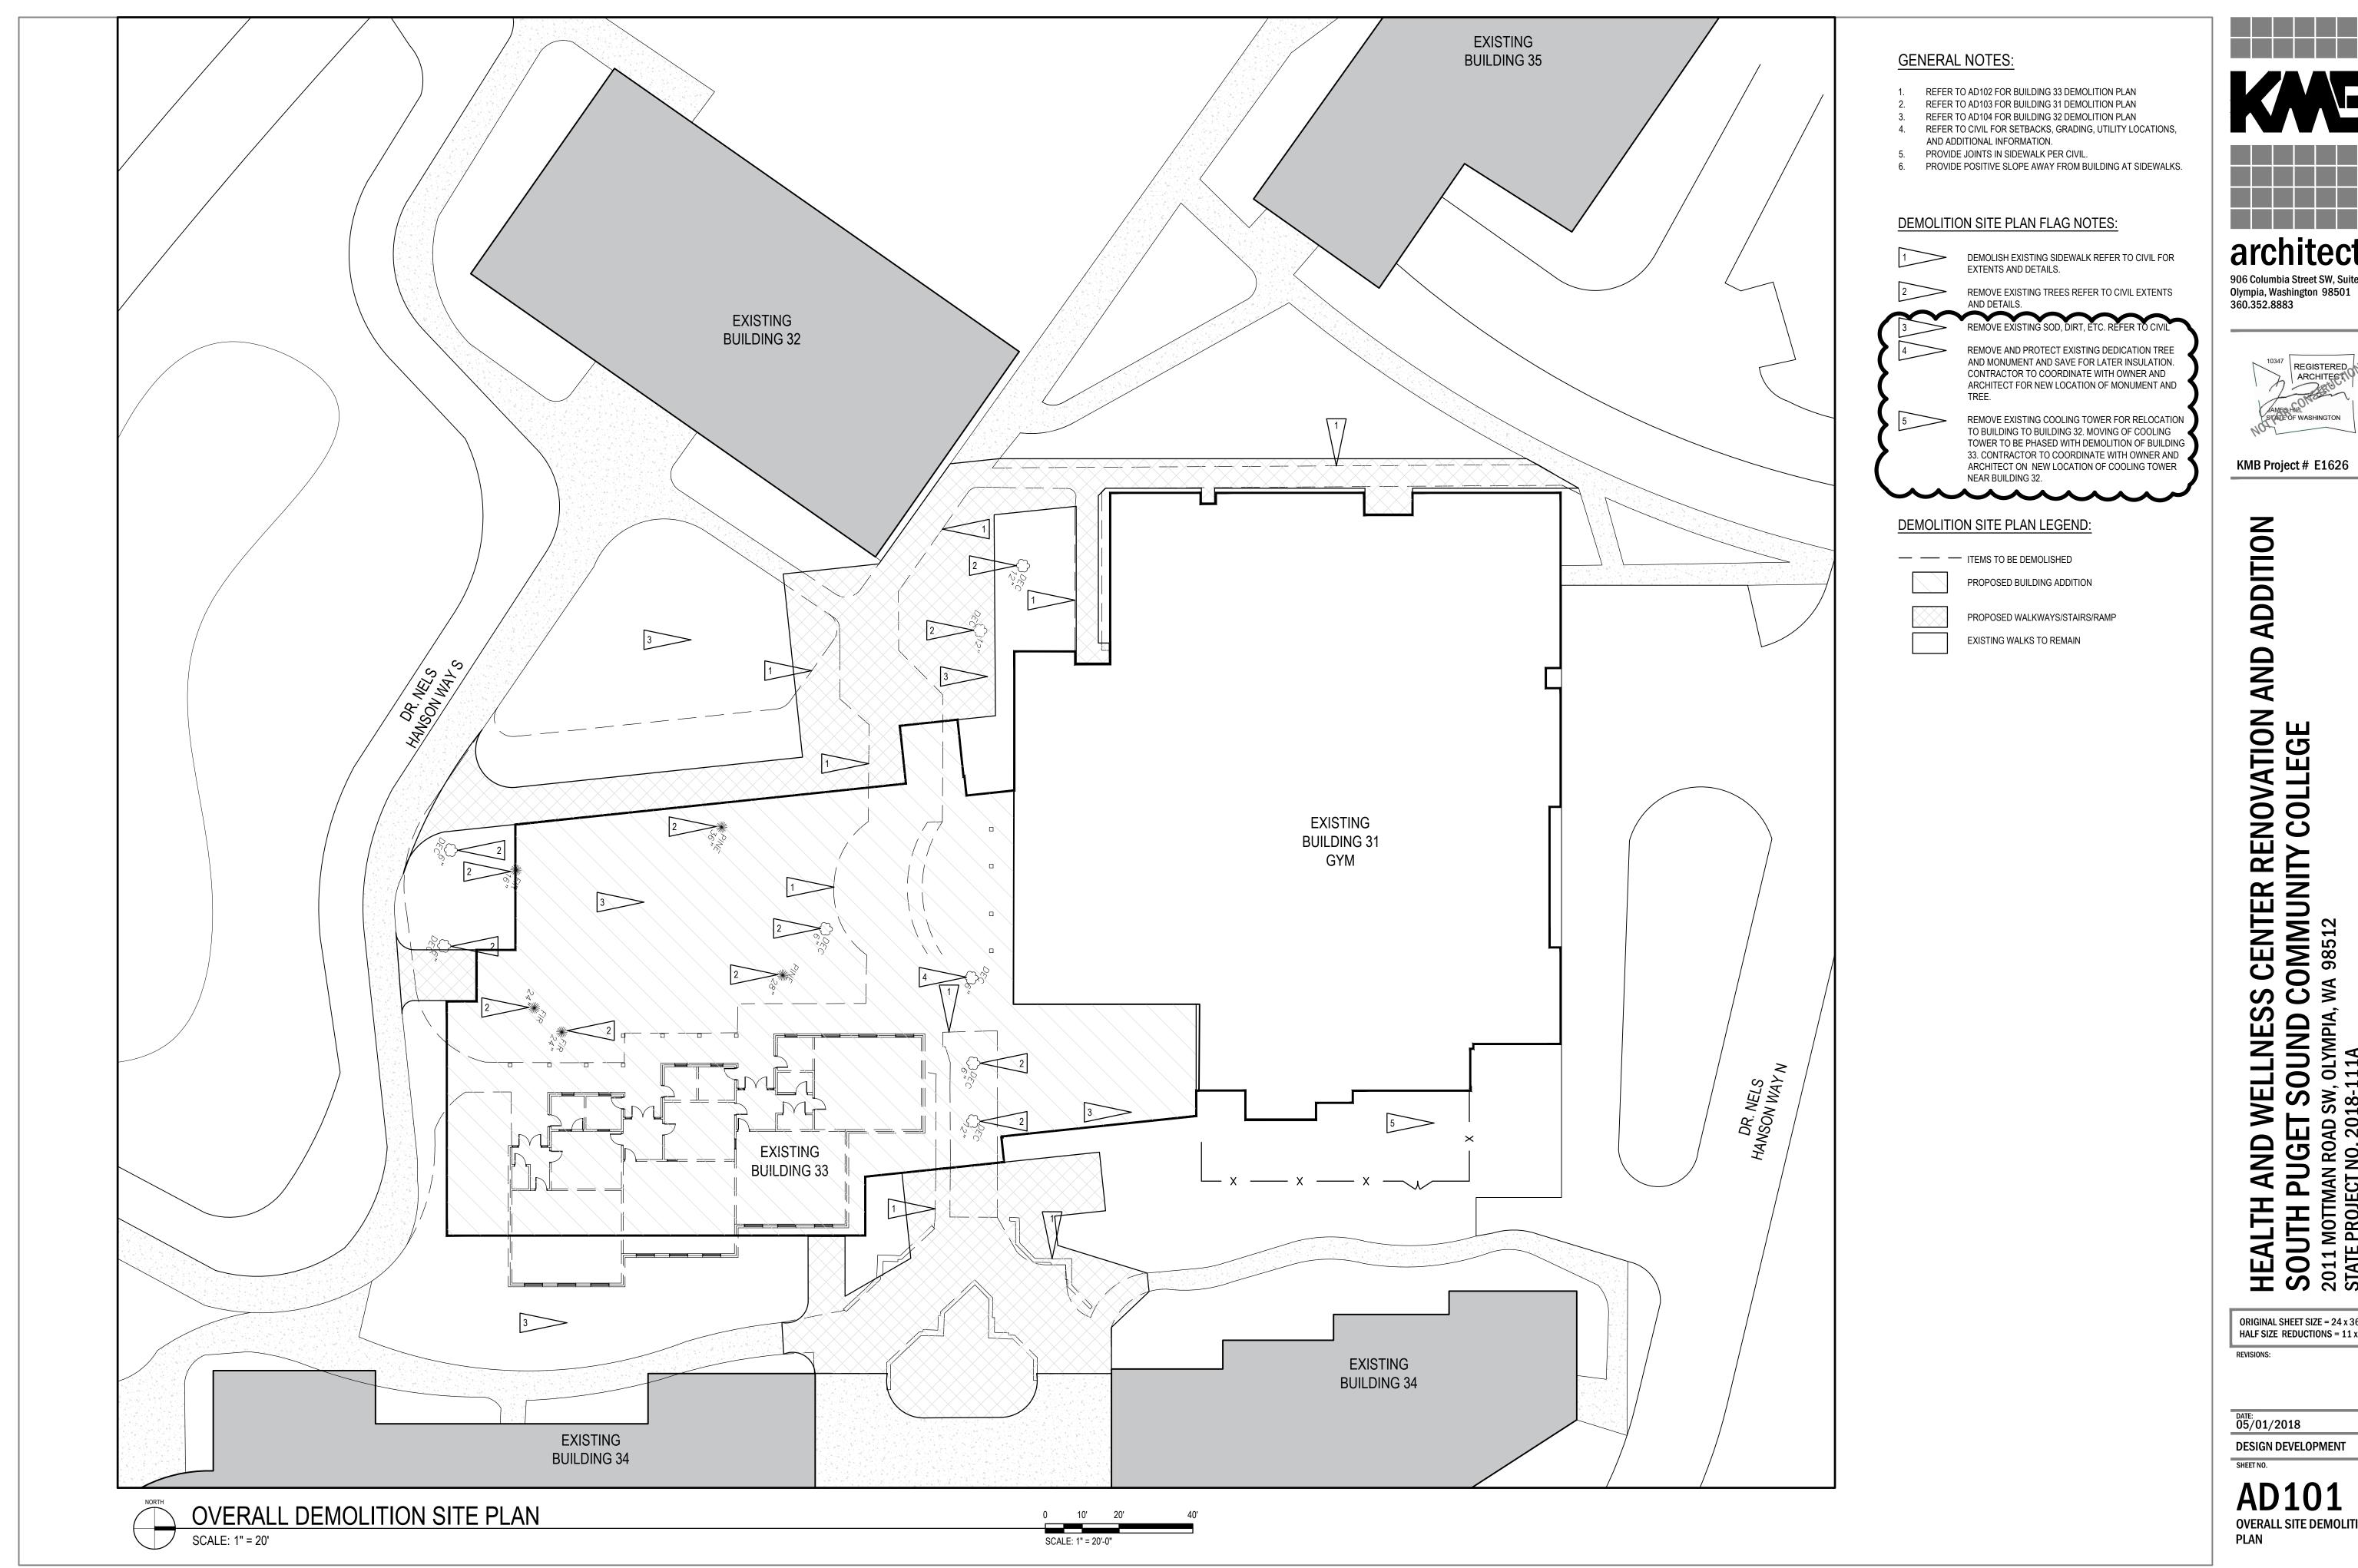



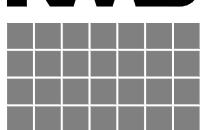



KMB Project # E1626

**ADDITION** 


HEALTH AND WELLNESS CENTER RENOVATION AND SOUTH PUGET SOUND COMMUNITY COLLEGE
2011 MOTIMAN ROAD SW, OLYMPIA, WA 98512
STATE PROJECT NO. 2018-111A

ORIGINAL SHEET SIZE = 24 x 36 HALF SIZE REDUCTIONS = 11 x 17

DATE: 05/01/2018 DESIGN DEVELOPMENT

**AD101** OVERALL SITE DEMOLITION PLAN



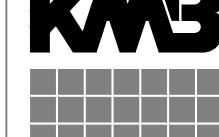



KMB Project # E1626

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**ADDITION** 

HEALTH AND WELLNESS CENTER RENOVATION AND SOUTH PUGET SOUND COMMUNITY COLLEGE 2011 MOTTMAN ROAD SW, OLYMPIA, WA 98512 STATE PROJECT NO. 2018-111A

DATE: 05/01/2018

DESIGN DEVELOPMENT
SHEET NO.

ORIGINAL SHEET SIZE = 24 x 36 HALF SIZE REDUCTIONS = 11 x 17

AS101 OVERALL SITE PLAN

## **GENERAL NOTES:**

- 1. REFER TO SHEETS A-501 AND A-502 FOR EXTERIOR WALL AND PARTITION TYPES.
- REFER TO ENLARGED PLANS FOR ADDITIONAL WALL TYPE CALL-OUTS AND DIMENSIONS.
- GRID DIMENSIONS ARE TO EXTERIOR FACE OF STUD.
- DIMENSIONS ARE TO GRID OR FACE OF STUD. REFER TO A-601 FOR DOOR SCHEDULE.
- REFER TO A-611 FOR DOOR, RELITE, AND FRAME TYPES REFER TO A-612 FOR STOREFRONT AND WINDOW TYPES
- REFER TO A-621 FOR FINISH SCHEDULE


## PLAN LEGEND:

WALK OFF MAT


BRACKET MOUNTED FIRE EXTINGUISHER

FIRE EXTINGUISHER AND CABINET

DS. DOWNSPOUT

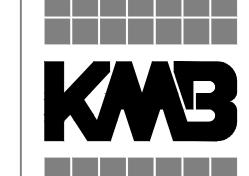



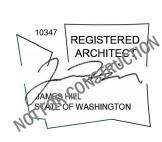

## KMB Project # E1626


HEALTH AND WELLNESS CENTER RENOVATION AND ADDITION SOUTH PUGET SOUND COMMUNITY COLLEGE

2011 MOTIMAN ROAD SW, OLYMPIA, WA 98512
STATE PROJECT NO. 2018-111A

DATE: 05/01/2018 DESIGN DEVELOPMENT

A-101 **OVERALL FLOOR PLAN** 

SCALE: 1/16" = 1'-0"

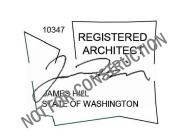

KMB Project # E1626

HEALTH AND WELLNESS CENTER RENOVATION AND ADDITION SOUTH PUGET SOUND COMMUNITY COLLEGE


2011 MOTIMAN ROAD SW, OLYMPIA, WA 98512
STATE PROJECT NO. 2018-111A

ORIGINAL SHEET SIZE = 24 x 36 HALF SIZE REDUCTIONS = 11 x 17

DATE: 05/01/2018 DESIGN DEVELOPMENT
SHEET NO.

A-201

OVERALL EXTERIOR ELEVATIONS

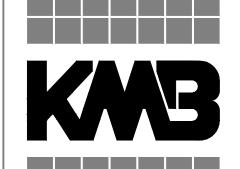






KMB Project # E1626

HEALTH AND WELLNESS CENTER RENOVATION AND ADDITION SOUTH PUGET SOUND COMMUNITY COLLEGE
2011 MOTIMAN ROAD SW, OLYMPIA, WA 98512
STATE PROJECT NO. 2018-111A

ORIGINAL SHEET SIZE = 24 x 36 HALF SIZE REDUCTIONS = 11 x 17

DATE: 05/01/2018 **DESIGN DEVELOPMENT** 

A-301 **BUILDING SECTIONS** 

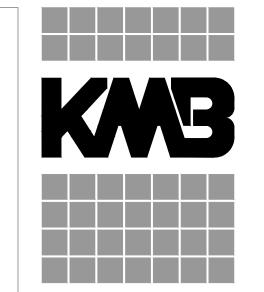



SOUTH PUGET SOUND COMMUNITY COLLEGE
STATE PROJECT NO. 2018-111A
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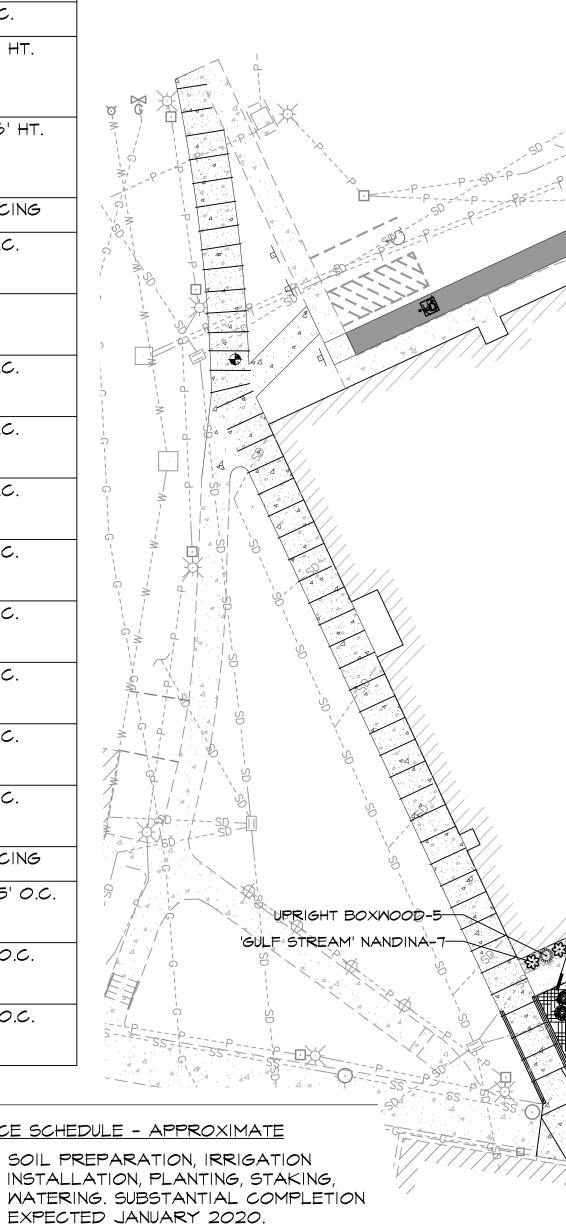
ORIGINAL SHEET SIZE = 24 x 36 HALF SIZE REDUCTIONS = 11 x 17

DATE: 05/02/2018

DESIGN DEVELOPMENT SHEET NO.

L1.01

MATERIAL AND HARDSCAPE PLAN



## SHEET NOTES

- REFER TO DETAILS AND SPECIFICATIONS FOR ADDITIONAL INFORMATION.
- 2. NO PLANT SUBSTITUTIONS SHALL BE PERMITTED WITHOUT PRIOR APPROVAL OF LANDSCAPE ARCHITECT/OWNER.
- 3. ALL WORK SHALL BE PERFORMED TO THE SATISFACTION OF THE LANDSCAPE ARCHITECT/OWNER.
- 4. PLANT LIST QUANTITIES ARE SHOWN FOR REFERENCE ONLY. CONTRACTOR IS RESPONSIBLE FOR VERIFYING ALL QUANTITIES IN LIST WITH ACTUAL PLAN CALL-OUTS, AND INSTALLING PLANTINGS PER THE LANDSCAPE PLAN. GROUNDCOVER QUANTITIES SHALL BE ADJUSTED AS REQUIRED FOR FIELD CONDITIONS AT THE SPECIFIED SPACING.
- 5. ALL PLANT SUBSTITUTIONS WILL BE APPROVED BY THE CITY AND LANDSCAPE ARCHITECT PRIOR TO INSTALLATION AND PLANS UPDATED PLANS SHOWING ACCURATE PLANTING MATERIALS WILL BE PROVIDED TO THE CITY PRIOR TO BUILDING OCCUPANCY.
- 6. THE GEOLOGIC MAP OF THE TUMMATER 7.5-MINUTE QUADRANGLE, THURSTON COUNTY, WASHINGTON (WALSH ET AL. 2003) TO UNDERSTAND THE REGIONAL GEOLOGY IN THE SITE VICINITY. THE GEOLOGIC MAP INDICATES THAT VASHON FINE-GRAINED SEDIMENTS WERE DEPOSITED IN THIS AREA BY GLACIAL LAKE RUSSELL AND OTHER LAKES OF THE VASHON GLACIAL RECESSION. THE FINE-GRAINED DEPOSITS GENERALLY CONSIST OF LACUSTRINE SANDY SILT AND CLAY AND ARE MOST COMMONLY FOUND AT ELEVATIONS BELOW ABOUT ELEVATION 140 FEET (NAVD88) IN THE SOUTH PUGET LOWLAND. GLACIALLY CONSOLIDATED SOILS AT THE SITE ARE MAPPED AS VASHON GLACIAL OUTWASH DEPOSITS CONSISTING OF POORLY TO MODERATELY SORTED SAND AND GRAVEL WITH UNDERLYING LAYERS OF OVERCONSOLIDATED LACUSTRINE SILT AND CLAY.
- SEE SHEET LIO2 FOR COMPLETE PLANT LIST WITH SIZES, QUANTITIES & COST.
- 8. ALL AREAS TO BE PLANTED ARE TO BE MULCHED WITH 4 INCHES ORGANIC MATERIAL.
- 9. LANDSCAPE ARCHITECT SHALL INSPECT THE LANDSCAPING UPON INSTALLATION FOR PLAN COMPLIANCE AND SUBMIT A STATEMENT OF APPROVAL TO THE CITY PRIOR TO BUILDING OCCUPANCY.
- 10. ALL LANDSCAPING AREAS SHALL BE PLANTED TO ACHIEVE 80% PLANT DENSITY WITHIN 3 YEARS OF PLANTING. ADDITIONAL PLANTINGS MAY BE NECESSARY UPON INSPECTION BY THE CITY.

INSTALLATION & MAINTENANCE SCHEDULE - APPROXIMATE

SEPT 2019 - DEC 2019 SOIL PREPARATION, IRRIGATION INSTALLATION, PLANTING, STAKING,

JAN 2020 - MAR 2020 60-DAY MAINTENANCE PERIOD. WEEKLY MAINTENANCE VISITS AND INSPECTION OF

PLANT MATERIAL APR 2020 FINAL PUNCH LIST AND ACCEPTANCE OF

PROJECT EXPECTED

APR-SEPT 2020 MEEKLY MAINTENANCE VISITS

LEAF AND TREE DEBRIS CLEAN-UP AS SEPT - NOV 2020

OCT 2020 - MARCH 2021 MONTHLY FERTILIZE AND PRUNING AS NEEDED

MARCH - SEPT 2021 WEEKLY MAINTENANCE VISITS


SEPT - NOV 2021 LEAF AND TREE DEBRIS CLEAN-UP AS NEEDED

MONTHLY FERTILIZE AND PRUNING AS NEEDED OCT 2021 - MARCH 2022


MARCH - SEPT 2022 WEEKLY MAINTENANCE VISITS

SEPT - NOV 2022 LEAF AND TREE DEBRIS CLEAN-UP AS

OCT 2022 - MARCH 2023 MONTHLY FERTILIZE AND PRUNING AS NEEDED

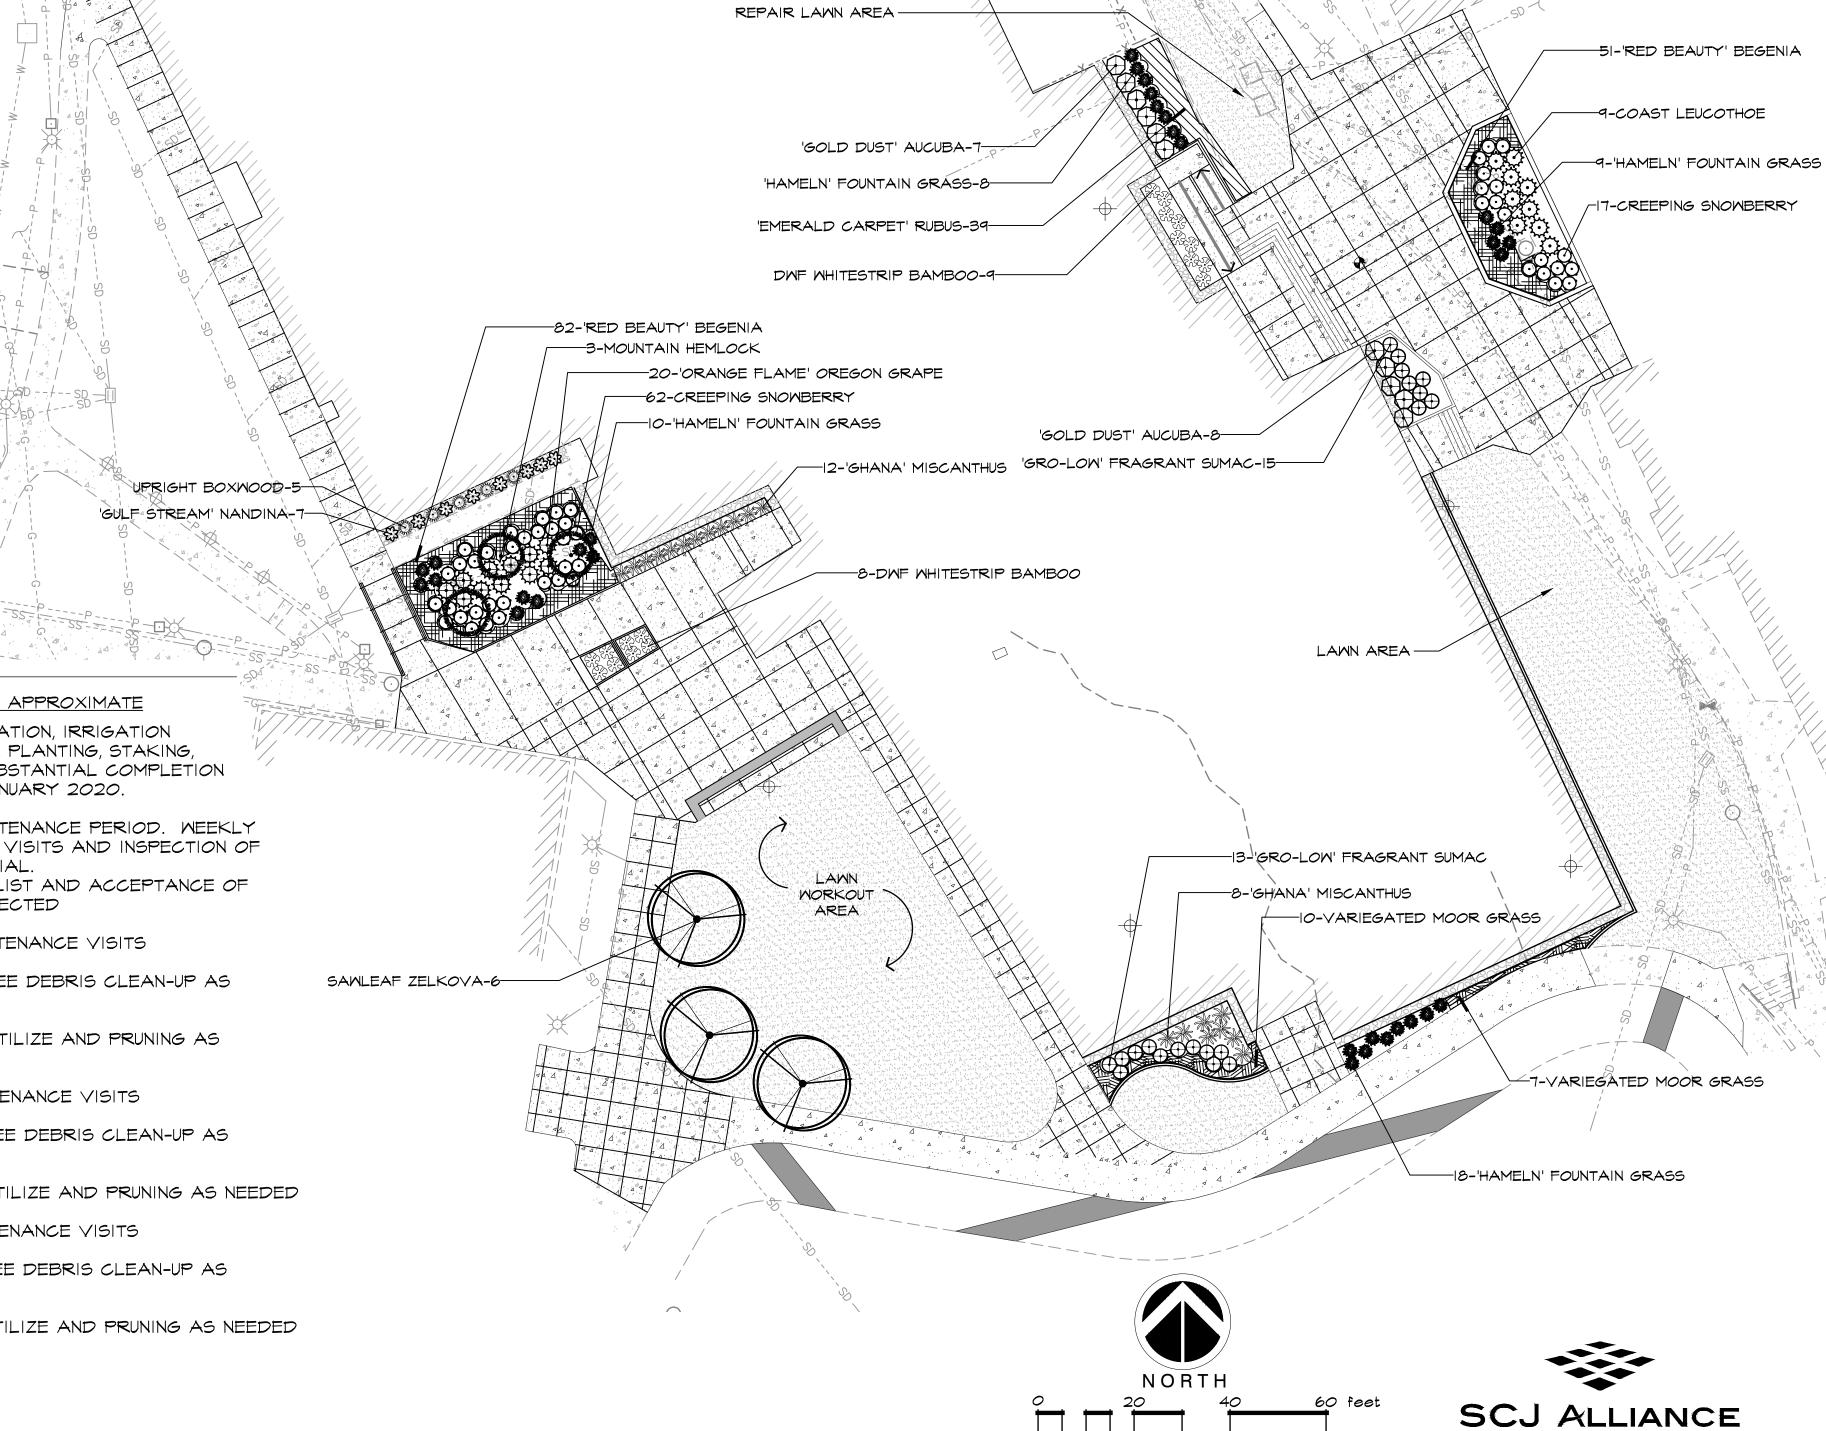

SCALE!" = 20'

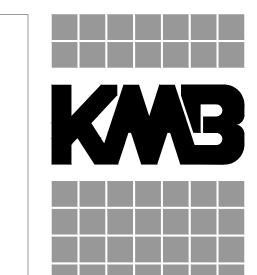

Olympia, Washington 98501

360.352.8883



KMB Project # E1626

## **ADDITION** AND 'ATION OLLEGE 0 CENTER REISOMMUNITY (A 98512 **S** ≥ SOUTH PUGET SOUND 2011 MOTTMAN ROAD SW, OLYMPIA, STATE PROJECT NO. 2018-111A AND

ORIGINAL SHEET SIZE = 24 x 36 HALF SIZE REDUCTIONS = 11 x 17 REVISIONS:

DATE: 05/02/2018 **DESIGN DEVELOPMENT** 

SHEET NO.

**CONSULTING SERVICES** 

8730 TALLON LANE NE, SUITE 200, LACEY, WA 98516

P: 360.352.1465 F: 360.352.1509

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L2.01

LANDSCAPE PLAN


1. CIP CONCRETE SEATWALL WITH LIGHT SANDBLAST FINISH, SMOOTH SACK ALL WALLS PRIOR TO SANDBLASTING. ALL CONCRETE SHALL BE CLASS 3000.

P-SC-SPS-24

P-SC-SPS-27

P-SC-SPS-33

RAISED PLANTER

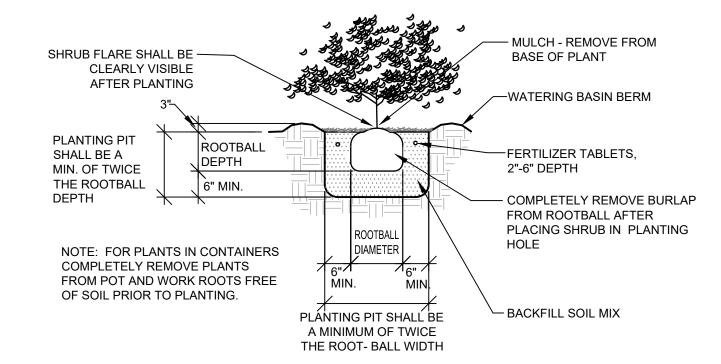

SHRUB PLANTING DETAIL (B&B OR CONT.)

CONTINUOUS OUTER ROW OF PLANTS SPACED

"X" ON CENTER AND SET BACK FROM THE

— AREA FOR SPACING ADJUSTMENT

PLANTING BED EDGE 2/3 "X"

P-SC-SPS-14

P-SC-SPS-26

- 1" CHAINLOCK TREE TIES (2)-BVC WOOD TREE STAKES (8' - 4" MULCH IN BASIN 3" WATER RETENTION BASIN (IN SHRUB AND GROUNDCOVER AREAS FERTILIZER TABLETS COMPLETELY REMOVE BURLAP FROM ROOT BALL. — BACKFILL SOIL MIX ROOT 1. REMOVE TREATED OR SYNTHETIC WIDTH BURLAP COMPLETELY. 2. INSTALL 24" DEPTH ROOT BARRIER AT PLANTING P THE EDGE OF ANY PAVING WITHIN 8 FT. SHALL BE A MIN. OF OF TREE TRUNK.

3. ENSURE THE TRUNK FLARE IS VISIBLE

ABOVE GRADE AFTER PLANTING.

— EDGE OF PLANTING BED TRIANGULAR SPACING WITHIN -PLANTING BED


> SPECIFIED PLANT SPACING="X" INDIVIDUAL PLANTS REPRESENTED AS: +


TREE PLANTING & STAKING DETAIL

3X THE

ROOTBALL WIDTH

PLANT SPACING DETAIL

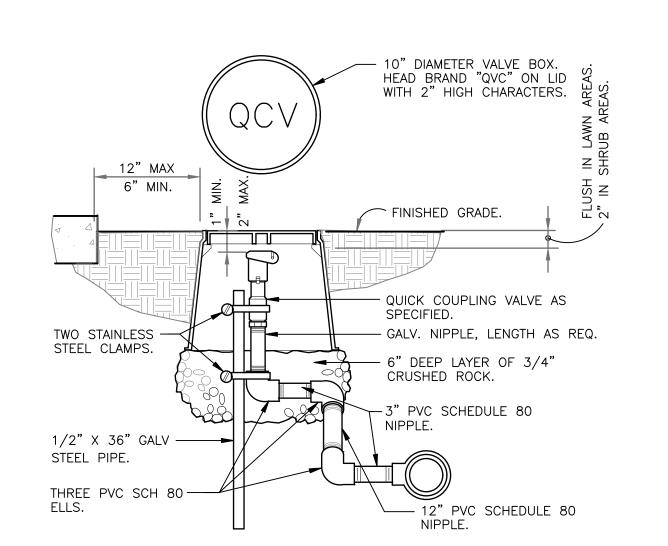

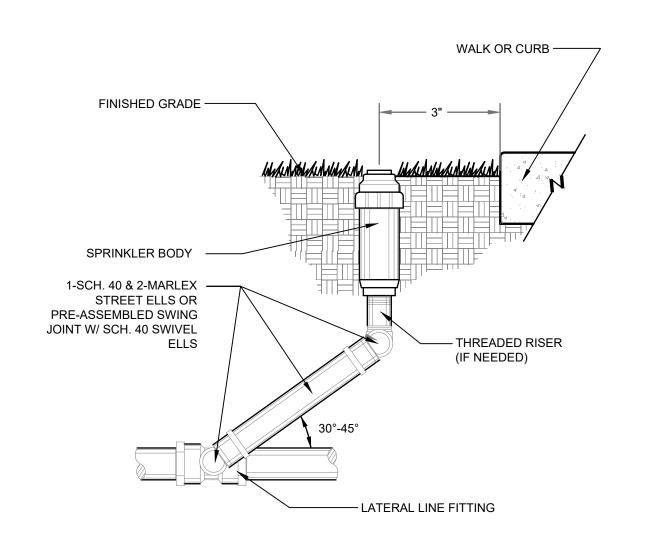

QUICK COUPLING VALVE IN BOX 1 1/2" = 1'-0"

POP-UP SPRINKLER HEAD 6

P-SC-SPS-35

## LANDSCAPE SPECIFICATIONS

- REFER TO DETAILS FOR ADDITIONAL INFORMATION.
- CHEMICALLY KILL (CHEMICALS MUST MEET WELL HEAD PROTECTION AREAS MINIMUM MITIGATION STANDARDS-SEE THURSTON COUNTY'S INTEGRATED PEST MANAGEMENT PROGRAM) AND REMOVE FROM SITE ALL EXISTING WEEDS AND VEGETATION NOT SHOWN TO REMAIN ON PLANS.
- 3. DISTRIBUTE IMPORTED SANDY LOAM TOPSOIL (APPROVED BY THE LANDSCAPE ARCHITECT) IN AREAS SHOWN AND AT DEPTHS INDICATED FOR CROWNING AND BERMING OF LANDSCAPE AREAS AND BACKFILL OF RETAINING WALLS (IF REQUIRED). DOTTED LINES INDICATE I' CONTOUR INTERVALS. ALL LANDSCAPE AREAS SHALL RECEIVE TOPSOIL, WHETHER INDICATED ON PLANS OR NOT, SO THAT FINISH GRADES OF ALL SHRUB BEDS SHALL BE 2" BELOW TOPS OF ADJACENT CURBS AND PAVEMENT. STRUCTURAL FILL AREAS: ANY LANDSCAPE AREAS OCCURRING WITHIN STRUCTURAL FILL ZONES SHALL HAVE SAID STRUCTURAL FILL MATERIALS EXCAVATED TO A DEPTH OF 12" BELOW FINISH GRADES IN SHRUB AREAS AND 6" BELOW GRADE IN LAWN AREAS AND REPLACED WITH SPECIFIED TOPSOIL. DISPOSE OF EXCAVATED MATERIAL OFF SITE.
- FINE GRADE ALL LANDSCAPE BEDS PRIOR TO PLANTING OPERATIONS. ALL NON-COMPOSTABLE MATERIALS SHALL BE REMOVED BY HAND AFTER APPLICATION.
- NO PLANT SUBSTITUTIONS SHALL BE PERMITTED WITHOUT PRIOR APPROVAL OF LANDSCAPE ARCHITECT AND CITY. ALL PLANT SUBSTITUTIONS WILL BE APPROVED BY THE CITY AND LANDSCAPE ARCHITECT PRIOR TO INSTALLATION. UPDATED PLANS SHOWING ACCURATE PLANTING MATERIALS WILL BE PROVIDED TO THE CITY PRIOR TO BUILDING OCCUPANCY
- 6. ALL PLANTS SHALL CONFORM TO THE LATEST EDITION OF THE AMERICAN STANDARD FOR NURSERY STOCK
- 7. ALL PLANT MATERIALS AND PLANT LOCATIONS SHALL BE APPROVED BY THE LANDSCAPE ARCHITECT PRIOR TO INSTALLATION. ALL PLANTS SHALL BE THOROUGHLY WATERED IMMEDIATELY AFTER PLANTING WITH ALASKA FISH FERTILIZER SOLUTION.
- ROOT BARRIER SHALL BE INCORPORATED ADJACENT AND PARALLEL TO PAVING, CURB AND SIDEWALK, A MINIMUM OF 15 LINEAR FEET (7.5' ON EITHER SIDE OF TRUNK), 24" DEEP, WHERE ANY TREE IS WITHIN 8' OF PAVING, CURB OR SIDEWALK. ROOT BARRIER SHALL BE DEEPROOT UB-24 AS AVAILABLE FROM EWING IRRIGATION PRODUCTS, 2901 S TACOMA WAY, TACOMA, WA 98409 (253) 476-9530 OR APPROVED EQUAL
- 9. SOIL AMENDMENT FOR SOIL PREPARATION AND PLANTING BACKFILL SHALL BE A SCREENED 5/8" MINUS NITRIFIED WOOD RESIDUAL COMPOST EQUAL TO:
  - "TOP GRADE COMPOST" BRAND COMPOST AS AVAILABLE FROM SILVER SPRINGS ORGANICS, RAINIER, WA (360) 446-7645.
  - "CEDAR GROVE COMPOST" BRAND COMPOST AS AVAILABLE FROM CEDAR GROVE COMPOST, MAPLE VALLEY, WA (877) 764-5748.
  - PREP/LRI COMPOST AS AVAILABLE FROM RANDLES SAND AND GRAVEL, INC., PUYALLUP, WA (253) 537-6828.

ALL NON-COMPOSTABLE MATERIALS WILL BE REMOVED FROM SITE

- 10. SOIL PREPARATION (ALL LANDSCAPE AREAS) FOR PLANTING BEDS SPREAD 24 C.Y. OF SPECIFIED TOPSOIL MIX PER 1000 S.F AND AMEND TO A SETTLED DEPTH OF 12" (INCHES). TOPSOIL MIX SHALL CONTAIN 35-40% COMPOST BY VOLUME. SPREAD 150 LBS./1000 S.F. OF AGRICULTURAL GYPSUM AND I LBS./1000 S.F OF 16-8-8 COMMERCIAL FERTILIZER OVER SOIL AMENDMENT. ROTO-TILL ALL OF THE ABOVE TO A 6"-8" DEPTH AND GRADE SMOOTH, COMPACTING AS REQUIRED AND REMOVING ALL ROCKS, CLODS AND DEBRIS. PRIOR TO PLANTING SOILS AND PLANTS SHALL BE INSPECTED BY THE CITY.
- BACKFILL MIX FOR ALL PLANTS SHALL BE A BLEND OF 1/3 EXISTING SITE SOIL, I/3 COARSE SAND, AND I/3 SOIL AMENDMENT SPECIFIED IN NO. 9.
- 12. ONLY SLOW RELEASE FERTILIZERS SHALL BE APPLIED FOR THE LIFE OF THE DEVELOPMENT AT A MAXIMUM AMOUNT OF 4 LBS OF NITRATE AS NITROGEN ANNUALLY AND NO MORE THAN I LB PER APPLICATION FOR EVERY 1,000 SQUARE FEET OF TURF GRASS. ONLY FERTILIZER FORMULAS WITH A MINIMUM OF 50 PERCENT WATER INSOLUBLE FORM OF NITROGEN ARE PERMITTED FOR USE APPROVED WATER INSOLUBLE FORMS OF NITROGEN INCLUDE SULFUR AND/OR POLYMER COATED FERTILIZERS, ISOBUTYLIDENE DIUREA (IBDU), METHYLENE UREA AND UREAFORM, AND ORGANIC FERTILIZERS REGISTERED WITH WASHINGTON DEPARTMENT OF AGRICULTURE."

APPLY OSMOCOTE 18-6-12, 9 MONTH SLOW RELEASE FERTILIZER OVER THE SURFACE OF ALL PLANT PITS AT THE FOLLOWING RATES (NO MORE THAN A MAXIMUM 4LBS. OF NITRATE NITROGEN SHALL BE USED ANNUALLY):

2 CUPS TREES OVER 10' HEIGHT I CUP TREES UNDER 10' HEIGHT: ALL SHRUBS EXCEPT | GALLONS: 1/2 CUP 1/4 CUP I GALLON PLANTS: GROUND COVERS: 1/4 CUP

- FERTILIZER TABLETS FOR ALL PLANTS SHALL BE AGRIFORM (20-10-5) 21 GRAM OR 10 GRAM TABLETS DISTRIBUTED AS FOLLOWS: ALL TREES: 4-21 GRAM TABLETS, ALL SHRUBS (EXCEPT | GALLONS): 3-2| GRAM TABLETS, ALL | GALLONS: 1-2| GRAM TABLET, ALL 2-1/4" AND 4" POT GROUND COVERS: 1-10 GRAM TABLET EACH. SET TABLETS DIRECTLY NEXT TO ROOTBALL
- PRIOR TO PLACING MULCH CONTRACTOR SHALL CALL FOR AND HAVE THE CITY INSPECT ALL PLANT MATERIAL. ALL SHRUB AND GROUND COVER BEDS SHALL RECEIVE A 4" DEPTH "MEDIUM/ FINE GRIND" HEM/FIR BARK MULCH AS TOP DRESSING. MULCH SHALL BE PULLED AWAY FROM THE BASE OF ALL SHRUBS AND GROUNDCOVER.
- APPLY A GRANULAR PRE-EMERGENT HERBICIDE TO ALL SHRUB AND GROUNDCOVER BEDS AT THE CONCLUSION OF THE MAINTENANCE PERIOD. DO NOT USE CASARON OR NORASAC BRANDS. ALL FERTILIZER MUST COMPLY TO MEET WELL HEAD PROTECTION AREAS MINIMUM MITIGATION STANDARDS [OMC 18.32.225(A)(2)(A)]
- ALL PLANT SUBSTITUTIONS WILL BE APPROVED BY THE CITY AND LANDSCAPE ARCHITECT PRIOR TO INSTALLATION. UPDATED PLANS SHOWING ACCURATE PLANTING MATERIALS WILL BE PROVIDED TO THE CITY PRIOR TO BUILDING OCCUPANCY.
- ALL PLANTS SHALL BE GUARANTEED FOR ONE (1) YEAR FROM DATE OF PROJECT ACCEPTANCE. ALL REPLACED PLANTS SHALL BE RE-GUARANTEED. ALL REPLACEMENTS SHALL BE MADE WITHIN 21 DAYS OF RECEIVING WRITTEN NOTICE FROM THE OWNER. CONTRACTOR SHALL NOT BE RESPONSIBLE FOR PLANTS DYING DUE TO OWNER NEGLECT OR VANDALISM, AFTER THE MAINTENANCE PERIOD.
- PLANT LIST QUANTITIES ARE SHOWN FOR REFERENCE ONLY. CONTRACTOR IS RESPONSIBLE FOR VERIFYING ALL QUANTITIES IN LIST WITH ACTUAL PLAN CALL-OUTS, AND INSTALLING PLANTINGS PER THE LANDSCAPE PLAN. GROUNDCOVER AND/OR MASS SHRUB QUANTITIES SHALL BE ADJUSTED AS REQUIRED FOR FIELD CONDITIONS AT THE SPECIFIED SPACING.
- 20. FINAL INSPECTION SHALL OCCUR AT THE CONCLUSION OF A 60-DAY MAINTENANCE PERIOD. MAINTENANCE PERIOD SHALL COMMENCE UPON COMPLETION OF ALL LANDSCAPE INSTALLATION ACTIVITIES AND SHALL INCLUDE THE FOLLOWING:
  - REMOVE ALL WEEDS OVER I" IN HEIGHT, REFER TO THE THURSTON COUNTY'S IPMP FOR ADDITIONAL REQUIREMENTS.
  - REPLACE DEAD OR UNHEALTHY PLANTS
- ENSURE PROPER FUNCTION OF IRRIGATION SYSTEM, SEE OMC 18.32.225.A.2(C) FOR ADDITIONAL REQUIREMENTS.
- ENSURE ADEQUATE MOISTURE IS DELIVERED TO ALL LANDSCAPE BEDS INCLUDING NON-IRRIGATED AREAS.
- FERTILIZE ALL LAWNS AT CONCLUSION OF MAINTENANCE PERIOD, SEE OMC 18.32.225.A.2(A) FOR ADDITIONAL REQUIREMENTS.
- 21. ALL APPLICATIONS OF FERTILIZERS AND CHEMICALS SHALL BE RE-EVALUATED PRIOR TO ACTUAL LANDSCAPE INSTALLATION AND MAINTENANCE.



8730 TALLON LANE NE, SUITE 200, LACEY, WA 98516 P: 360.352.1465 F: 360.352.1509 SCJALLIANCE.COM

906 Columbia Street SW, Suite 400

Olympia, Washington 98501

360.352.8883



**ADDITION** AND ATION LEGE 0 0

OMMUNITY (A 98512  $\Delta$ ENTER <u>U</u> C SW, OLYMPIA, 118-111A WELLNES FT SOUND E PROJECT NO. 201 **OUTH PUGET** AND

ORIGINAL SHEET SIZE = 24 x 36 **HALF SIZE REDUCTIONS = 11 x 17** REVISIONS:

**SOU** 2011 N STATE |


DATE: 05/02/2018 **DESIGN DEVELOPMENT** 


SHEET NO.


L2.02

LANDSCAPE DETAILS AND SPECIFICATIONS

	MANUFACTURER/MODEL/DESCRIPTION	PSI	DETAIL
	HUNTER PROS-04-CV 10' RADIUS	30	6/WI;L2.02
<b>(a)</b> (a) (a) (a) (b) (a) (a) (b) (a) (a) (a) (a) (a) (a) (a) (a) (a) (a	TURF SPRAY, 4.0" POP-UP. WITH DRAIN  CHECK VALVE. CO-MOLDED WIPER		
<b>4</b>	SEAL WITH UV RESISTANT MATERIAL.		
		120	6/011200
	HUNTER PROS-04-CV 12' RADIUS	30	6/WI;L2.02
	TURF SPRAY, 4.0" POP-UP. WITH DRAIN    CHECK VALVE. CO-MOLDED WIPER		
	SEAL WITH UV RESISTANT MATERIAL.		
	HUNTER PROS-04-CV 15' RADIUS	30	6/WI;L2.02
	TURE SPRAY, 4.0" POP-UP. WITH DRAIN	150	6/M1;L2.02
	CHECK VALVE. CO-MOLDED WIPER		
	SEAL WITH UV RESISTANT MATERIAL.		
	HUNTER PROS-04-CV 17' RADIUS	30	6/WI;L2.02
<b>AAA</b>	TURE SPRAY, 4.0" POP-UP. WITH DRAIN		0//1;12.02
<b>172 172 172 172 172 172 172 172 172 172 </b>	CHECK VALVE. CO-MOLDED WIPER		
	SEAL WITH UV RESISTANT MATERIAL.		
	HUNTER PROS-04-CV ADJ	30	6/WI;L2.02
9 6 8 6 6 6 6	TURE SPRAY, 4.0" POP-UP. WITH DRAIN		0//N;L2.02
WUWWOO	CHECK VALVE. CO-MOLDED WIPER		
	SEAL WITH UV RESISTANT MATERIAL.		
SYMBOL		+	DETAIL
DT MDOL	MANUFACTURER/MODEL/DESCRIPTION		DETAIL
	HUNTER PCZ-IOI-25		6/L3.02
	DRIP CONTROL VALVE KIT. I" PGV		0,20.02
	GLOBE VALVE WITH I" HY100 FILTER		
	SYSTEM. PRESSURE REGULATION: 25PSI.		
	FLOW RANGE: 0.5 GPM TO 15 GPM. 150		
	MESH STAINLESS STEEL SCREEN.		
	TECHLINE START CONNECTION	+	7/L3.02
	LATERAL TO DRIP ZONE TUBING WITH		1/25.02
	SMING JOINT ASSEMBLY		
		+	F/1000
	AREA TO RECEIVE DRIPLINE		5/L3.02
	NETAFIM TLCV-06-18		
	TECHLINE PRESSURE COMPENSATING		
	LANDSCAPE DRIPLINE WITH CHECK		
	VALVE. 0.6 GPH EMITTERS AT 18" O.C.		
	DRIPLINE LATERALS SPACED AT 18"		
	APART, WITH EMITTERS OFFSET FOR		
	TRIANGULAR PATTERN. 17MM.		
SYMBOL	MANUFACTURER/MODEL/DESCRIPTION		DETAIL
	HUNTER ICY-6		2/L3.02
	I", I-I/2", 2", AND 3" PLASTIC ELECTRIC		2/15.02
$\langle \rangle$	REMOTE CONTROL VALVES, GLOBE		
	CONFIGURATION, WITH NPT THREADED		
	INLET/OUTLET, FOR		
	COMMERCIAL/MUNICIPAL USE.		
			F /\4\\\\ \ \ \ \ \ \ \ \ \ \ \ \ \ \ \ \
	HUNTER HQ-33DRC QUICK COUPLER VALVE, YELLOW		5/WI;L2.02
	RUBBER COVER, RED BRASS AND		
	STAINLESS STEEL, WITH 3/4" NPT INLET,		
	2-PIECE BODY.		
_	MATCO-NORCA 759		3/L3.02
¥	BRASS SHUT OFF BALL VALVE, 1/2" TO		
	4". TWO PIECE BODY, BLOW-OUT PROOF		
	STEM, CHROME PLATED SOLID BRASS		
	BALL, THREADED, WITH PTFE SEATS.		
	SAME SIZE AS MAINLINE PIPE.		
	DRAIN VALVE		8/L3.02
(D)	WILKINS #200 3/4" ANGLE VALVE FOR		
	MANUAL DRAIN VALVE ASSEMBLY W/		
	KEY EXTENSION		
	FEBCO 850 I"		I/L3.02
(BF)	DOUBLE CHECK BACKFLOW PREVENTION,		
	1/2" TO 2"		
	HUNTER PC-400 WITH (02) PCM-300	+	
С	LIGHT COMMERCIAL & RESIDENTIAL		
$\subseteq$	CONTROLLER, IO-STATION EXPANDED		
	MODULE CONTROLLER, 120 VAC,		
	OUTDOOR MODEL		
	HUNTER WSS-SEN	+	
<u> </u>	HUNTER MSS-SEN   WIRELESS SOLAR, RAIN FREEZE SENSOR		
(SS)	MIRELESS SOLAR, RAIN FREEZE SENSOR   WITH OUTDOOR INTERFACE, CONNECTS		
	TO HUNTER X-CORE AND ACC		
	CONTROLLERS, INSTALL AS NOTED.		
	INCLUDES GUTTER MOUNT BRACKET.		
	MODULE NOT INCLUDED.		
		+	
	WATER METER I"		
M	SYSTEM DESIGNED AT XX PSI, FIELD		
	VERIFY EXACT PRESSURE ON SITE		
	IRRIGATION LATERAL LINE: PVC CLASS 200 SDR 21		
	12" BELOW GRADE, 24" BELOW PAVED		
	AREAS		
<del></del>	IRRIGATION MAINLINE: PVC SCHEDULE 40	T	
	18" BELOW GRADE, 24" BELOW PAVED		
	AREAS		
	PIPE SLEEVE: PVC CLASS 200 SDR 21		

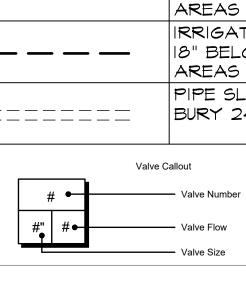

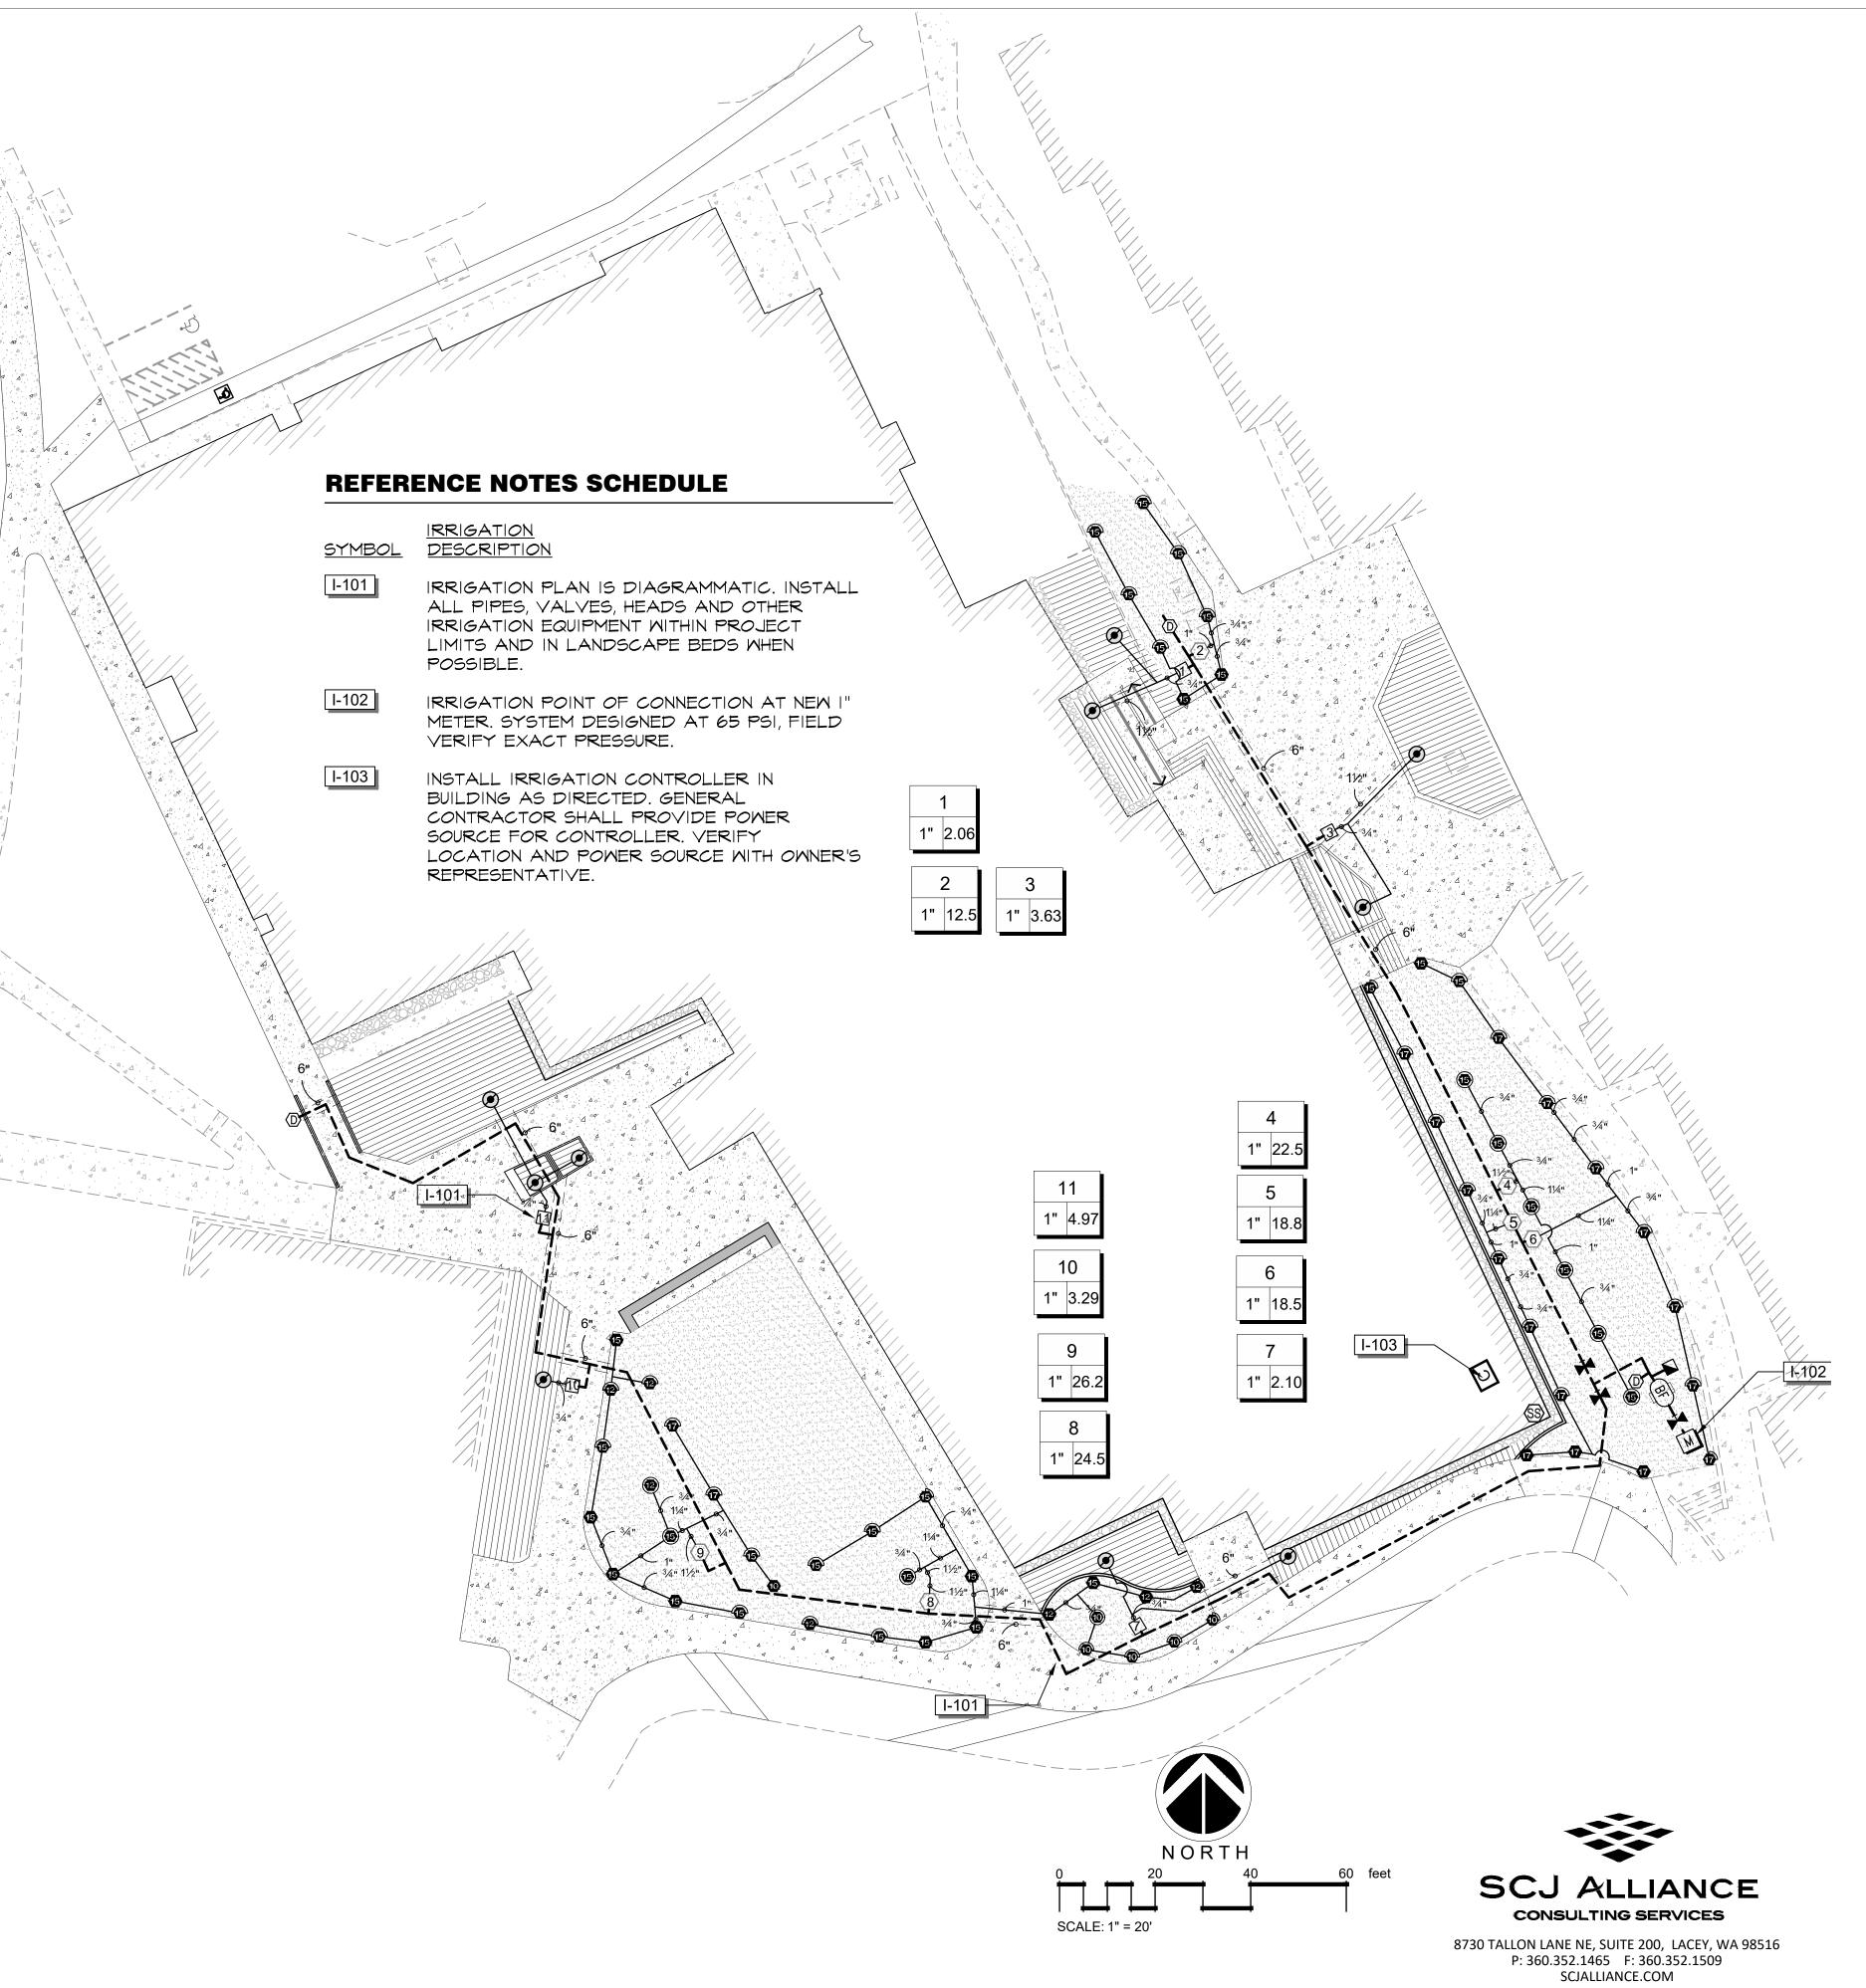

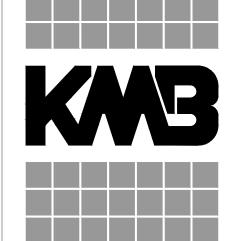




# NOVATION AND ADDITION COLLEGE S CENTER REN COMMUNITY C SOUTH PUGET SOUND 2011 MOTTMAN ROAD SW, OLYMPIA, STATE PROJECT NO. 2018-111A

ORIGINAL SHEET SIZE = 24 x 36 HALF SIZE REDUCTIONS = 11 x 17

DATE: 05/02/2018

DESIGN DEVELOPMENT

L3.01 IRRIGATION PLAN

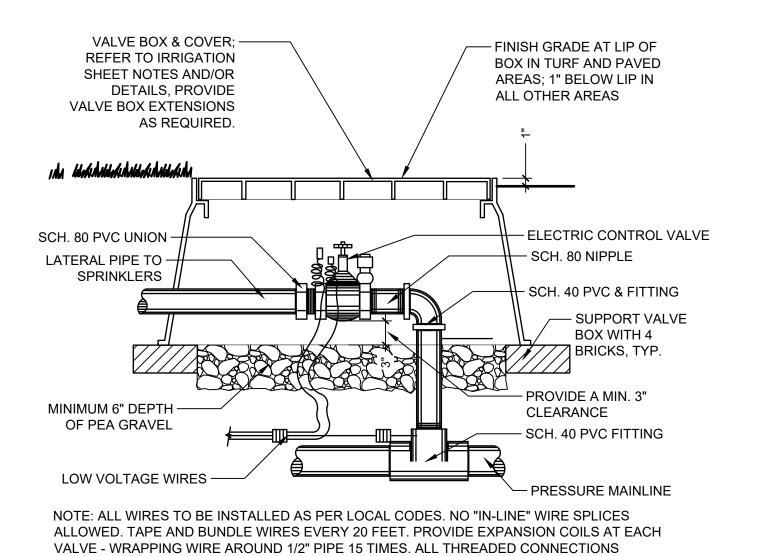

SET BOX 2" ABOVE GRADE AT SHRUBS.— 10" DIAMETER ROUND VALVE L BOX, SEE SPECIFICATIONS. SET BOX FLUSH TO GRADE AT LAWN. — FINISH GRADE. | FOUR COMMON BRICK SUPPORTS. | 10" DIA. PVC PIPE EXTENSION, LENGTH AS REQUIRED. ISOLATION VALVE AS PVC MAIN LINE. SPECIFIED. — SLIP/THREAD COUPLING. 6" SCHEDULE 80 THREADED


VALVE BOX & COVER; - FINISH GRADE AT LIP OF REFER TO IRRIGATION **BOX IN TURF AND PAVED** SHEET NOTES AND/OR AREAS; 1" BELOW LIP IN DETAILS, PROVIDE ALL OTHER AREAS VALVE BOX EXTENSIONS AS REQUIRED. i da diski dalikaki - ELECTRIC CONTROL VALVE SCH. 80 PVC UNION -- SCH. 80 NIPPLE LATERAL PIPE TO **SPRINKLERS** SCH. 40 PVC & FITTING — SUPPORT VALVE **BOX WITH 4** BRICKS, TYP. PROVIDE A MIN. 3" MINIMUM 6" DEPTH -CLEARANCE OF PEA GRAVEL - SCH. 40 PVC FITTING LOW VOLTAGE WIRES


NOTE: ALL WIRES TO BE INSTALLED AS PER LOCAL CODES. NO "IN-LINE" WIRE SPLICES ALLOWED. TAPE AND BUNDLE WIRES EVERY 20 FEET. PROVIDE EXPANSION COILS AT EACH VALVE - WRAPPING WIRE AROUND 1/2" PIPE 15 TIMES. ALL THREADED CONNECTIONS SHALL BE MADE WITH TEFLON TAPE.

**ELECTRONIC CONTROL VALVE** 

P-SC-SPS-17

P-SC-SPS-15 CONTROLLER WIRE WITH 30 INCH LINEAR LENGTH OF COIL, WITH PLASTIC I.D. TAG AND WATERPROOF CONNECTORS

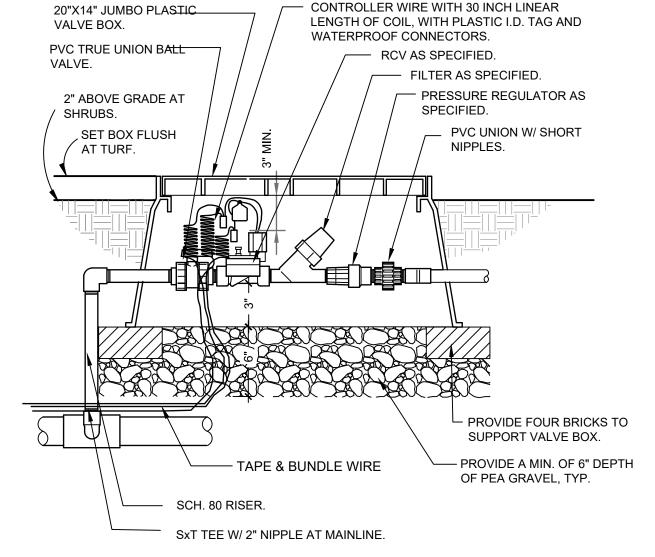

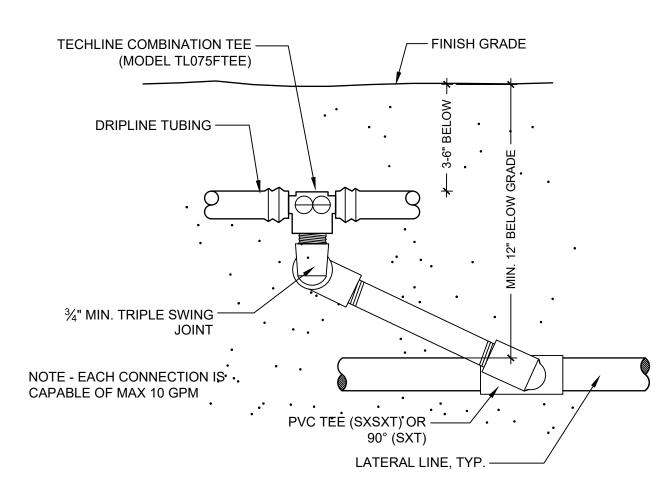

TECHLINE CV LITE IRREGULAR AREAS

12" MIN.

MANUAL DRAIN VALVE DETAIL

-FINISH GRADE

- CHAMPION #200-075 (OR EQ.)

BRASS ANGLE VALVE WITH

UNION. INSTALL AT ALL

FACILITATE COMPLETE

MAINLINE DRAINAGE.

MAINLINE LOW POINTS TO

P-SC-SPS-22

-CENTER FEED LITE LAYOUTS ALLOW 2X MAX TUBING LENGTH

BELOW ARE MAX LINEDISTANCE FOR CENTER FEED LITE

LAYOUT @ 57 PSI INLET; REFER TO FULL CHART FOR

.26 @ 12" o.c. = 1,310' | .4 @ 12" o.c. = 960'

.26 @ 18" o.c. = 1,864' | .4 @ 18" o.c. = 1368'

RAINBIRD #63100

VALVE MARKER

2" PVC SLEEVE

REDUCING TEE -

3/4" CLOSE NIPPLE

3/4" X 3" PROTECTIVE

**PVC NIPPLE** 

**GRAVEL SUMP** (2 CU. FT.)

MAIN LINE

OF STANDARD LAYOUTS.

ALTERNATE PRESSURES:

-CHECK VALVE HOLDS BACK 4.6' OF WATER

DRIP VALVE/FILTER/REGULATOR

**BRASS ISOLATION VALVE** 

P-SC-SPS-12

P-SC-SPS-18

TECHLINE START CONNECTION (SWING JOINT RISER)

P-SC-SPS-20

## **IRRIGATION SPECIFICATIONS**

- THIS PLAN IS DIAGRAMMATIC; ALL PIPING, VALVES, ETC. SHALL BE INSTALLED IN SHRUB BEDS WHERE POSSIBLE AND SHALL FOLLOW THE PLAN AS CLOSE AS IS PRACTICAL.
- 2. LOCATE ALL MAINLINES WITHIN THE PROJECT LIMITS.

SHALL BE MADE WITH TEFLON TAPE.

**ELECTRONIC CONTROL VALVE** 

REFER TO START CONNECTION DETAIL

PERIMETER LATERALS 2" TO 4" FROM EDGE, TYP.

REMOTE CONTROL VALVE WITH -

DISC FILTER AND PRV.

3/4" MIN PVC TO CONNECTION;

SIZE BASED UPON OVERALL

SYSTEM DEMAND, SEE PLAN.

- PIPE SIZES ARE CONSTANT BETWEEN PIPE SIZE CALL-OUTS. ALL LATERIAL PIPES SHALL BE INSTALLED AT 12" DEPTH AND 24" DEPTH UNDER PAVED AREAS. MAIINLINE PIPE SHALL BE INSTALLED AT 18" BELOW GRADE AND 24"
- 4. REFER TO DETAILS FOR ADDITIONAL INFORMATION.
- ALL PIPING AND WIRING UNDER PAVED AREAS SHALL BE HOUSED IN CLASS 200 PVC SLEEVES INSTALLED AT A 24" DEPTH. SIZE SLEEVES AS NEEDED TO ACCOMMODATE PIPE AND WIRES, UNLESS OTHERWISE SPECIFIED ON
- CONTRACTOR SHALL MAKE FIELD ADJUSTMENTS AS NEEDED TO OBTAIN FULL COVERAGE. LANDSCAPE ARCHITECT RESERVES THE RIGHT TO MAKE NOZZLE CHANGES AS NEEDED AT NO ADDITIONAL COST. ADJUST HEAD POSITIONS AND ADD OR DELETE HEADS AS NEEDED DEPENDING ON ACTUAL FIELD CONDITIONS.
- 7. ALL MANUAL, GATE AND ELECTRICAL VALVES AND OTHER UNDERGROUND EQUIPMENT SHALL BE HOUSED IN NELSON, AMETEK OR EQUAL RECTANGULAR VALVE BOXES.
- NO IN-LINE WIRE SPLICES ALLOWED. SUPPLY VALVE BOXES AT ALL ELECTRICAL JUNCTIONS. TAPE AND BUNDLE WIRES EVERY 25 LINEAR FEET.
- CONTRACTOR IS RESPONSIBLE FOR COMPLETE SYSTEM DRAINAGE. INSTALL KING BROS. 1/2" AUTOMATIC DRAIN VALVES AT LATERAL LINE LOW POINT(S). INSTALL MANUAL DRAINS AT ALL MAINLINE LOW POINT(S) AND WHERE INDICATED ON PLAN. CONTRACTOR SHALL PROVIDE ADJUSTABLE CHECK VALVES ON ANY IRRIGATION HEAD THAT EXPERIENCES LOW HEAD DRAINAGE.
- IO. ALL THREADED PIPE CONNECTIONS SHALL BE MADE USING TEFLON TAPE WRAPPED AT LEAST THREE TIMES AROUND
- ALL GATE AND ELECTRIC VALVES SHALL BE INSTALLED WITH UNIONS ON THE DOWNSTREAM END OF THE VALVE (REFER TO DETAILS).
- 12. ALL PIPE SHALL HAVE A FIRM UNIFORM BEARING FOR THE ENTIRE LENGTH OF EACH LINE, FREE OF ROCKS OR

- DEBRIS. ALL TRENCHES CONTAINING PIPE AND/OR WIRES SHALL BE BACKFILLED WITH CLEAN TOPSOIL, FREE OF
- ALL LUMBER, RUBBISH AND ROCKS OVER I" IN SIZE, OR CLEAN SAND IF CLEAN TOPSOIL IS NOT AVAILABLE. 13. CONTRACTOR SHALL PROVIDE OWNER WITH ONE SET OF AS-BUILT RECORD DRAWINGS SHOWING EXACT ACTUAL LOCATIONS OF ALL SPRINKLER EQUIPMENT. CONTRACTOR SHALL ORIENT OWNER WITH COMPLETE SYSTEM AND CONTROLLER OPERATIONS, AND WINTERIZATION PROCEDURES.
- CONTRACTOR SHALL SUPPLY AND INSTALL ALL EQUIPMENT SHOWN ON THE PLANS AND INDICATED IN THE SPECIFICATIONS TO ACHIEVE PROPER OPERATION OF SAID EQUIPMENT. ALL EQUIPMENT INSTALLATIONS, ELECTRICAL AND PLUMBING CONNECTIONS SHALL BE IN CONFORMANCE WITH ALL APPLICABLE CODES AND ORDINANCES, THESE SPECIFICATIONS, AND THE MANUFACTURERS RECOMMENDATIONS WHETHER INDICATED ON THE
- CONTRACTOR SHALL INCLUDE IN HIS BID ONE FALL WINTERIZATION AND ONE SPRING ACTIVATION OF IRRIGATION SYSTEM. THESE ACTIVITIES SHALL BE INCLUDED AS PART OF OWNER ORIENTATION PROCEDURES. ANY DAMAGE TO THE IRRIGATION SYSTEM OR THE LANDSCAPE AS A RESULT OF FAILURE TO COMPLY WITH THESE REQUIREMENTS SHALL BE THE SOLE RESPONSIBILITY OF THE CONTRACTOR.
- 16. CONTRACTOR SHALL GUARANTEE IN WRITING ON HIS COMPANY LETTERHEAD ALL MATERIALS AND WORKMANSHIP FOR A PERIOD OF ONE FULL YEAR FOLLOWING ACCEPTANCE OF SYSTEM INSTALLATION.
- 17. BACKFLOW PREVENTOR SHALL BE INSPECTED AND TESTED BY A CERTIFIED BACKFLOW DEVICE INSPECTOR. PROVIDE OWNER WITH ONE COPY OF APPROVAL CERTIFICATE.



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05/02/2018 **DESIGN DEVELOPMENT** SHEET NO. L3.02

**IRRIGATION** 

**DETAILS** 

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Olympia, Washington 98501

360.352.8883

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**OUTH PUGET** 

ORIGINAL SHEET SIZE = 24 x 36

HALF SIZE REDUCTIONS =  $11 \times 17$ 

REVISIONS:

SW, OLYMPIA, 18-111A

OVATION ,





Bergenia cordifolia 'Red Beauty'



Aucuba japonica 'Gold Dust'




Leucothoe axillaris



Mahonia aquifolium 'Orange Flame'



Symphoricarpos mollis

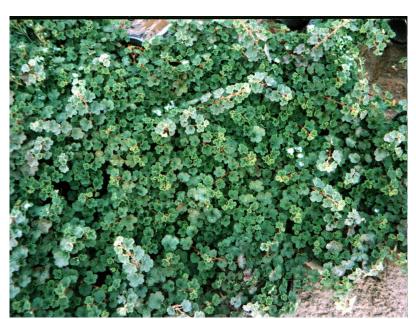

Rubus calycinoides 'Emerald Carpet'



Miscanthus sinensis 'GHANA'



Molinia caerulea 'Variegata'



Rhus aromatica 'Gro-Low'



Zelkova serrata 'Green Vase'



Tsuga mertensiana



Buxus sempervirens 'Fastigiata'




8730 TALLON LANE NE, SUITE 200, LACEY, WA 98516 P: 360.352.1465 F: 360.352.1509 SCJALLIANCE.COM architects
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Olympia, Washington 98501
360.352.8883


DATE: 05/02/2018
DESIGN DEVELOPMENT


L2.03

PLANT PHOTOS



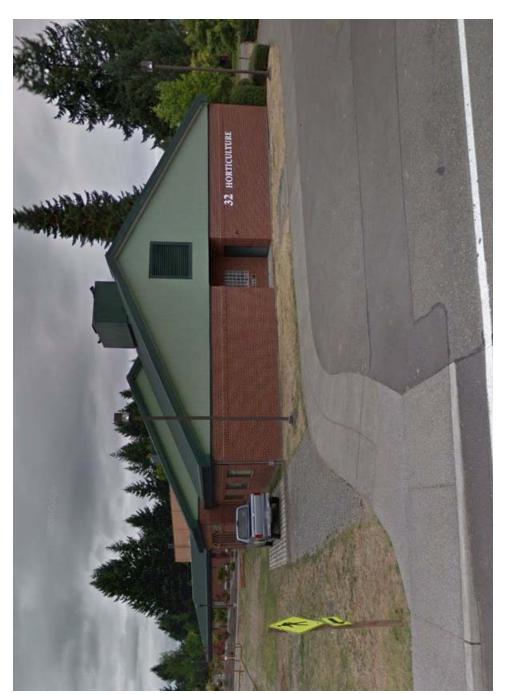


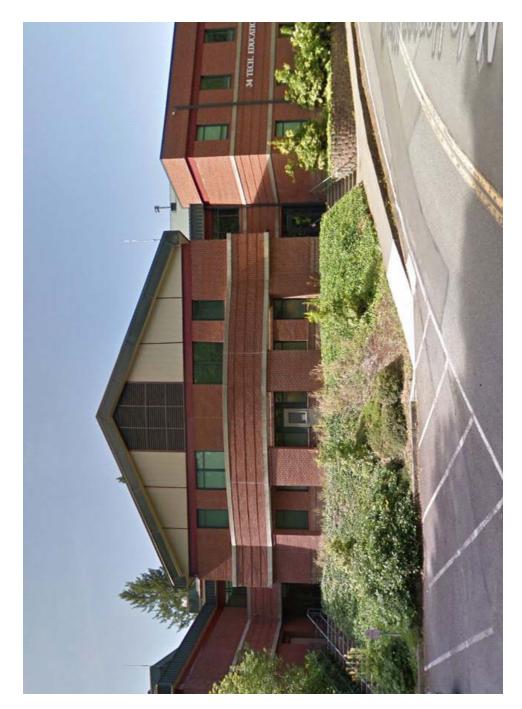

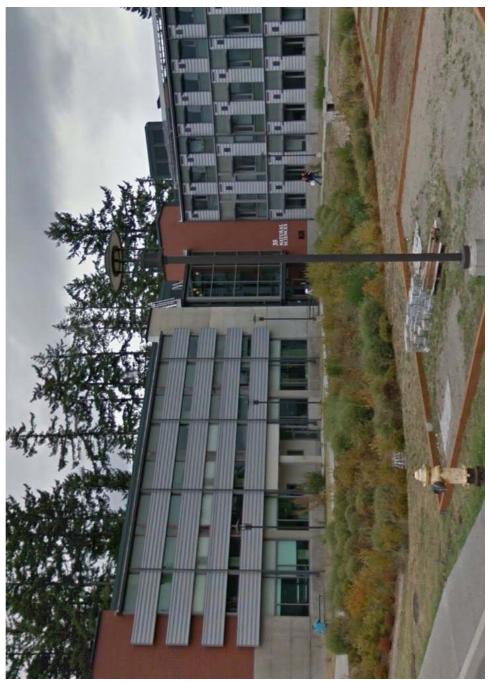





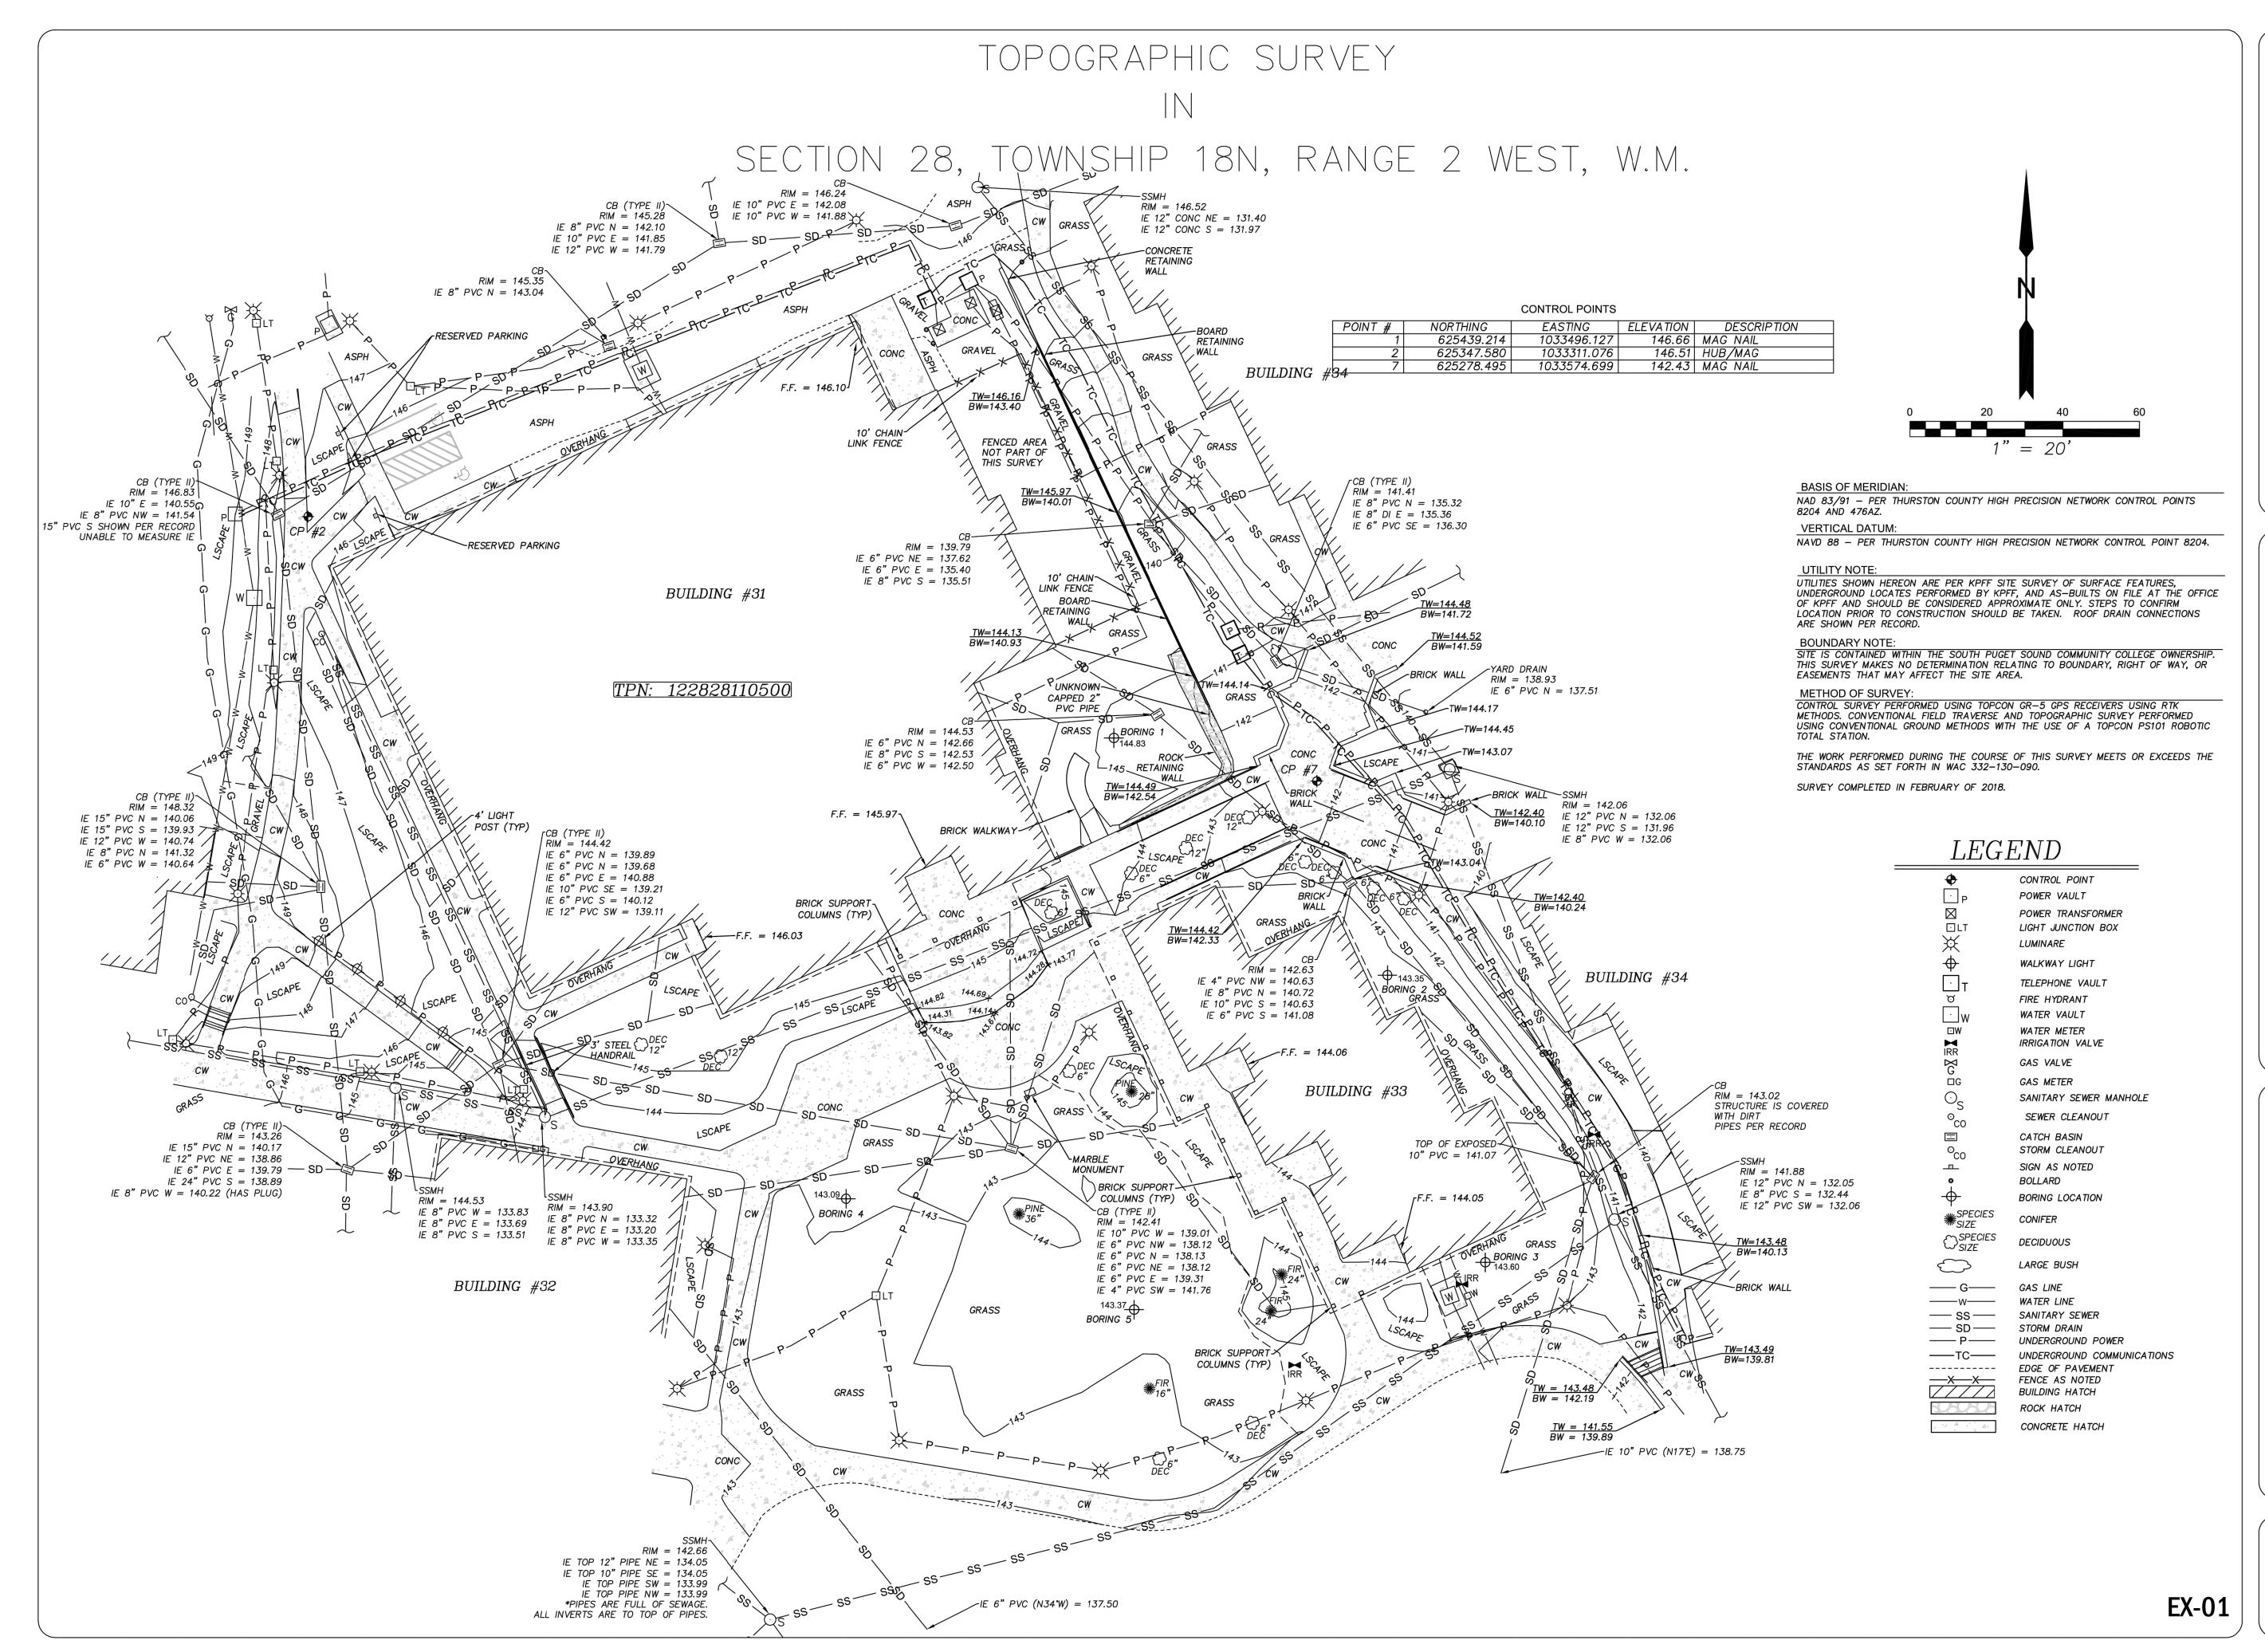

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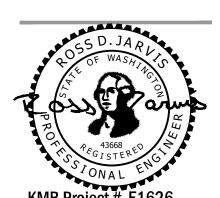
Woodland Square Loop SE, e 100 :y, WA 98503 .292.7230 'w.kpff.com

612 Woodland Squi Suite 100 Lacey, WA 98503 360.292.7230 www.kpff.com

TOPOGRAPHIC SURVEY
OF A PORTION OF
SEC. 28 TWP 18 N, R 2 W, W.M
AT THE REQUEST OF

SCALE: 1" = 20' JOB: 81800001 DATE: 2/13/2018 SHEET 1 OF 1





## XX CONSTRUCTION NOTES:

1. SIDEWALK ENTRANCE WITH RAMP AND LANDING (SEE ENLARGEMENT ON SHEET CG-01)

SCALE IN FEET

PROPOSED BUILDING

CONCRETE SIDEWALK

ASPHALT PAVEMENT

LEGEND

- 2. STEPS TO BE CONSTRUCTED PER ARCHITECTURAL PLANS
- 3. ADA RAMP HANDRAIL PER ARCHITECTECTURAL PLANS
- 4. ACCESSIBILITY SYMBOL, 4" WIDE STRIPING PAINT 2 COATS WHITE W/ 7 MIL. DFT PER COAT

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- 5. REPLACE RESERVED PARKING SIGN



SOUTH PUGET SOUND 2011 MOTTMAN ROAD SW, OLYMPIA, STATE PROJECT NO. 2018-111A


ORIGINAL SHEET SIZE = 24 x 36 HALF SIZE REDUCTIONS = 11 x 17


DATE: 05/02/2018 DESIGN DEVELOPMENT

SP-01

SITE IMPROVEMENT PLAN

THE CONTRACTOR SHALL BE FULLY RESPONSIBLE FOR THE LOCATION AND PROTECTION OF ALL EXISTING UTILITIES. THE CONTRACTOR SHALL VERIFY ALL UTILITY LOCATIONS PRIOR TO CONSTRUCTION BY CALLING THE UNDERGROUND LOCATE LINE AT (800) 424–5555 A MINIMUM OF 48 HOURS PRIOR TO ANY EXCAVATION.

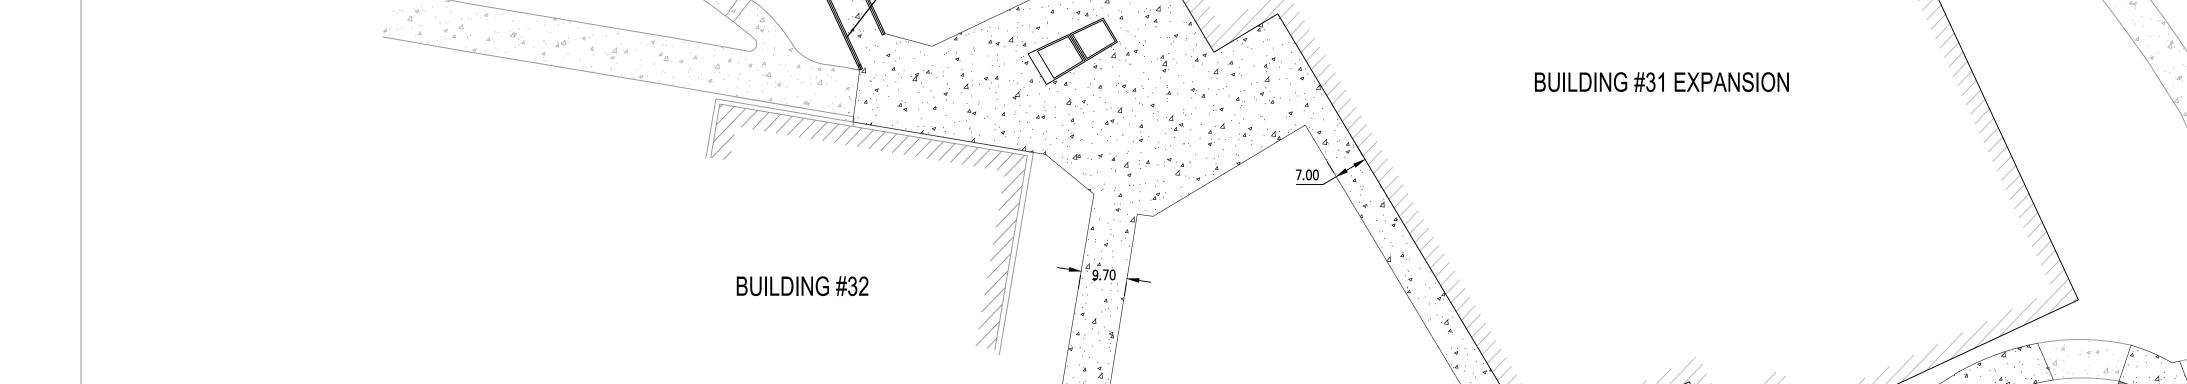

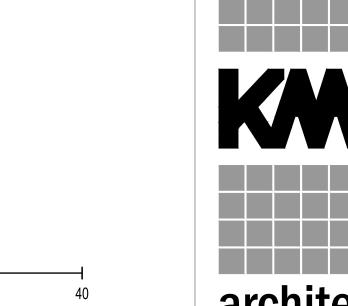

SCALE IN FEET

EXISTING CONCRETE/ASPHALT/SIDEWALK/CURB AND BASE TO BE REMOVED

STABILIZED CONSTRUCTION ENTRANCE

INLET SEDIMENT PROTECTION

REMOVE EXISTING STORM LINE AND BACKFILL TO 95%


REMOVE EXISTING POWER LINE AND BACKFILL TO 95%

REMOVE EXISTING SEWER LINE AND BACKFILL TO 95%

**LEGEND** 

EXISTING TREE TO BE REMOVED

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NOVATION AND ADDITION COLLEGE
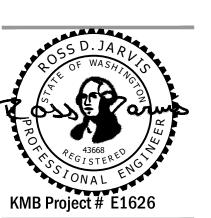
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SOUND

**OUTH PUGET** 

## (XX) EROSION CONTROL NOTES:

- 1. SILT FENCE
- 2. INLET PROTECTION
- 3. CONSTRUCTION ENTRANCE

## XX DEMOLITION NOTES:

- 1. SAWCUT
- 2. EXISTING BUILDING AND FOUNDATION TO BE DEMOLISHED
- 3. REMOVE STORM STRUCTURE AND BACKFILL TO 95% COMPACTION
- 4. REMOVE LIGHT STANDARD, J-BOXES, AND BACKFILL TO 95% COMPACTION
- 5. REMOVE BRICK WALL
- 6. REMOVE HANDRAIL
- 7. REMOVE LANDSCAPING (CLEAR AND GRUB)
- 8. REMOVE SEWER LINE
- 9. RELOCATE IRRIGATION METER, SEE LANDSCAPE PLANS FOR LOCATION
- 10. PROTECT EXISTING UTILITY UNLESS NOTED OTHERWISE
- 11. PROTECT MANHOLE, ADJUST TO GRADE
- 12. PROTECT TELEPHONE VAULT, ADJUST TO GRADE
- 13. PROTECT POWER VAULT, ADJUST TO GRADE
- 14. PROTECT WOOD RETAINING WALL
- 15. PROTECT CATCH BASIN, ADJUST TO GRADE AS NECESSARY
- 16. REMOVE IRRIGATION VALVE/METER
- 17. REMOVE ROCK WALL
- 18. REMOVE AND REPLACE RESERVED PARKING SIGN
- 19. PROTECT WATER VAULT
- 20. PROTECT COMMUNICATIONS TRENCH
- 21. REMOVE BRICK WALKWAY




8730 TALLON LANE NE, SUITE 200, LACEY, WA 98516 P: 360.352.1465 F: 360.352.1509 SCJALLIANCE.COM ORIGINAL SHEET SIZE = 24 x 36
HALF SIZE REDUCTIONS = 11 x 17
REVISIONS:


DESIGN DEVELOPMENT

EC-01

DEMOLITION AND TESC PLAN

THE UNDERGROUND LOCATE LINE AT (800) 424-5555 A MINIMUM OF 48 HOURS PRIOR TO ANY EXCAVATION.

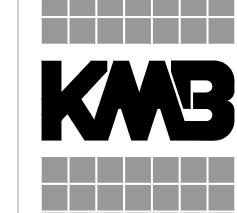

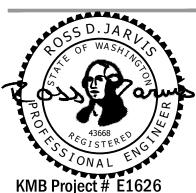


CENTER RENOVATION AND ADDITION OMMUNITY COLLEGE SOUTH PUGET SOUND 2011 MOTTMAN ROAD SW, OLYMPIA, STATE PROJECT NO. 2018-111A

ORIGINAL SHEET SIZE = 24 x 36 HALF SIZE REDUCTIONS = 11 x 17

DATE: 05/02/2018 DESIGN DEVELOPMENT


SHEET NO. **CG-01** 

GRADING PLAN

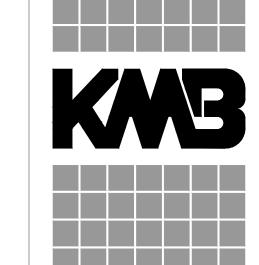

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# NOVATION AND ADDITION COLLEGE

RE

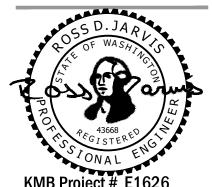CENTER REISOMMUNITY (NA 98512

SS CO

## CITY OF OLYMPIA STORMWATER NOTES:

SCALE IN FEET

EXISTING CONTOURS (MAJOR/MINOR)

EXISTING CATCH BASIN

—— 6" PERFORATED UNDERDRAIN

TYPE 1 CATCH BASIN

QUARRY SPALLS

— FOUNDATION DRAIN

PROPOSED CONTOURS (MAJOR/MINOR)

- 1. ALL STORM CONVEYANCES AND RETENTION/DETENTION AREAS WILL BE STAKED FOR GRADE AND ALIGNMENT BY AN ENGINEERING OR SURVEYING FIRM CAPABLE OF PERFORMING SUCH WORK.
- 2. SPECIAL STRUCTURES, OIL/WATER SEPARATORS, AND OUTLET CONTROLS WILL BE INSTALLED PURSUANT TO PLANS AND MANUFACTURER'S
- 3. WHERE CONNECTIONS REQUIRE "FIELD VERIFICATIONS", CONNECTION POINTS WILL BE EXPOSED BY CONTRACTOR AND FITTINGS VERIFIED 48 HOURS PRIOR TO DISTRIBUTING SHUTDOWN NOTICES.
- 4. ALL STORM LINES AND CATCH BASINS SHALL BE HIGH-VELOCITY CLEANED AND PRESSURE TESTED IN ACCORDANCE WITH DIVISION 7 OF THE STANDARD SPECIFICATIONS PRIOR TO PAVING IN CONFORMANCE WITH THE ABOVE-REFERENCED SPECIFICATIONS. HYDRANT FLUSHING OF LINES IS NOT AN ACCEPTABLE CLEANING METHOD.
- 5. TESTING OF THE STORM PIPING WILL INCLUDE TELEVISION INSPECTION, COMPATIBLE WITH GRANITE XP SOFTWARE, AT THE CONTRACTOR'S EXPENSE. ADDITIONAL TELEVISING THAT IS DEEMED NECESSARY WILL ALSO BE AT THE CONTRACTOR'S EXPENSE. ALL TELEVISION INSPECTIONS SHALL BE COMPLETED IN THE MANNER AS REQUIRED BY THE PACP. IMMEDIATELY PRIOR TO TELEVISION INSPECTING, ENOUGH WATER WILL BE RUN DOWN THE LINE SO IT COMES OUT THE LOWER MANHOLE AND THE LINE IS FLUSHED CLEAN. ACCEPTANCE OF THE LINE WILL BE MADE AFTER THE TELEVISION INSPECTION TAPE HAS BEEN REVIEWED AND APPROVED BY THE INSPECTOR.
- 6. ALL CATCH BASINS SHALL HAVE A CURB MARKER, ANTI-DUMPING DISC INSTALLED AS SPECIFIED IN THE EDDS.
- 7. ALL SOLID ROUND CATCH BASIN COVERS SHALL BE CITY OF OLYMPIA DECORATIVE STANDARD (PER STANDARD DRAWING 5-12).
- 8. ALL SURFACE STORM WATER FACILITIES SHALL HAVE INFORMATIONAL SIGNS INSTALLED ADJACENT TO STREETS, SIDEWALKS AND PATHS.



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HEALTH AND WELLNESS
SOUTH PUGET SOUND C
2011 MOTTMAN ROAD SW, OLYMPIA, W
STATE PROJECT NO. 2018-111A ORIGINAL SHEET SIZE = 24 x 36 HALF SIZE REDUCTIONS = 11 x 17 REVISIONS:

DATE: 05/02/2018 **DESIGN DEVELOPMENT** 


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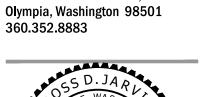
SD-01 DRAINAGE PLAN

VERIFY ALL UTILITY LOCATIONS PRIOR TO CONSTRUCTION BY CALLING

THE UNDERGROUND LOCATE LINE AT (800) 424-5555 A MINIMUM OF

48 HOURS PRIOR TO ANY EXCAVATION.



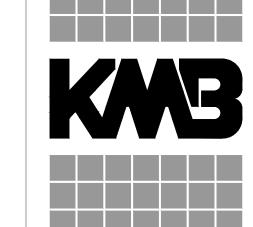



## KMB Project # E1626 DITION

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MOTTMAN ROAD SW, OLYMPIA, PROJECT NO. 2018-111A

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SOUTH PUGET

## 4. THE CITY REQUIRES 10 WORKING DAYS WRITTEN NOTICE TO SCHEDULE SHUTDOWNS. THE WRITTEN NOTICE WILL BE COORDINATED WITH THE CITY INSPECTOR. THE CITY OF OLYMPIA DRINKING WATER OPERATIONS OR CITY INSPECTOR WILL PERFORM THE SHUTDOWN.

SCALE IN FEET

- 5. AT ANY CONNECTION TO AN EXISTING LINE WHERE A NEW VALVE IS NOT INSTALLED, THE EXISTING VALVE MUST BE PRESSURE TESTED TO CITY STANDARDS BY THE CONTRACTOR PRIOR TO CONNECTION. IF AN EXISTING VALVE FAILS TO PASS THE TEST, THE CONTRACTOR WILL MAKE THE NECESSARY PROVISIONS TO TEST THE NEW LINE PRIOR TO CONNECTION TO THE EXISTING SYSTEM OF INSTALL A NEW VALVE.
- 6. AT ANY WATER MAIN TAP TO EXISTING CITY MAINS WHERE THE CONTRACTOR ENCOUNTERS A COUPLING OR EXISTING ASSEMBLIES, THE CONTRACTOR WILL PROVIDE A MINIMUM OF 18 INCHES OF CLEARANCE FROM COUPLING OR ASSEMBLIES TO EDGE OF TAPPING SLEEVE.
- 7. ANY WATER MAIN TAP OR CONNECTION WILL BE BLOCKED ACCORDING TO THE CITY OF OLYMPIA STANDARD DRAWINGS.
- 8. ANY EXCAVATION THAT EXPOSES AN ASBESTOS CEMENT (AC) WATER MAIN OR THE CITY'S 36-INCH WATER TRANSMISSION MAIN SHALL BE BEDDED WITH CONTROLLED DENSITY FILL (CDF) PURSUANT TO THE WSDOT SPECIFICATIONS FOR CDF. AS AN OPTION THE CONTRACTOR MAY CHOOSE TO REPLACE THE AC PIPE AT ANY CROSSING WITH DUCTILE IRON PIPE BENCHED INTO BOTH TRENCH WALLS. THE CONTRACTOR WILL COORDINATE WITH THE CITY INSPECTOR TO HAVE A CITY OF OLYMPIA DRINKING WATER OPERATIONS STAFF MEMBER ON SITE BEFORE CONSTRUCTION BEGINS.
- 9. BEFORE CUTTING OR REMOVING ANY EXISTING AC PIPE, THE CONTRACTOR WILL SUPPLY THE CITY OF OLYMPIA INSPECTOR A COPY OF THE WORKMAN'S CERTIFICATIONS TO WORK WITH AC PIPE. THE CONTRACTOR WILL CONFORM TO ALL REGULATIONS AND GUIDANCE RELATED TO ASBESTOS WORK PROVIDED BY THE OLYMPIC REGION CLEAN AIR AGENCY.

## CITY OF OLYMPIA SANITARY SEWER NOTES:

- 1. IF CONSTRUCTION IS TO TAKE PLACE IN THE COUNTY RIGHT-OF-WAY, THE CONTRACTOR SHALL NOTIFY THE COUNTY AND OBTAIN ALL THE REQUIRED APPROVALS AND PERMITS.
- 2. THE CITY OF OLYMPIA CONSTRUCTION INSPECTOR SHALL BE NOTIFIED A MINIMUM OF 48 HOURS (TWO WORKING DAYS) IN ADVANCE OF A TAP CONNECTION TO AN EXISTING MAIN. THE INSPECTOR SHALL BE PRESENT AT THE TIME OF THE TAP.
- 3. ALL SEWER MAINS SHALL BE FIELD STAKED FOR GRADES AND ALIGNMENT BY A LICENSED ENGINEERING OR SURVEYING FIRM QUALIFIED TO PERFORM SUCH WORK. STAKING SHALL BE MAINTAINED THROUGHOUT
- 4. WHEN TEMPORARY STREET PATCHES ARE ALLOWED BY THE CITY, COLD MIX ASPHALT SHALL BE PLACED AND COMPACTED TO A MAXIMUM DEPTH OF 2 INCHES. CONTRACTOR SHALL BE RESPONSIBLE FOR MAINTENANCE AS
- 5. AFTER BACKFILLING, BUT PRIOR TO PAVING, ALL MAINS AND APPURTENANCES SHALL BE INSPECTED AND APPROVED BY THE CITY OF OLYMPIA CONSTRUCTION INSPECTOR. APPROVAL DOES NOT CONSTITUTE FINAL ACCEPTANCE OF THE SEWER LINE. THE CONTRACTOR SHALL RETAIN THE RESPONSIBILITY TO REPAIR ALL DEFICIENCIES AND FAILURES REVEALED DURING ALL REQUIRED TESTING FOR ACCEPTANCE AND THROUGH THE DURATION OF THE WARRANTY. IT SHALL BE THE CONTRACTOR'S RESPONSIBILITY TO NOTIFY THE CITY OF OLYMPIA FOR THE REQUIRED INSPECTIONS. ANY MAIN OR APPURTENANCE BACKFILLED PRIOR TO INSPECTION SHALL BE RE-EXCAVATED FOR INSPECTION.
- 6. ALL LINES WILL BE HIGH-VELOCITY CLEANED AND SUBJECTED TO A LOW-PRESSURE AIR TEST PURSUANT TO CURRENT WSDOT/APWA SPECIFICATIONS AFTER BACKFILLING, BUT PRIOR TO PAVING (SEE GENERAL NOTE 1). HYDRANT FLUSHING OF LINES IS NOT AN ACCEPTABLE CLEANING METHOD.
- 7. TESTING OF THE SANITARY SEWER MAIN WILL INCLUDE TELEVISION INSPECTION AT THE CONTRACTOR'S EXPENSE. ADDITIONAL TEVLEVISING THAT IS DEEMED NECESSARY WILL ALSO BE AT THE CONTRACTOR'S EXPENSE. ALL TELEVISION INSPECTIONS SHALL BE COMPLETED IN THE MANNER REQUIRED BY THE PACP. IMMEDIATELY PRIOR TO TELEVISION INSPECTION, ENOUGH WATER WILL BE RUN DOWN THE LINE SO IT COMES OUT THE LOWER MANHOLE AND THE LINE IS FLUSHED CLEAN. ACCEPTANCE OF THE LINE WILL BE MADE AFTER THE TELEVISION INSPECTION TAPE HAS BEEN REVIEWED AND APPROVED BY THE INSPECTOR.
- 8. A TEST OF ALL MANHOLES IN ACCORDANCE WITH OLYMPIA STANDARD IS ALSO REQUIRED. TESTING WILL TAKE PLACE AFTER ALL UNDERGROUND UTILITIES ARE INSTALLED AND COMPACTION OF THE ROADWAY SUBGRADE IS COMPLETED.



8730 TALLON LANE NE, SUITE 200, LACEY, WA 98516 P: 360.352.1465 F: 360.352.1509 SCJALLIANCE.COM

ORIGINAL SHEET SIZE = 24 x 36 HALF SIZE REDUCTIONS =  $11 \times 17$ REVISIONS:

05/02/2018 **DESIGN DEVELOPMENT** 

SHEET NO. **UT-01** 

WATER AND SEWER PLAN

48 HOURS PRIOR TO ANY EXCAVATION.