COOPER POINT ROAD BUILDING ENTRY SCHILTER DEVELOPMENT

1217 Cooper Point Road, Olympia, WA 98501

PROJECT INFORMATION

BUILDING Owner Ed Schilter 906 Columbia Street SW, Ste 400 Olympia, Washington 98501 edschilter@kmbdesign.com 360.352.8883

DESIGN TEAM

ARCHITECT
KMB architects
906 Columbia Street SW, Ste 400
Olympia, Washington 98501
Ed Schilter, Principal
edschilter@kmbdesign.com
Elizabeth Glenn
elizabethglenn@kmbdesign.com
360.352.8883

CONTRACTOR

Adroit Contractors, Inc
1001 S Evergreen Park Drive SW
Olympia, WA 98502
Stuart Drebick
adroitci@comcast.net
Cell: 360.481.5971


STRUCTURAL
MC Squared, Inc
1235 4th Ave E Ste 101
Olympia, WA 98505
Mike Szramek
mike@mc2-inc.com
Office: 360.754.9339

Office: 360.943.4346

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DRAWING SYMBOLS



SHEET NUMBER WHERE SECTION APPEARS

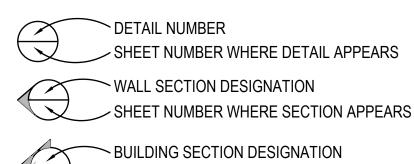ELEVATION NUMBER DESIGNATION

DIRECTION IN ROOM

SHEET NUMBER WHERE

SHEET NUMBER WHERE
ELEVATION APPEARS

ROOM NUMBER FOR FINISH SCHEDULE

DOOR NUMBER FOR DOOR SCHEDULE

WINDOW TYPE

WINDOW NUMBER

CEILING DESIGNATION

CEILING HEIGHT

⇒ ELECTRICAL OUTLET■ DATA OUTLET

CONSTRUCTION NOTES

GENERAL NOTES:

- Use construction practices to obtain high quality construction results. If in doubt about proposed means, methods or materials discuss with owners representative before proceeding.
- All proposed substitutions must have owner approval, must be equal or better in owner's opinion and must include data to substantiate the equal or better argument.

DOORS

- Provide timely hollow metal frames as noted on door
- Provide solid core door as noted on door schedule.

ELECTRICAL

1. Electrical is bidder design.



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KMB Project # D1225

ROAD BUILDING ENTRY

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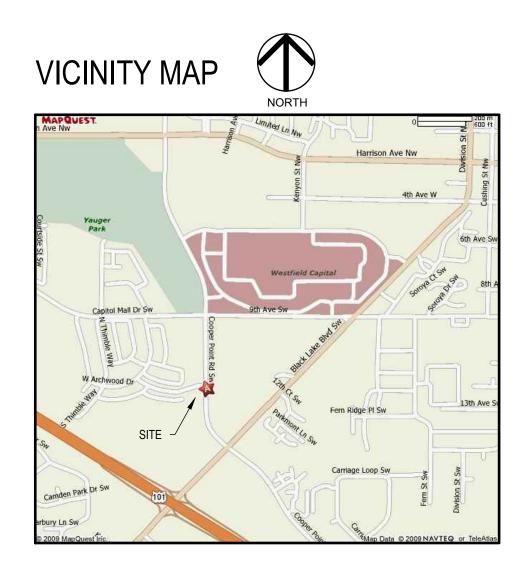
ORIGINAL SHEET SIZE = 22 x 34 HALF SIZE REDUCTIONS = 11x17


DATE: 05-23-2018
CONSTRUCTION DOCUMENTS

A0.1

DRAWING ABBREVIATIONS

JK	AVVIING ADDR	(VIA	TIONS								
	AND	COL	COLUMN	FAB	FABRICATE(ION)	IN	INCH	ОН	OVERHANG OR OVERHEAD	STR	STRUCTURAL
	ANGLE	CONC	CONCRETE	FIN	FINISH	INSUL	INSULATION	OPNG	OPENING	SUSP	SUSPENDED(TION)
D	AT	CONN	CONNECTION	FE	FIRE EXTINGUISHER	INT	INTERIOR	OPP	OPPOSITE	PSF	POUNDS PER SQUARE FOOT
2	CENTER LINE	CONST	CONSTRUCTION	FEC	FIRE EXTINGUISHER CABINET	JAN	JANITOR	ORNT	ORIENTATE(ION)	SYM	SYMMETRICAL
í	DIAMETER	CONT	CONTINUOUS	FF	FINISH FLOOR	JST	JOIST	PAR	PARALLEL	T	TOP
'	FOOT (FEET)	CORR	CORRIDOR	FHWS	FLAT HEAD WOOD SCREW	JT	JOINT	P/C	PRECAST CONCRETE	Т&В	TOP AND BOTTOM
	INCH	CTSK	COUNTERSINK	FLG	FLASHING	KIT	KITCHEN	PERP	PERPENDICULAR	T&G	TONGUE AND GROOVE
	PENNY (NAILS)	CTR	CENTER	FLR	FLOOR	LAT	LATERAL	PLAM	PLASTIC LAMINATE	TB	TACK BOARD
	POUNDS	DBL	DOUBLE	FOC	FACE OF CONCRETE	LB	POUNDS	PL	PLATE OR PROPERTY LINE	THK	THICK
	PLATE or PROPERTY LINE	DEPT	DEPARTMENT	FOM	FACE OF MASONRY	LF	LINEAL FEET	PWD	PLYWOOD	TN	TOE NAIL
D	ANCHOR BOLT	DF	DOUGLAS FIR /	FOS	FACE OF STUD	LI I	LENGTH / LONG	MB	MACHINE BOLT	TOC	TOP OF CONCRETE
/C	AIR CONDITIONING	וט	DRINKING FOUNTAIN	FOW	FACE OF WALL	LOC	LOCATION	PSI	POUNDS PER SQUARE INCH	TOP	TOP OF PAVING
COUS	ACOUSTIC(AL)	DIA OR Ø	DIAMETER	FOW FP	FIREPROOF	LT	LIGHT	PT	PRESSURE TREATED	TOM	TOP OF PAVING
CT.	ACOUSTIC(AL) ACOUSTICAL CEILING TILE	DIAG	DIAGONAL	FR	FIRE RESISTANT	M.C.	METAL CHANNEL	PTD	PAPER TOWEL DISPENSER	TOJ	TOP OF MASONRY
.CC	ACCESSIBLE	DIAG	DOWN	FRMG	FRAMING	MR	MOISTURE RESISTANT	QTY	QUANTITY	TOS	TOP OF SHEATHING
	ADDITIONAL	DO		FRT	FIRE-RETARDANT-TREATED	MATL	MATERIAL	RAD OR R	RADIUS	TOW	TOP OF WALL
DD	ADDITIONAL ADJACENT / ADJUSTABLE	DR DR	DITTO (REPEAT) DOOR	FS	FAR SIDE	MAX	MAXIMUM	RAD OR R REF	REFERENCE	TPD	TOP OF WALL TOILET PAPER DISPENSER
DJ		DHM		FT		HDR	HEADER	REFL			
FF	ABOVE FINISH FLOOR	DHM DWG	DETENTION HOLLOW METAL DRAWING	FTG	FOOT(FEET) FOOTING	MECH	MECHANICAL	REFL REFR.	REFLECTED REFRIGERATOR	TSCD	TOILET SEAT COVER
LUM	ALUMINUM		DRAWING EXISTING			MEZZ	MEZZANINE			TO	DISPENSER
LT	ALTERNATE	(E)		GA	GAUGE			REINF	REINFORCED	TS	TUBE STEEL
PPROX	APPROXIMATE	EA	EACH	GALV	GALVANIZED	MFR	MANUFACTURER	REQ'D	REQUIRED	TYP	TYPICAL
RCH	ARCHITECT(URAL)	EF	EXHAUST FAN	GB	GRAB BAR	MIN	MINIMUM	RHWS	ROUND HEAD WOOD SCREW	UBC	UNIFORM BUILDING CODE
D	BOARD	EHD	ELECTRONIC HAND DRYER	GLB	GLUE LAMINATED BEAM	MISC	MISCELLANEOUS	RM	ROOM	UON	UNLESS OTHERWISE NOTED
LDG	BUILDING	EIFS	EXTERIOR INSULATION	GWB	GYPSUM WALLBOARD	MO	MASONRY OPENING	RO	ROUGH OPENING	VCT	VINYL COMPOSITION TILE
LK	BLOCK		AND FINISHING SYSTEM	НВ	HOSE BIBB	MR	MOISTURE RESISTANT	SC	SOLID CORE	VERT OR V	VERTICAL
LKG	BLOCKING	EJ	EXPANSION JOINT	HC	HOLLOW CORE / HANDICAP	MTD	MOUNTED	SCH	SCHEDULE	VIF	VERIFY IN FIELD
M	BEAM	EL	ELEVATION	HD	HOLD DOWN	MTL	METAL	SF	SQUARE FOOT (FEET)	W	WIDE (WIDTH)
RG	BEARING	ELEC	ELECTRICAL	FDN	FOUNDATION	(N)	NEW	SHT	SHEET	W/	WITH
TM	BOTTOM	ELEV	ELEVATION	HDW	HARDWARE	NIC	NOT IN CONTRACT	SHTG	SHEATHING	W/O	WITHOUT
TWN	BETWEEN	EHD	ELECTRONIC HAND DRYER	HGR	HANGER	NO	NUMBER	SIM	SIMILAR	WB	WHITE BOARD
UR	BUILT-UP ROOF	EN	EDGE NAIL		HORIZONTAL	NS	NEAR SIDE	SP	SPACE(ING)	SV	SHEET VINYL
AB	CABINET	ENG	ENGINEER	HM	HOLLOW METAL	NTS	NOT TO SCALE	SPS	SPACES	WC	WATER CLOSET
FCI	CONTRACTOR FURNISHED/	EQ	EQUAL	HR	HOUR	OC	ON CENTER	SPEC	SPECIFICATIONS	WD	WOOD
	CONTRACTOR INSTALLED	EQUIP	EQUIPMENT	HTG	HEATING	OD	OUTSIDE DIAMETER	SQ	SQUARE	WIN	WINDOW
J	CONSTRUCTION JOINT	ES	EACH SIDE	HTR	HEATER	OF	OUTSIDE FACE	SS	STAINLESS STEEL	WP	WATER PROOF / WORK POINT
L OR &	CENTER LINE	EXP	EXPANSION	HWH	HOT WATER HEATER	OFCI	OWNER FURNISHED/	SSK	SERVICE SINK	WWF	WELDED WIRE FABRIC
LG	CEILING	EXIST, EXG	EXISTING	HT	HEIGHT		CONTRACTOR INSTALLED	STD	STANDARD	YD	YARD
LR	CLEAR	EXT	EXTERIOR	ID	INSIDE DIAMETER	OFOI	OWNER FURNISHED/ OWNER	STGR	STAGGER		
MU	CONCRETE MASONRY UNIT	FA	FIRE ALARM	IF	INSIDE FACE		INSTALLED	STL	STEEL		



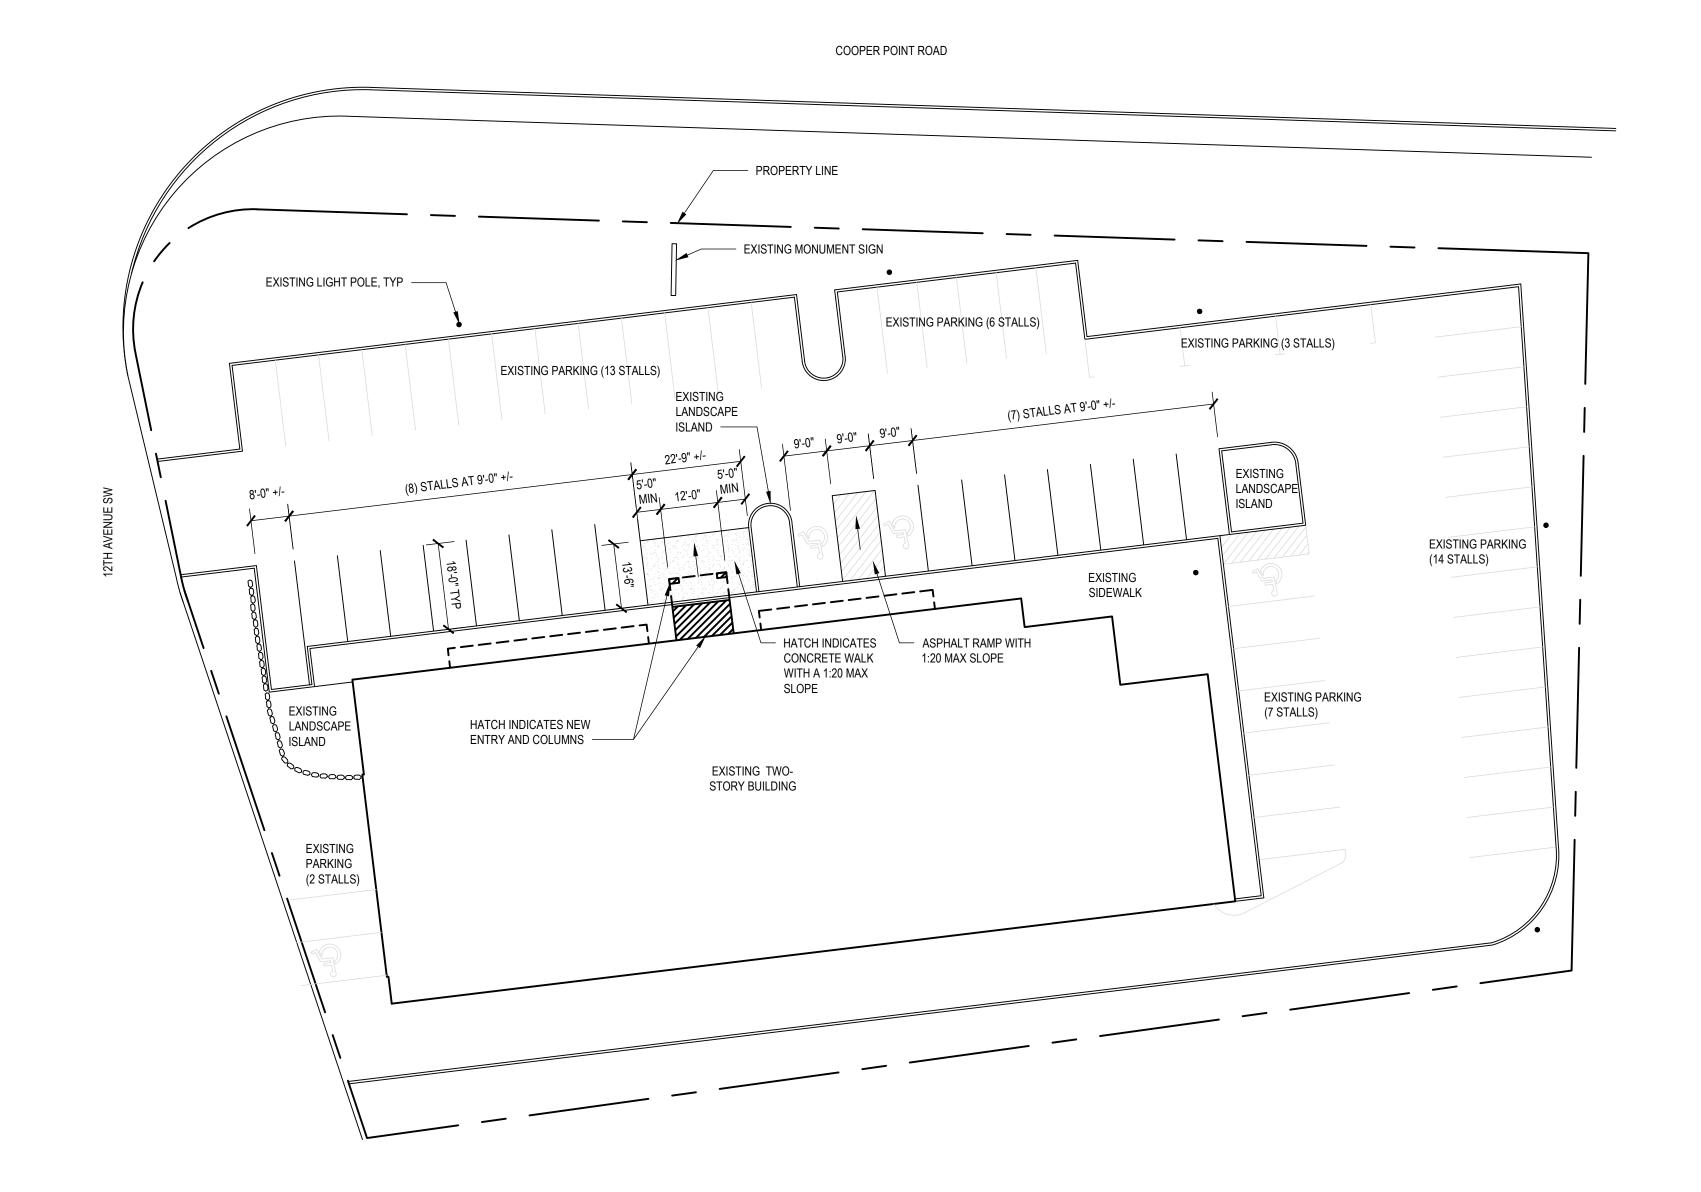





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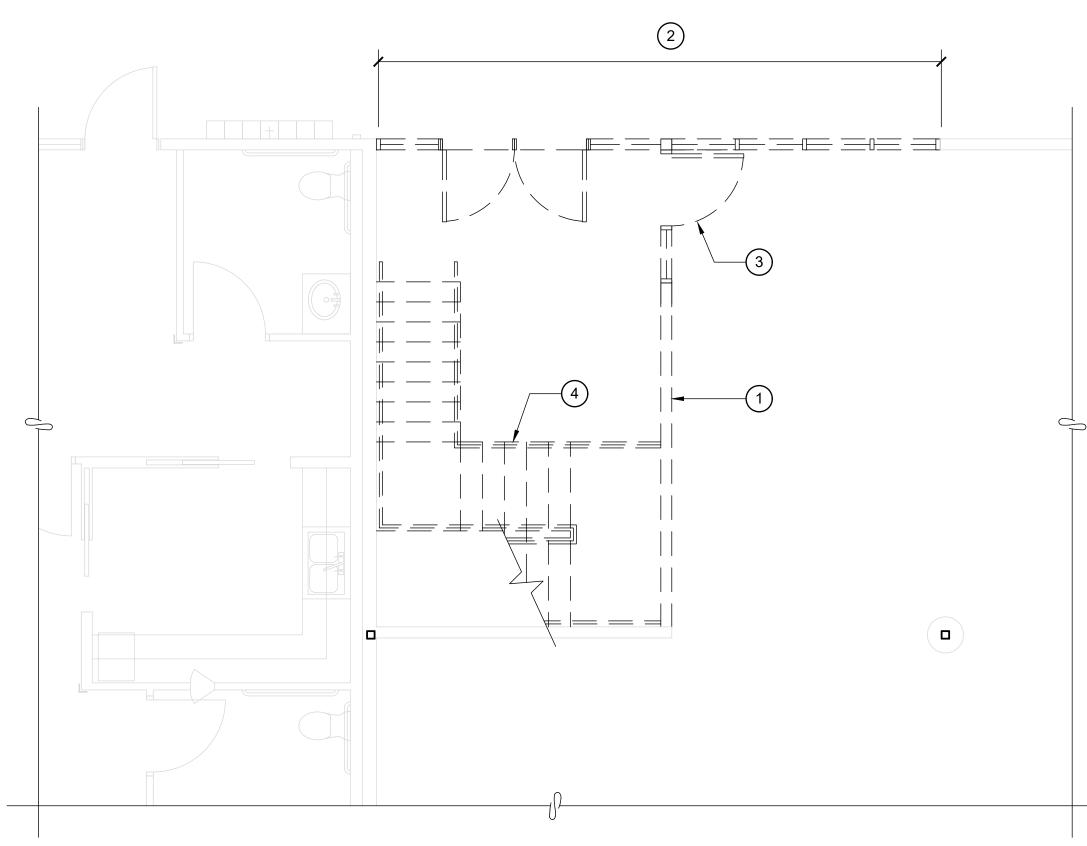
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COOPER POINT ROAD BUILDING ENTRY 1217 Cooper Point Road Olympia, WA 98501

ORIGINAL SHEET SIZE = 22 x 34 HALF SIZE REDUCTIONS = 11x17

DATE: 05-23-2018 CONSTRUCTION DOCUMENTS

A1.1



DEMOLTION FIRST FLOOR PLAN SCALE: 1/4" = 1'-0"

DEMOLITION KEYNOTES

- REMOVE ALL OR PORTION OF EXISTING WALL AS SHOWN. RELOCATE ELECTRICAL OUTLETS, SWITCHES, OR DATA OUTLETS TO NEW OR ADJACENT WALL.
- 2 REMOVE EXISTING STOREFRONT SYSTEM
- REMOVE EXISTING DOOR AND FRAME (INCLUDING SIDELIGHT WHERE OCCURS)
 TURN FRAME OVER TO OWNER
- 4 DEMOLISH EXISTING STAIRS
- 5 REMOVE EXISTING WINDOW
- 6 DEMOLISH EXISTING ROOF/ SKYLIGHT OVER ENTIRE AREA

DEMOLITION NOTES

 SEE FLOOR PLANS FOR INFILL OF REMOVED DOORS AND OTHER OPENINGS

PLAN LEGEND

- EXISTING WALL TO REMAIN

 NEW WALL, SEE WALL TYPES ON A-900
- ==== WALL TO BE REMOVED
- DOOR TO BE REMOVED

SYMBOL LEGEND

SEE COVER SHEET FOR ADDITIONAL INFORMATION

- ELEVATION NUMBER DESIGNATION

 4 1 2 DIRECTION IN ROOM

 SHEET NUMBER WHERE
 ELEVATION APPEARS



L TYPE

FLOOR PLAN KEYNOTES

- 1 NEW STAIRS AND RAILINGS, SEE SECTIONS AND DETAILS
- 2 SCHINDLER 3100 MRL TRACTOR ELEVATOR OR SIM
- 3 42" HIGH PARTIAL HEIGHT WALL
- 4 #1 DF 6x6 POST UNDER ELEVATOR BEAM
- (3) STUDS GANGED TOGETHER TO SUPPORT BEAM ABOVE. BELOW STUDS PROVIDE NEW 12" THICK 2'-3" SQUARE CONCRETE FOOTING WITH (3) #4 REBAR EACH WAY PER (A9.1)
- 6 CONNECT NEW FOUNDATION TO EXISTING FOUNDATION, SEE $\frac{3}{A9.1}$
- STUDS GANGED TOGETHER (TWO OR THREE, AS SHOWN) TO SUPPORT BEAM ABOVE.
- PROVIDE SIMPSON ACE, ONE SIDE
- 8 POTENTIAL WALL TO CREATE LOW STORAGE ROOM. IF ELEVATOR ROOM IS TAKEN OUT OF STORAGE 201 ON 2ND FLOOR. A DOOR WILL BE REQUIRED, LOCATION TBD.
- 9 NEW HERCULES SUPER NOP CARPET TILE. COLOR SELECTED BY OWNER. DEMOLISH EXISTING CARPET AS REQUIRED.


GENERAL FLOOR PLAN NOTES

- 1. INSTALL NEW WALLS AS INDICATED. NEW WALLS ARE WALL TYPE 1 UNLESS OTHERWIDE NOTED. SEE WALL TYPES ON SHEET A8.1
- INSTALL NEW DOORS PER SCHEDULE ON A8.1.
 INSTALL NEW WINDOWS PER SCHEDULE ON A8.1.
- 4. ALL HANDRAILS AT STAIRS TO EXTEND 12" BEYOND THE LAST STEP EXCEPT WHERE THEY ARE CONTINUOUS AND TURN A CORNER


FINISH NOTES

- ALL EXISTING FINISHES TO REMAIN, UNLESS OTHERWISE NOTED
 PAINT AND TEXTURE ALL NEW WALLS AND CEILING TO MATCH EXISTING. WHERE NEW WALL IS AN INFILL, PAINT NEW AND EXISTING WALL (CORNER TO CORNER) IN ORDER TO PROVIDE A CONTINUOUS AND ELLISH LOOK.
- PROVIDE A CONTINUOUS AND FLUSH LOOK.
 3. PAINT AND TEXTURE ALL PATCHED LOCATIONS TO MATCH EXISTING.
- PAINT AND TEXTURE ALL PATCHED LOCATIONS TO MATCH EXISTING.

 ALL NEW DOORS AND FRAMES FINISHED TO MATCH EXISTING DOORS AND FRAMES.

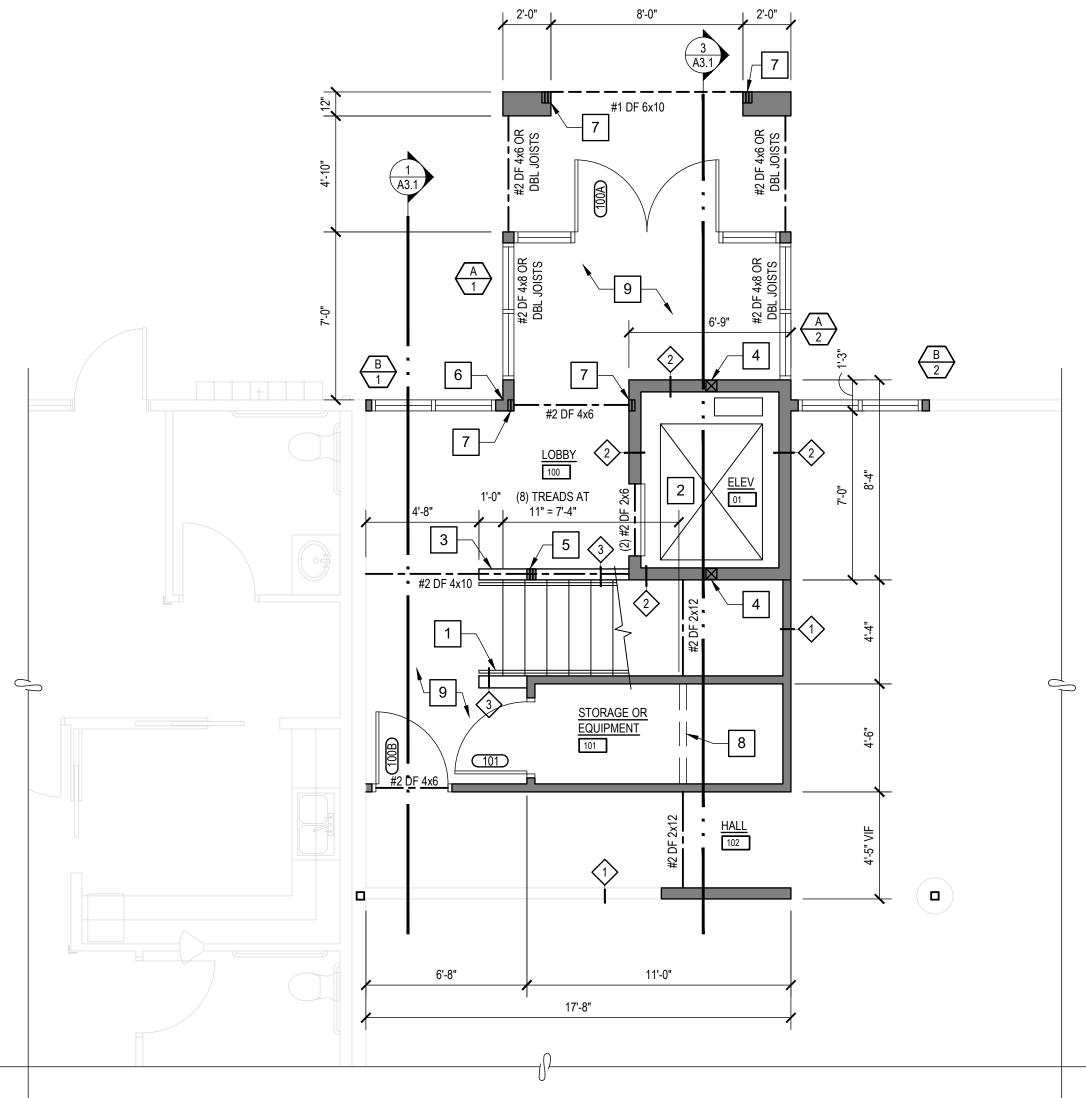



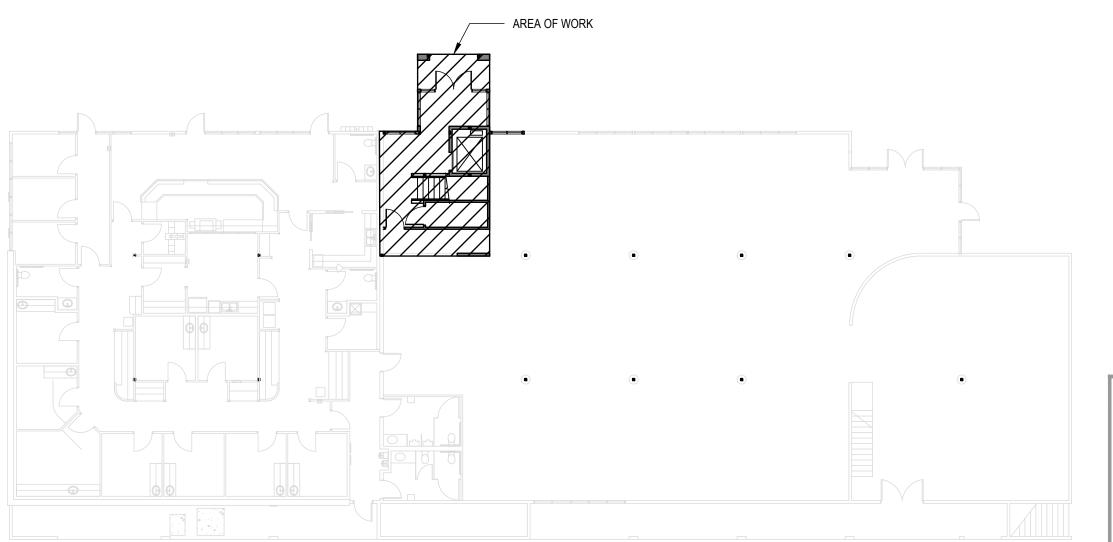



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G ENTRY

BUILDIN

ROAD

OINT


ORIGINAL SHEET SIZE = 22 x 34 HALF SIZE REDUCTIONS = 11x17 REVISIONS:

05-23-2018
CONSTRUCTION DOCUMENTS

SHEET NO.

A2.1
FIRST FLOOR PLAN



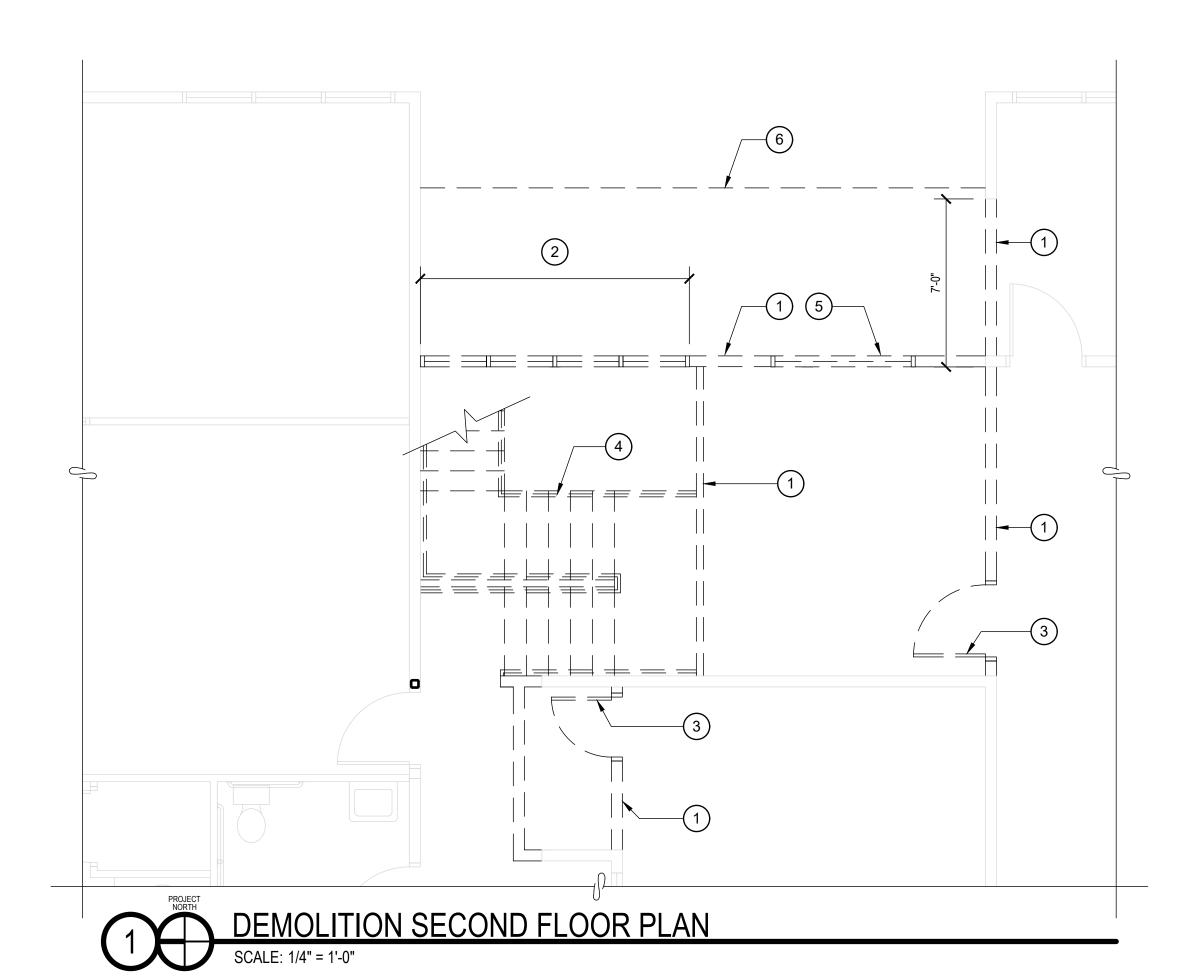

DEMOLITION KEYNOTES

- REMOVE ALL OR PORTION OF EXISTING WALL AS SHOWN. RELOCATE ELECTRICAL OUTLETS, SWITCHES, OR DATA OUTLETS TO NEW OR ADJACENT WALL.
- 2 REMOVE EXISTING STOREFRONT SYSTEM
- REMOVE EXISTING DOOR AND FRAME (INCLUDING SIDELIGHT WHERE OCCURS) TURN FRAME OVER TO OWNER
- 4 DEMOLISH EXISTING STAIRS
- (5) REMOVE EXISTING WINDOW
- 6 DEMOLISH EXISTING ROOF/ SKYLIGHT OVER ENTIRE AREA

DEMOLITION NOTES


1. SEE FLOOR PLANS FOR INFILL OF REMOVED DOORS AND OTHER OPENINGS

PLAN LEGEND

- EXISTING WALL TO REMAIN NEW WALL, SEE WALL TYPES ON A-900
- = = = WALL TO BE REMOVED
- DOOR TO BE REMOVED
- SYMBOL LEGEND

SEE COVER SHEET FOR ADDITIONAL INFORMATION

- ELEVATION NUMBER DESIGNATION $4 \left(\frac{1}{A7.1}\right) 2 \longrightarrow DIRECTION IN ROOM$ SHEET NUMBER WHERE **ELEVATION APPEARS**
- DOOR NUMBER FOR DOOR SCHEDULE XXXX WINDOW TYPE

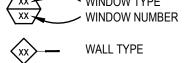

FLOOR PLAN KEYNOTES

- 1 NEW STAIRS AND RAILINGS, SEE SECTIONS AND DETAILS
- 2 | SCHINDLER 3100 MRL TRACTOR ELEVATOR OR SIM
- 3 42" HIGH PARTIAL HEIGHT WALL
- 4 #1 DF 6x6 POST UNDER ELEVATOR BEAM
- (3) STUDS GANGED TOGETHER TO SUPPORT BEAM ABOVE. BELOW STUDS PROVIDE NEW 12" THICK 2'-3" SQUARE CONCRETE FOOTING WITH (3) #4 REBAR EACH WAY PER (A9.1)
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- T STUDS GANGED TOGETHER (TWO OR THREE, AS SHOWN) TO SUPPORT BEAM ABOVE. PROVIDE SIMPSON ACE, ONE SIDE
- 8 POTENTIAL WALL TO CREATE LOW STORAGE ROOM. IF ELEVATOR ROOM IS TAKEN OUT OF STORAGE 201 ON 2ND FLOOR. A DOOR WILL BE REQUIRED, LOCATION TBD.
- 9 NEW HERCULES SUPER NOP CARPET TILE. COLOR SELECTED BY OWNER. DEMOLISH EXISTING CARPET AS REQUIRED.


GENERAL FLOOR PLAN NOTES

- 1. INSTALL NEW WALLS AS INDICATED. NEW WALLS ARE WALL TYPE 1 UNLESS OTHERWIDE NOTED. SEE WALL TYPES ON SHEET A8.1
- INSTALL NEW DOORS PER SCHEDULE ON A8.1. INSTALL NEW WINDOWS PER SCHEDULE ON A8.1.
- 4. ALL HANDRAILS AT STAIRS TO EXTEND 12" BEYOND THE LAST STEP EXCEPT WHERE THEY ARE CONTINUOUS AND TURN A CORNER

FINISH NOTES

- 1. ALL EXISTING FINISHES TO REMAIN, UNLESS OTHERWISE NOTED 2. PAINT AND TEXTURE ALL NEW WALLS AND CEILING TO MATCH EXISTING. WHERE NEW WALL IS AN INFILL, PAINT NEW AND EXISTING WALL (CORNER TO CORNER) IN ORDER TO PROVIDE A CONTINUOUS AND FLUSH LOOK.
- 3. PAINT AND TEXTURE ALL PATCHED LOCATIONS TO MATCH EXISTING. 4. ALL NEW DOORS AND FRAMES FINISHED TO MATCH EXISTING DOORS AND FRAMES.



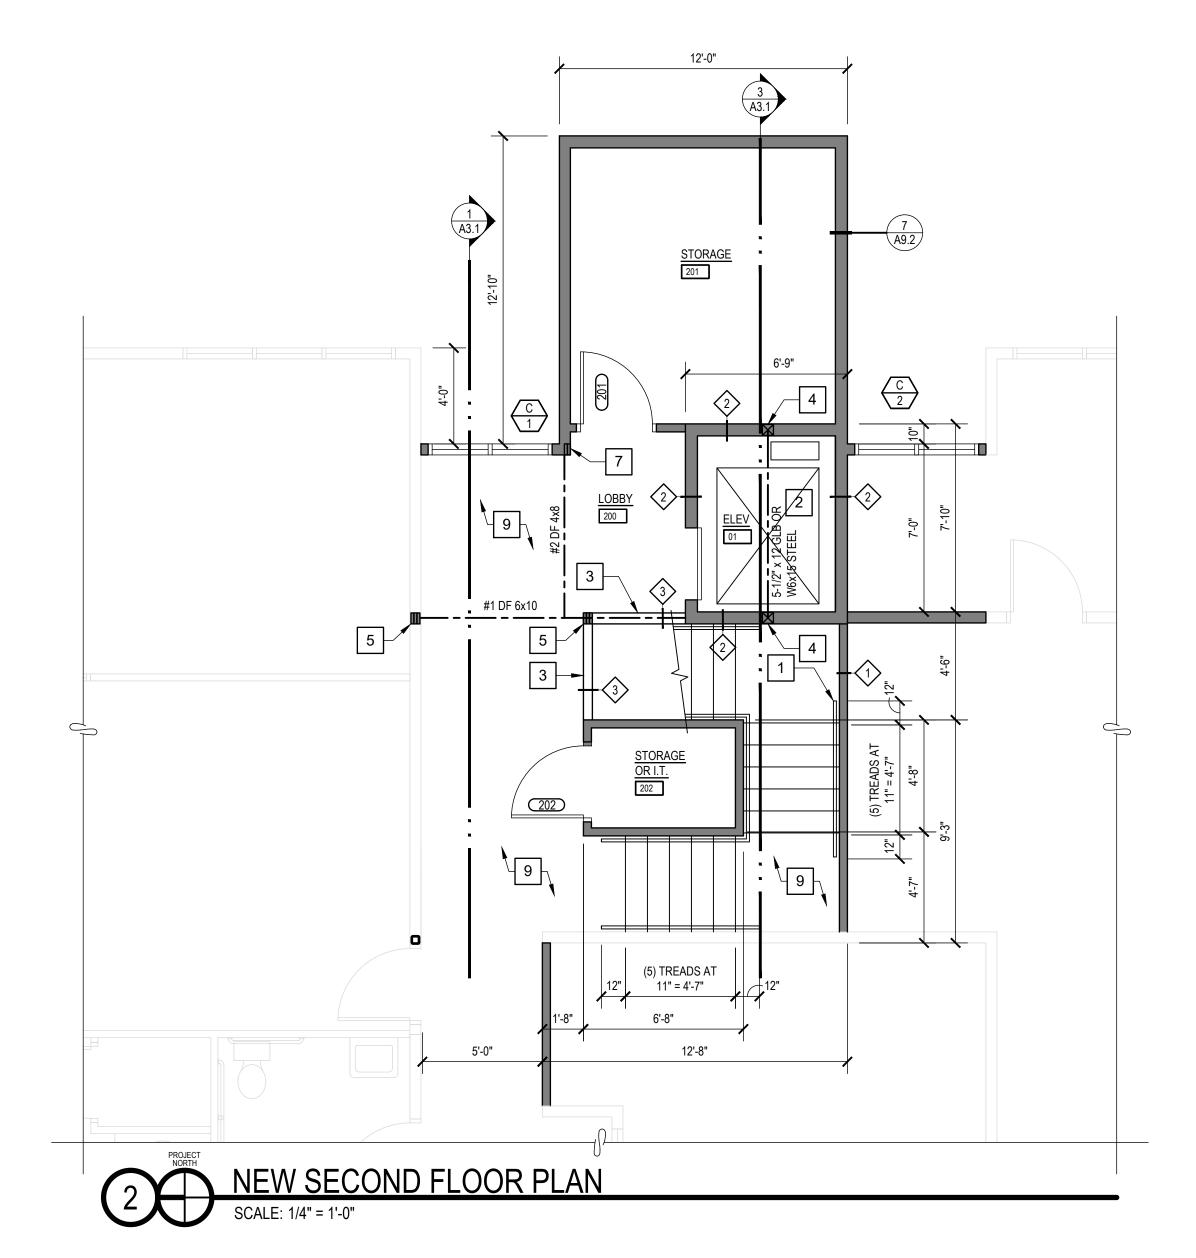

AREA OF WORK





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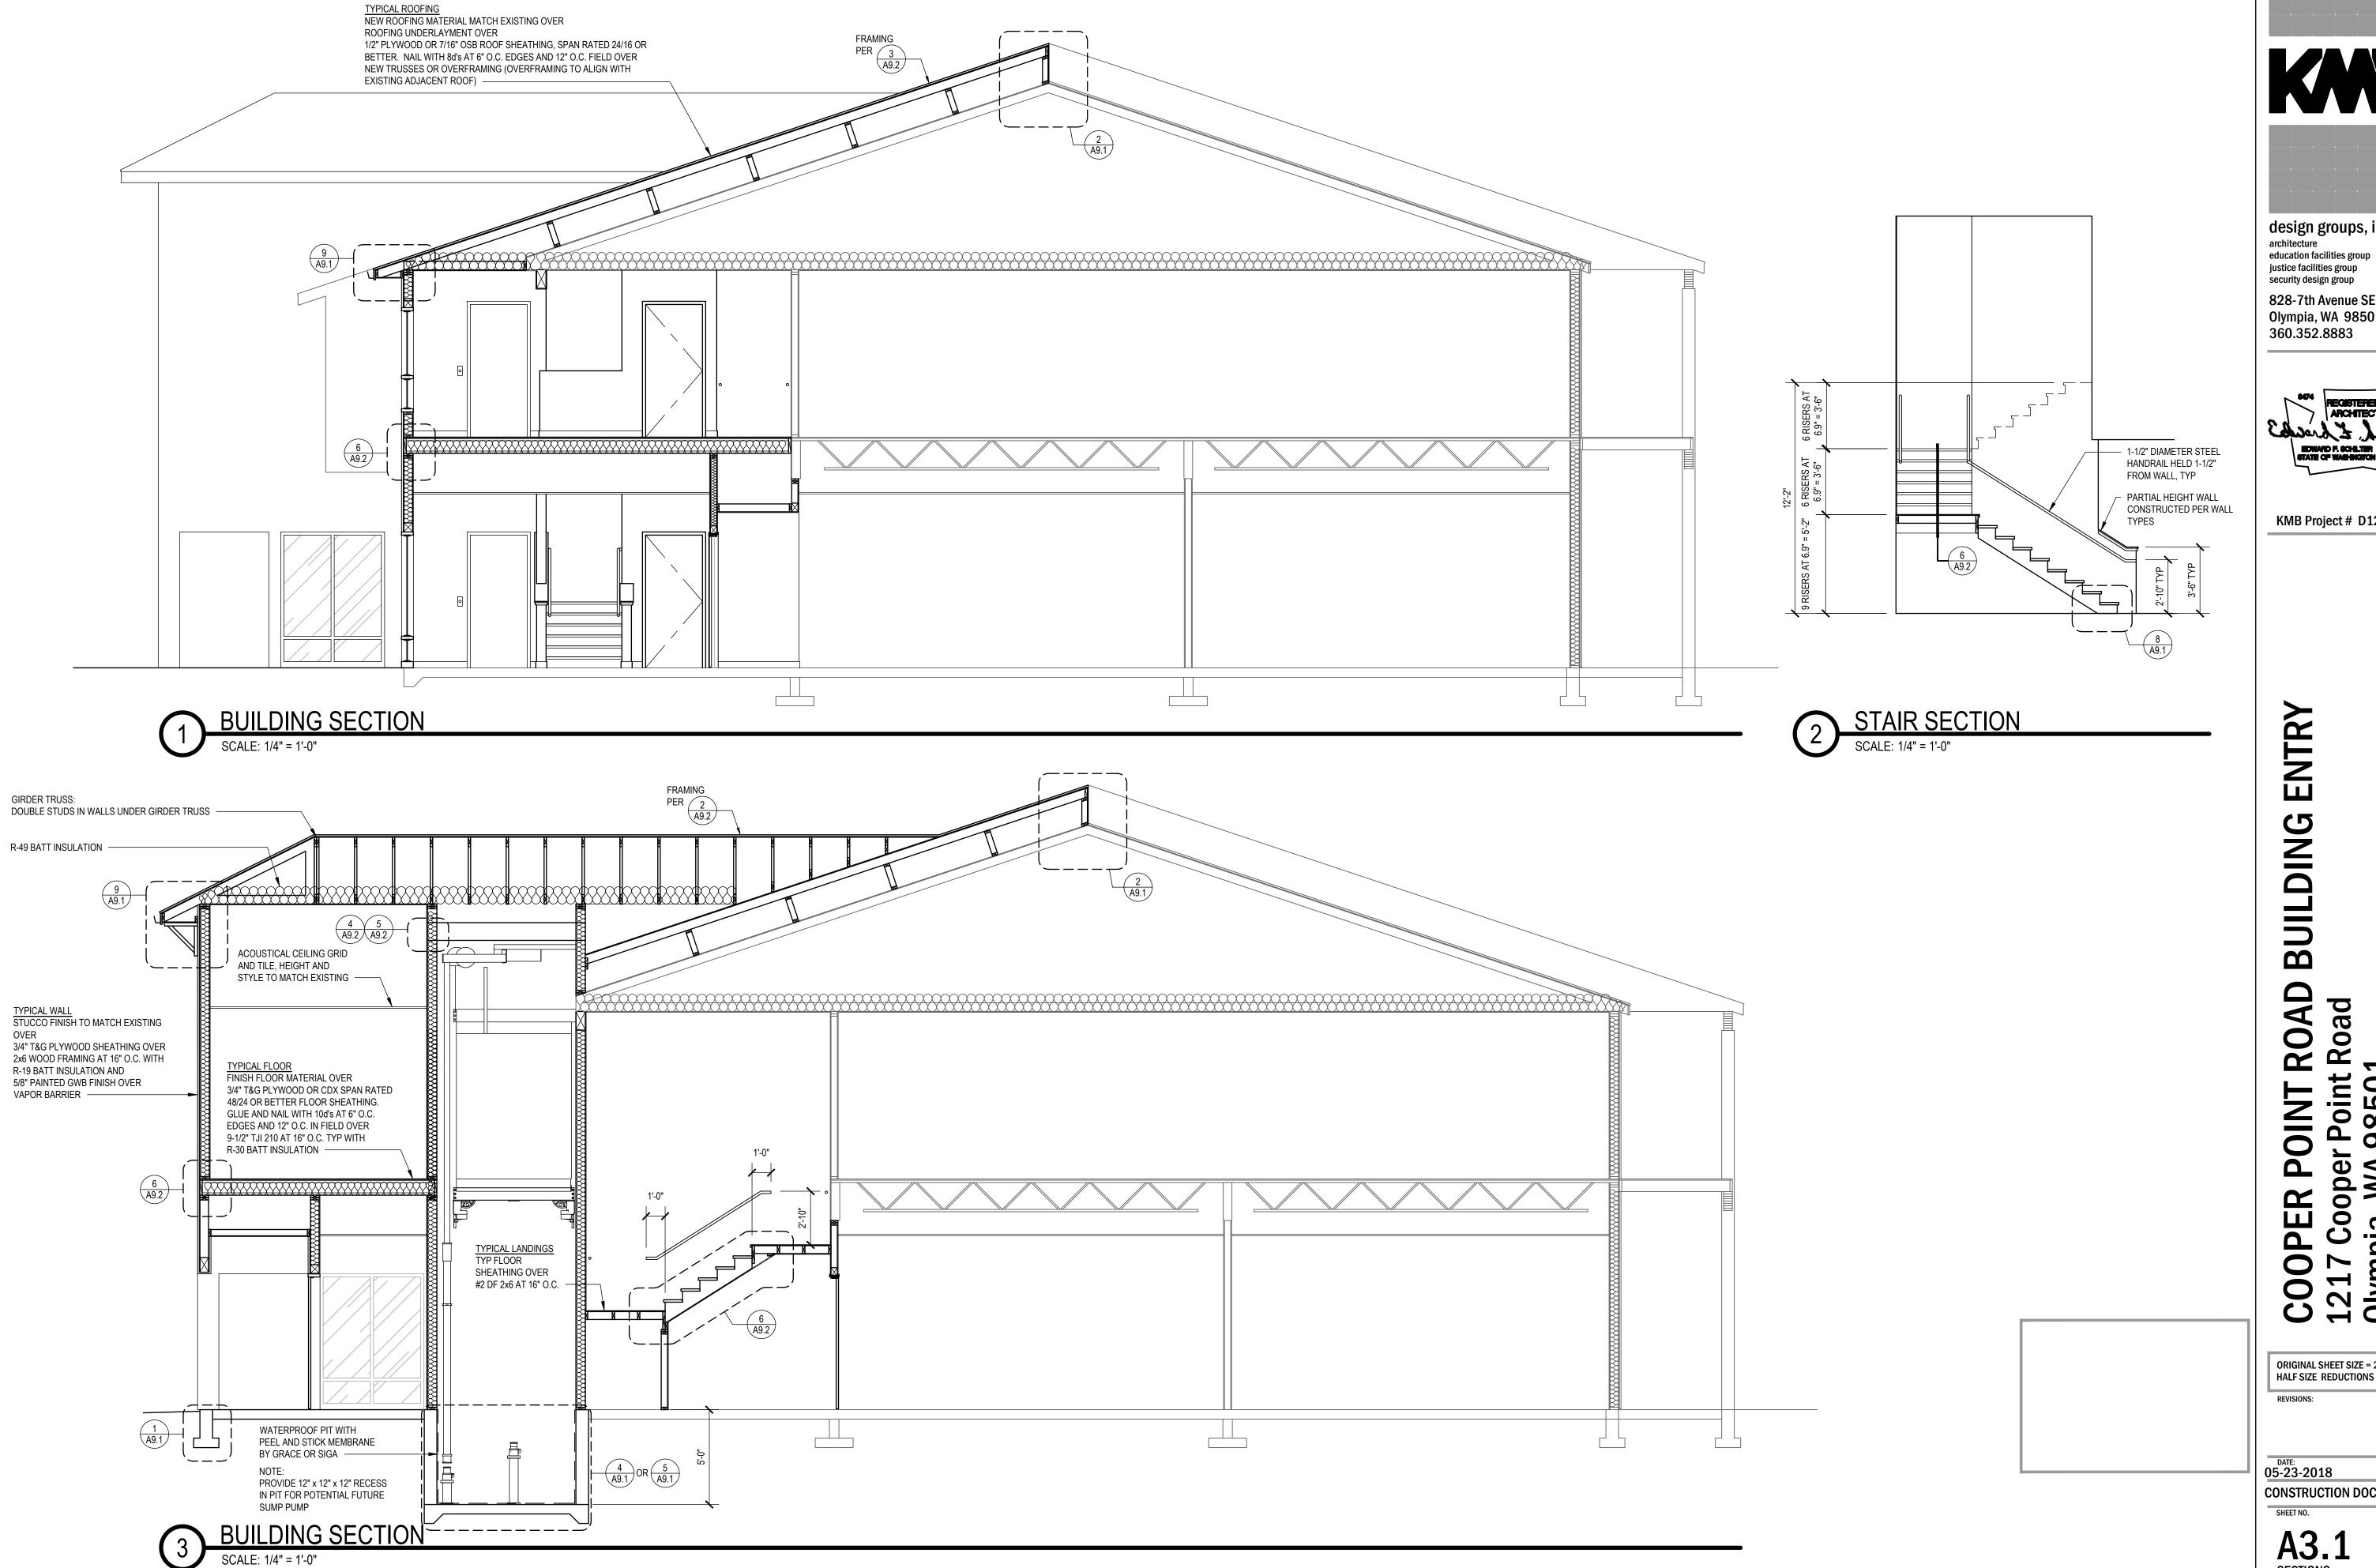
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SHEET NO.

A2.2 SECOND FLOOR PLAN





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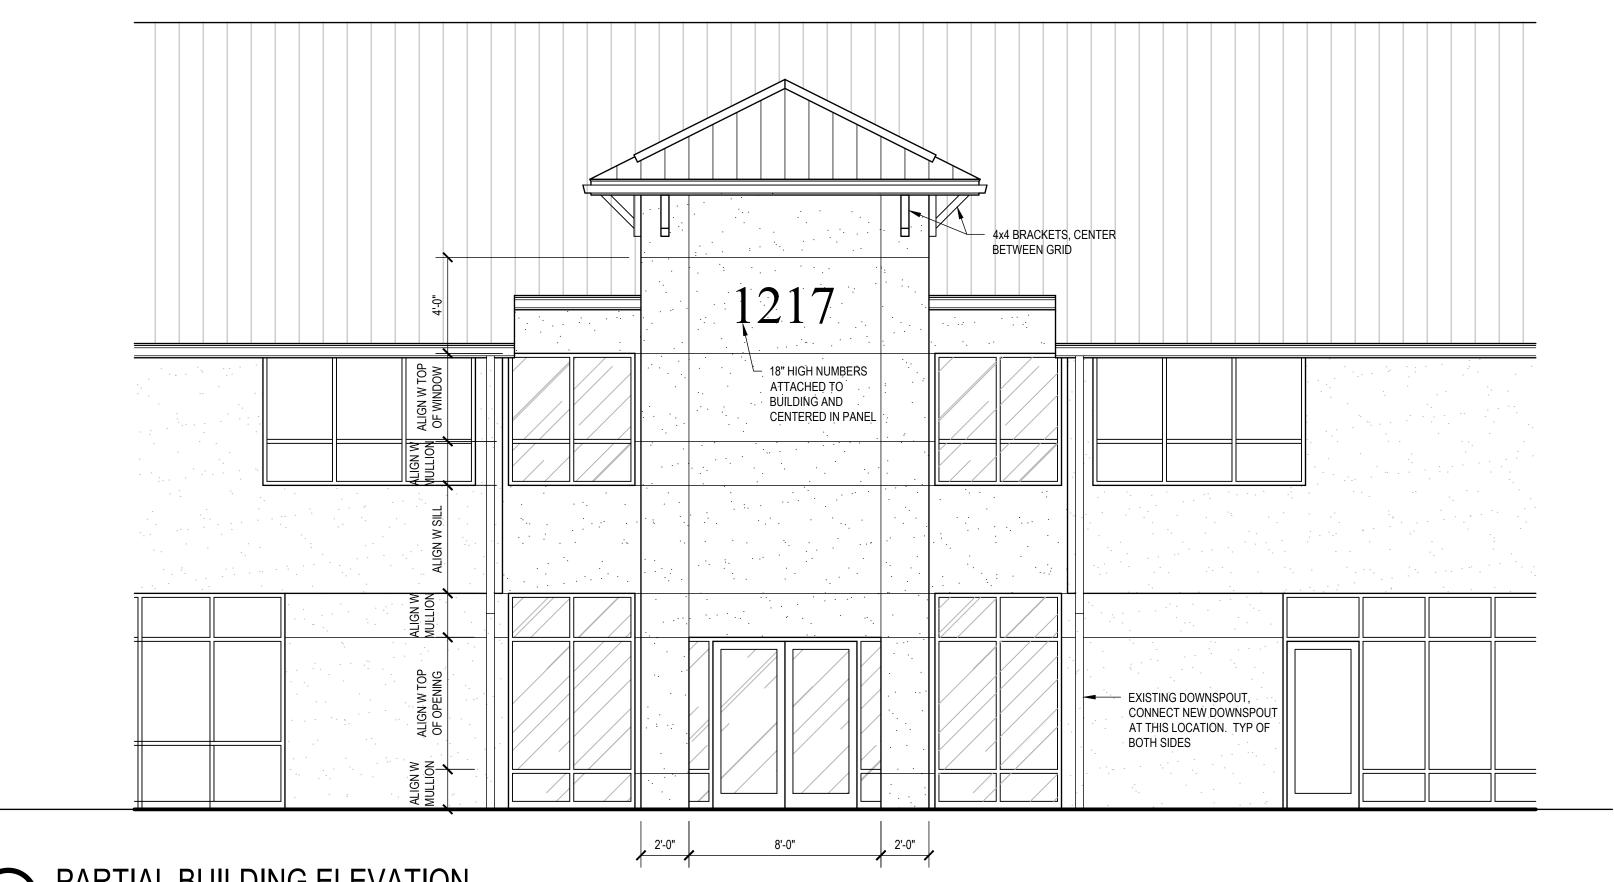
BUILDING ENTRY ROAD

COOPER POINT ROAD 1217 Cooper Point Road Olympia, WA 98501

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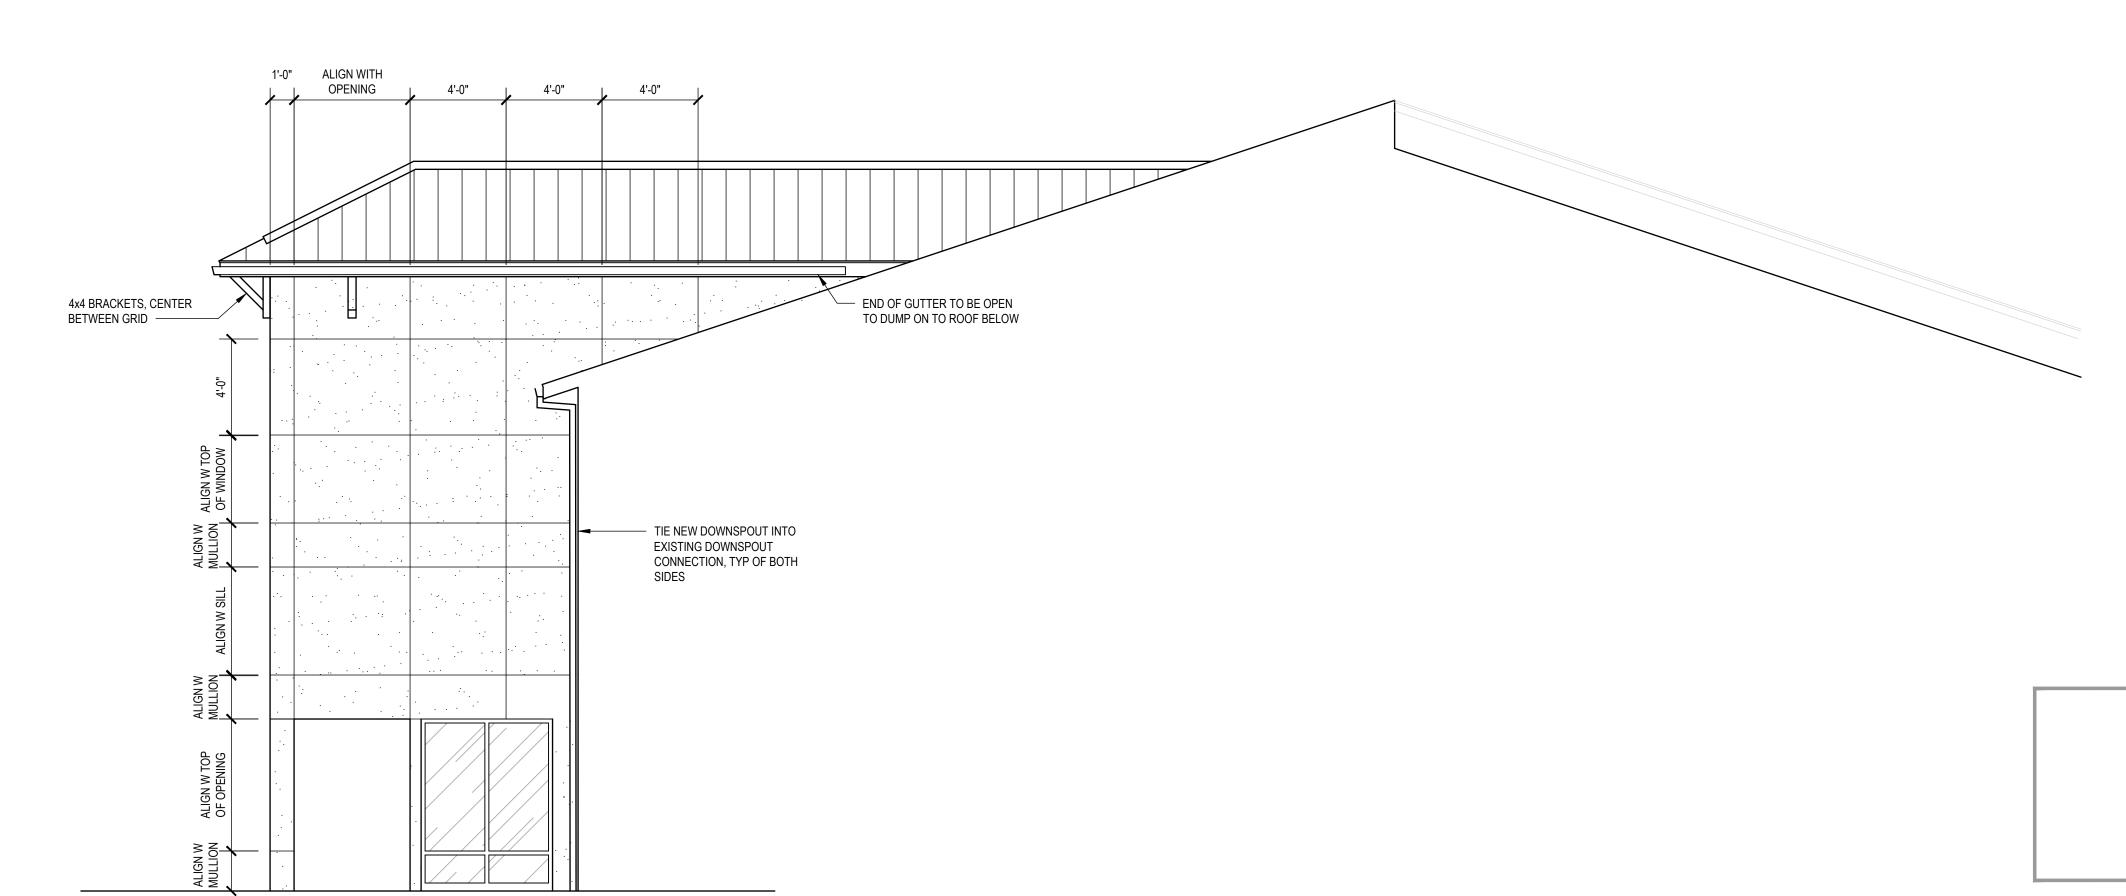
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A3.1 SECTIONS




PARTIAL BUILDING ELEVATION

SCALE: 1/4" = 1'-0"



PARTIAL BUILDING ELEVATION

SCALE: 1/4" = 1'-0"

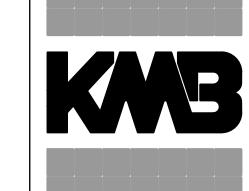

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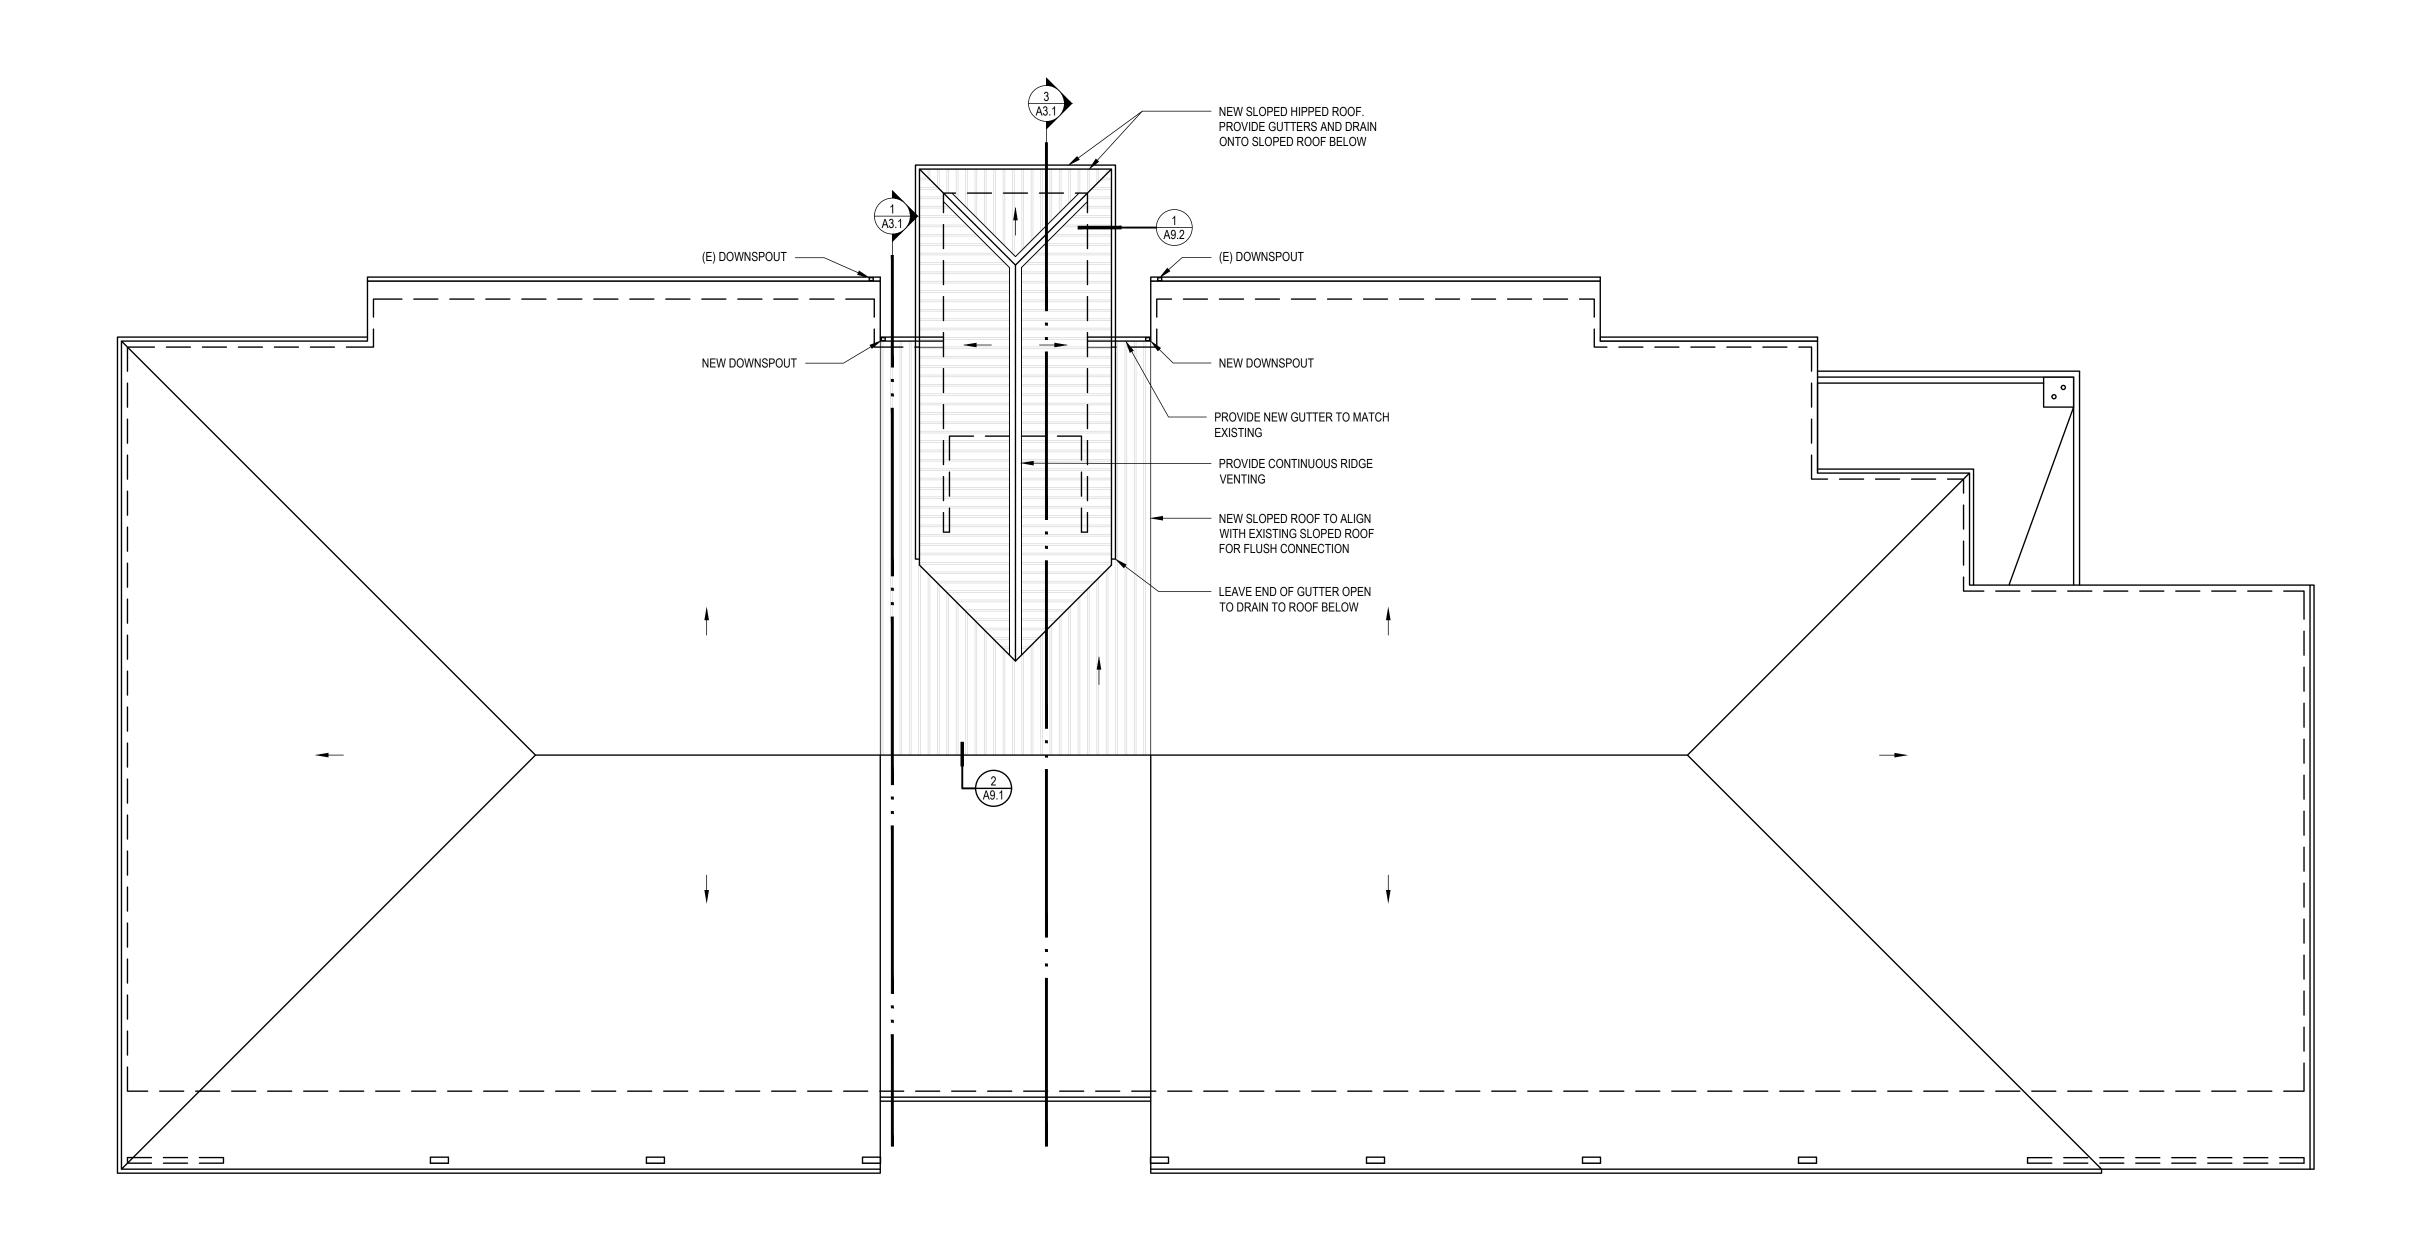
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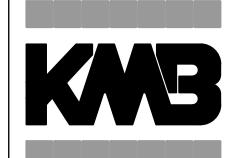
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A4.1 ELEVATIONS







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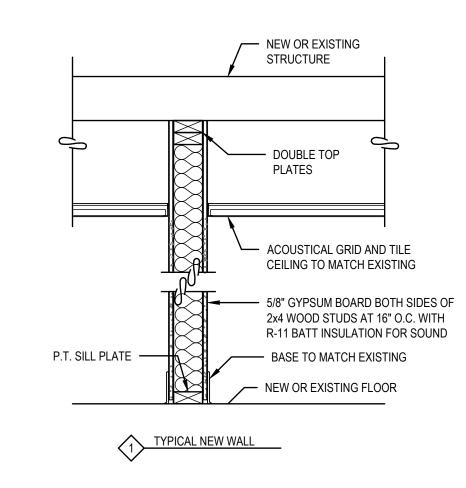
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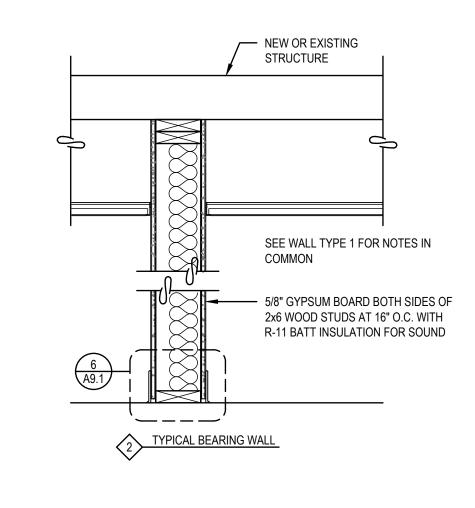
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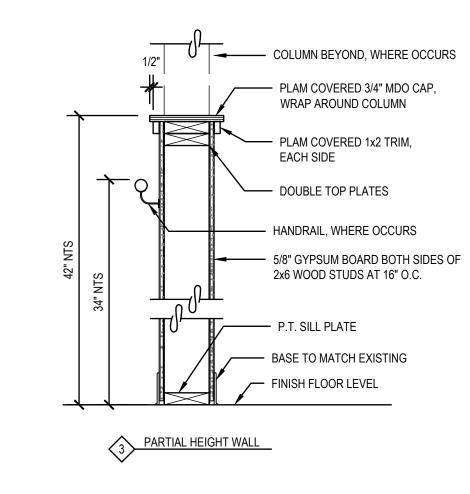
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CONSTRUCTION DOCUMENTS

A6.1
ROOF PLAN









ROOM NAME/ NO.	DOOR				FRAME											
	NO.	W	Н	THK.	MAT'L	TYPE	FIN	GLASS	MAT'L	TYPE	FIN	GLASS	1	ASSEMBLY RATING	REMARKS	DOOR NO.
FIRST FLOOR					I			1	1	1	-	1	1			l
LOBBY 100	100A	PR 3'-0"	7'-0"	1 3/4"	ALUM	С	FF	TEMP	ALUM	F-2	FF	TEMP	1	N		100
LOBBY 100	100B	3'-0"	7'-0"	1 3/4"	WD	А	PNT	TEMP	TIMELY	F-1	PNT	-	2	N		100
ELEVATOR EQUIP 101	101	3'-0"	7'-0"	1 3/4"	WD	В	PNT	TEMP	TIMELY	F-1	PNT	-	3	N		
STORAGE 102	102	3'-0"	7'-0"	1 3/4"	WD	В	PNT	TEMP	TIMELY	F-1	PNT	-	3	N		10
SECOND FLOOR	'		<u>'</u>	'			'	'	•	_	_	1	•	•		•
STORAGE 201	103A	3'-0"	7'-0"	1 3/4"	WD	В	PNT	TEMP	TIMELY	F-1	PNT	-	3	N		103
STORAGE 202	103B	3'-0"	7'-0"	1 3/4"	WD	В	PNT	TEMP	TIMELY	F-1	PNT	-	3	N		103

ABBREVIATIONS

WD SOLID CORE WOOD DOOR HARDWARE MATL MATERIAL PNT PAINT THK THICKNESS SL STAINED AND LAQUERED NOT APPLICABLE W WIDTH HOLLOW METAL

NOTES


ALL FINISHES AND HARDWARE TO MATCH EXISTING FINISHES AND HARDWARE IN BUILDING


HARDWARE GROUPS

1 - PUSH/ PULL HANDLES WITH PANIC HARDWARE AND LATCH

2-CLASSROOM LOCK WITH PANIC HARDWARE


3-STORAGE LOCK

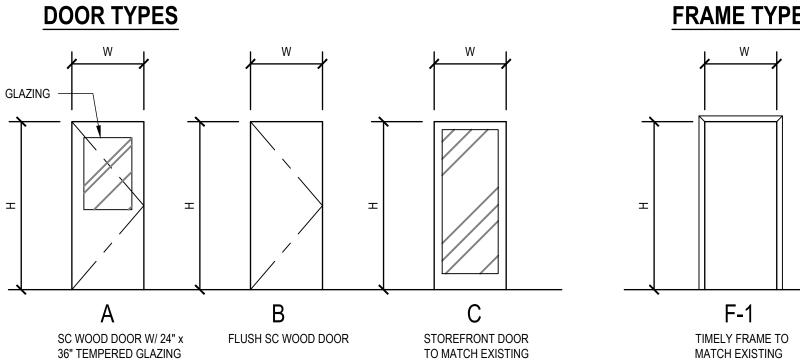

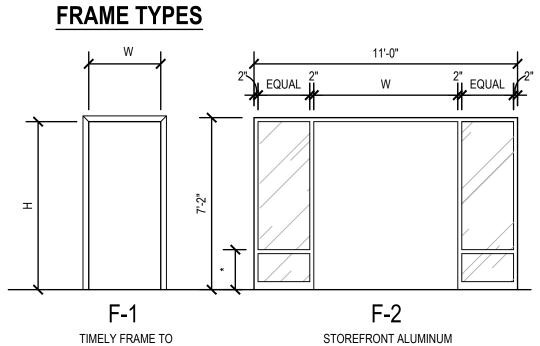


WINDOW TYPES

*NEW WINDOWS SHOULD MATCH EXISTING. ALIGN MULLION OR SILL OF NEW WINDOW WITH EXISTING

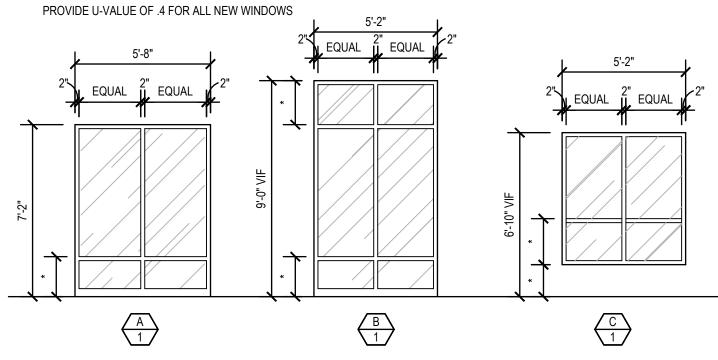



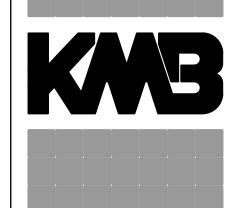

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SHEET NO. A8.1 SCHEDULES AND TYPES

