

09/12/2018 CP&D RECEIVED

WORK

PROJECT NAME:

OLY TIVOLI

INFORMATION

DESCRIPTION

PROJECT LOCATION:

1517 CAPITOL WAY S. **OLYMPIA, WA 98501**

ZONING _ 08/03/18 ISSUED FOR PERMIT ISSUED FOR REVIEW 05/23/18

DO NOT SCALE DRAWINGS. CONTRACTOR MUST VERIFY ALL DIMENSIONS AND ADVISE CONSULTANTS OF ANY ERRORS OR OMISSIONS. NO VARIATIONS OR MODIFICATIONS TO WORK SHOWN SHALL BE IMPLEMENTED WITHOUT PRIOR WRITTEN APPROVAL ALL PREVIOUS ISSUES OF THIS DRAWING APE SUPERSEDED BY THE LATEST REVISION. ALL DRAWINGS AND SPECIFICATIONS REMAIN THE PROPERTY OF MORRISON HERSHFIELD CORPORATION. NEITHER MORRISON HERSHFIELD NOR THE ARCHITECT WILL BE PROVIDING CONSTRUCTION REVIEW OF THIS PROJECT.

VERIZON WIRELESS PROPOSES TO INSTALL AN UNMANNED TELECOMMUNICATIONS FACILITY CONSISTING OF THE INSTALLATION OF (2) ROOFTOP STEALTH ANTENNA PLATFORMS, (6) NEW PANEL ANTENNAS WITH A ±76'-0" TIP HEIGHT, (6) RRU'S, (2) HYBRID CABLES AND (2) RAYCAP SPLITTER/SURGE SUPPRESSOR AT CABINETS AND (2) FAYCAP SPLITTER/SURGE SUPPRESSOR CABINETS AND (2) RAYCAP SURGE SUPPRESSOR MOUNTED WITHIN CABINET WITHIN A 8'-0"x13'-0" FENCED AREA IN A 8'-0"x13'-0" LEASE AREA LOCATED WITHIN FIRST FLOOR PARKING GARAGE. verizon

VICINITY SECTION 23 TOWNSHIP 18 RANGE 2W SITE PLAT MAPLE PARK ADDITION TO OLYMPIA BLK 5 LT 3 & 4 N 65F LT 5 **DIRECTIONS**

JURISDICTION: CITY OF OLYMPIA ZONING CLASS: PO/RM OCCUPANCY GROUP: UTILITY CONSTRUCTION TYPE: RAW LAND MONOPOLE (MONOPINE, SELF-SUPPORT)/TENANT IMPROVEMENT TAX PARCEL ID: 60800500300 PARCEL SIZE: - SQ FT (- ACRES) LATITUDE: 47°02'02 22" N LONGITUDE:

122*54'03.81" W -122 901058 GROUND ELEVATION: 137.0' AMSL STRUCTURE HEIGHT: 76'-0" (TOP OF STEALTH ANTENNA STRUCTURE)

PROJECT

60.4' (TOP OF PARAPET) 104 S.F. (EQUIPMENT ROOM) 64 S.F. (STEALTH ANTENNA STUCTURE) 64 S.F. (STEALTH ANTENNA STUCTURE)

OF DRAWINGS DESCRIPTION

SCOPE OF

SHEET COVER SHEET

SITE SURVEY SITE PLAN PROPOSED COMPOUND AND FOUIPMENT PLANS

PROPOSED EAST ELEVATION A-2 A-2.1 PROPOSED SOUTH ELEVATION
PROPOSED ANTENNA CONFIGURATION

MORRISON HERSHFIELD

600 STEWART ST, SUITE 200 SEATTLE, WA 98101 Tel: 206.268.7370

Project Info

Project Number

180096700

OLY TIVOLI

1517 CAPITOL WAY S. OLYMPIA, WA 98501

CONTACTS

IMPLEMENTATION CONTACT: TRAVIS NICHOLS VERIZON WIRELESS 3245 158TH AVE SE travis.nichols@verizonwireless.com

LEASE AREA:

APPLICANT CONTACT: VERIZON WIRELESS 3245 158TH AVE SE BELLEVUE, WA 98008 A&E CONTACT: RYLAN BROWNING MORRISON HERSHFIELD CORP 5100 SW MACADAM AVE. SUITE 500

ENGINEER OF RECORD: G. LANCE COOKE MORRISON HERSHFIELD CORP PHONE: (503) 924-2515

ALL WORK AND MATERIALS SHALL BE PERFORMED AND INSTALLED IN ACCORDANCE WITH THE CURRENT CONDITIONS OF THE FOLLOWING CODES AS ADOPTED BY THE LOCAL GOVERNING AUTHORITIES. NOTHING IN THESE PLANS IS TO BE CONSTRUED TO PERMIT WORK NOT CONFORMING TO THESE CODES: WASHINGTON STATE AND LOCAL BUILDING CODES WITH THE FOLLOWING REFERENCE CODE:

CODE COMPLIANCE

2015 INTERNATIONAL BUILDING CODE (IBC) 2015 INTERNATIONAL MECHANICAL CODE (IMC) 2015 INTERNATIONAL FIRE CODE (IFC) 2017 NATIONAL ELECTRIC CODE (NFPA 70)

COVER SHEET

05/16/18

esigner:

RF ENGINEER

APPROVALS SIGNATURE DATE REPRESENTATIVE

RB Project Manage JB

T-1

PROPERTY OWNER CONTACT: CONTACT NAME

SURVEYOR:

DUNCANSON COMPANY, INC. 145 SW 155TH ST, SUITE 102 SEATTLE, WA 98166 PHONE: (206) 244-4141

HEAD SOUTH ON DEPARTURES DR. CONTINUE STRAIGHT ONTO AIRPORT EXPRESSWAY TAKE THE WA-99 EXIT COMPANY ADDRESS 1
ADDRESS 2
PHONE: (-) XXX-XXXX


TAKE THE WA-99 EXIT TURN RIGHT ONTO S. 170TH ST. TURN RIGHT ONTO S. 170TH ST. TURN RIGHT ONTO INTERNATIONAL BLVD/PACIFIC HWY S. TURN LEFT ONTO S. 200TH ST. AND USE MIDDLE LANE TO TAKE RAMP ONTO I-5 S. FOLLOW I-5 S. TO 14TH AVE. SE IN OLYMPIA. TAKE EXIT 105 FROM I-5 S. (45.8 MI) MERGE ONTO 14TH AVE. SE STAY ON 14TH AVE. (0.5 MI) TO CAPITOL WAY S. TURN LEFT ON CAPITOL WAY S., DESTINATION IS ON THE RIGHT.

(FROM SEATTLE TACOMA INTERNATIONAL AIRPORT)

ZONING PERMIT CONTACT: CARLY NATIONS

GLOTEL, INC 3380 146TH PLACE SE, #102 PHONE: (425) 326-6050

DO NOT SCALE DRAWINGS. CONTRACTOR MUST VERIFY ALL DIMENSIONS AND ADVISE CONSULTANTS OF ANY ERRORS OR OMISSIONS. NO VARIATIONS OR MODIFICATIONS TO WORK SHOWN SHALL BE IMPLEMENTED WITHOUT PRIOR WRITTEN APPROVAL ALL PREVIOUS ISSUES OF THIS DRAWING APE SUPERSEDED BY THE LATEST REVISION. ALL DRAWINGS AND SPECIFICATIONS REMAIN THE PROPERTY OF MORRISON HERSHFIELD CORPORATION. NEITHER MORRISON HERSHFIELD NOR THE ARCHITECT WILL BE PROVIDING CONSTRUCTION REVIEW OF THIS PROJECT. **GENERAL NOTES** LINE/ANTENNA NOTES **ABBREVIATIONS** WORK SHALL COMPLY WITH ALL APPLICABLE CODES, ORDINANCES, AND REGULATIONS. ALL NECESSARY LICENSES, CERTIFICATES, ETC., REQUIRED BY AUTHORITY HAVING JURISDICTION SHALL BE PROCURED AND PAID FOR BY THE ABOVE GROUND LEVEL PLYWD ALL THREADED STRUCTURAL FASTENERS FOR ANTENNA SUPPORT ASSEMBLES SHALL CONFORM TO ASTM A307 OF ASTM A36. ALL STRUCTURAL FASIENCERS FOR STRUCTURAL STEEL FRAMING SHALL CONFORM TO ASTM F3125 GR A375. FASTENERS SHALL BE 5/8" MIN. DIA. BEARING TYPE CONNECTIONS WITH THREADS EXCLUDED FROM THE PLANE. ALL EXPOSED FASTENERS, NUTS, AND WASHERS SHALL BE GALVANIZED OTHERWISE NOTED. CONCRETE EXPANSION ANCHORS SHALL BE HILTI KWIK BOLTS UNLESS OTHER WISED NOTED. ALL ANCHORS INTO CONCRETE AIR CONDITIONING APPROXIMATELY AZIMUTH GALVANIZED GENERAL CONTRACTOR PRESSURE TREATED PROJECT MORRISON HERSHFIELD CORPORATION HAS NOT CONDUCTED, NOR DOES IT INTEND TO CONDUCT ANY INVESTIGATION GRND GROUND (P) PROPOSED AS TO THE PRESENCE OF HAZARDOUS MATERIAL, INCLUDING, BUT NOT LIMITED TO, ASBESTOS WITHIN THE CONFINES OF THIS PROJECT. MORRISON HERSHFIELD CORPORATION DOES NOT ACCEPT RESPONSIBILITY FOR THE INDEMNIFICATION, THE REMOVAL, OR ANY EFFECTS FROM THE PRESENCE OF THESE MATERIALS. IF EVIDENCE OF HAZARDOUS MATERIALS IS FOUND, WORK IS TO BE SUSPENDED AND THE OWNER NOTIFIED. THE CONTRACTOR IS NOT TO PROCEED WITH FURTHER WORK UNTIL INSTRUCTED BY THE OWNER IN WRITING. BLDG BLK GYP BD GYPSUM WALL BOARD SHALL BE STAINLESS STEEL. QTY BLOCKING HT HEIGHT HVAC HEATING VENTILATION AIR CONDITIONING QUANTITY 2. THE CONTRACTOR SHALL FURNISH ALL CONNECTION HARDWARE REQUIRED TO SECURE THE CABLES. CONNECTION HARDWARE SHALL BE STAINLESS STEEL. REQ RM RO ROW ÇLG CEILING CENTERLINE REQUIRED CONDITIONING HORIZONTAL ROOM ROUGH OPENING NORTH ARROW SHOWN ON PLANS REFERS TO TRUE NORTH. CONTRACTOR SHALL VERIFY NORTH AND NOTIFY CONSULTANT OF ANY DISCREPANCY BEFORE STARTING CONSTRUCTION. ALL MATERIAL FURNISHED UNDER THIS CONTRACT SHALL BE NEW, UNLESS OTHERWISE NOTED. ALL WORK SHALL BE GUARANTEED AGAINST DEFECTS IN MATERIALS AND WORKMANSHIP. THE CONTRACTOR SHALL REPAIR OR REPLACE AT HIS EXPENSE ALL WORK THAT MAY DEVELOP DEFECTS IN MATERIALS OR WORKMANIP WITHIN SALD PERIOD OF TIME OR FOR ONE YEAR AFTER THE FINAL ACCEPTANCE OF THE ENTIRE PROJECT, WHICHEVER IS GREATER. CONCRETE CONC CONST RIGHT OF WAY SHT SIM SPEC SF SS STL STRUCT 4. PROVIDE LOCK WASHERS FOR ALL MECHANICAL CONNECTIONS FOR GROUND CONDUCTORS. USE STAINLESS STEEL CONT CONTINUOUS INFO INFORMATION SIMIL AR DET DIA DIAG DIM DBL DN DWG INSIDE DIAMETER INSULATION INTERIOR INTERNATIONAL BUILDING CODE SPECIFICATION SQUARE FOOT STAINLESS STEEL DETAIL THE GENERAL CONTRACTOR AND EACH SUBCONTRACTOR SHALL BE RESPONSIBLE FOR VERIFYING ALL EXISTING CONDITIONS AND UTILITIES AT THE JOB SITE BEFORE WORK IS STARTED. NO CLAIMS FOR EXTRA COMPENSATION FOR WORK WHICH COULD HAVE BEEN FORESEEN BY AN INSPECTION, WHETHER SHOWN ON THE CONTRACT DOCUMENTS OR 5. THOROUGHLY REMOVE ALL PAINT AND CLEAN ALL DIRT FROM SURFACES REQUIRING GROUND CONNECTIONS. DIAMETER DIAGONAL DIMENSION INT IBC GROUND CONNECTIONS AS SHORT AND DIRECT AS POSSIBLE. AVOID SHARP BENDS. ALL BENDS TO BE A STRUCTURAL NOT, WILL BE ACCEPTED OR PAID. DOUBLE LBS POUNDS STD THE GENERAL CONTRACTOR AND EACH SUBCONTRACTOR SHALL BE RESPONSIBLE FOR VERIFYING DIMENSIONS AND SUSP SUSPENDED 7. FOR GROUNDING TO BUILDING FRAME & HATCH PLATE GROUND BARS, USE A TWO-BOLT HOLE NEMA DRILLED. DRAWING CONDITIONS AT THE JOB SITE WHICH COULD AFFECT THE WORK LINDER THIS CONTRACT. ALL MANUFACTURERS CONNECTOR SUCH AS T&B 32007 OR APPROVED EQUAL MGR MANAGER MFR MAX MECH MTL MIN MISC MANUFACTURER MAXIMUM MECHANICAL METAL RECOMMENDED SPECIFICATIONS, EXCEPT THOSE SPECIFICATIONS HEREIN, WHERE MOST STRINGENT SHALL BE COMPLIED THRU THROUGH FOR ALL EXTERNAL GROUND CONNECTIONS, CLAMPS & CADWELDS, APPLY A LIBERAL PROTECTIVE COATING OR AN ANTI-OXIDE COMPOUND SUCH AS "NO-OXIDE A" BY DEARBORN CHEMICAL COMPANY. ELECTRICAL ELEVATION TINNED TYPICAL THE CONTRACTOR SHALL VERIFY AND COORDINATE SIZE AND LOCATION OF ALL OPENINGS FOR STRUCTURAL, MECHANICAL, ELECTRICAL, PLUMBING, CIVIL, OR ARCHITECTURAL WORK. EQ EQUIF REPAIR ALL GALVANIZED SURFACES THAT HAVE BEEN DAMAGED BY THERMO-WELDING. USE ERICO T-319 GALVANIZING EQUIPMENT UNDERGROUND UG UNO MINIMUM UNLESS NOTED OTHERWISE BAR/COLD GALVANIZING PAINT. MISCELLANEOUS THE CONTRACTOR SHALL VERIFY THAT NO CONFLICTS EXIST BETWEEN THE LOCATIONS OF ANY AND ALL MECHANICAL, ELECTRICAL, PLUMBING, OR STRUCTURAL ELEMENTS, AND THAT ALL REQUIRED CLEARANCES FOR INSTALLATION AND MAINTENANCE ARE MET. NOTIFY THE CONSULTANT OF ANY CONFLICTS. THE CONSULTANT HAS THE RIGHT TO MAKE MINOR MODIFICATIONS IN THE DESIGN OF THE CONTRACT WITHOUT THE CONTRACTOR GETTING ADDITIONAL EXTERIOR N/A NIC NTS NOT APPLICABLE 10. SEAL ALL CONDUIT PENETRATIONS INTO MODULAR BUILDING WITH A SILICONE SEALANT AND ALL CONDUIT OPENINGS. VERIFY IN FIELD FIN FLR FLUOR FINISH FLOOR FLUORESCENT FOOT NOT IN CONTRA VERT 11. ALL COAXIAL CABLE WILL BE SECURED TO THE DESIGNED SUPPORT STRUCTURE AT DISTANCES NOT TO EXCEED 3' OR THE CABLE MANUFACTURES SPECIFICATIONS WHICHEVER IS LESS, WITH HARDWARE SPECIFIED IN THE COAXIAL CABLE ROUTING DETAILS OF THE SUPPLIED STRUCTURAL REPORT. WP W/ W/O ZONING WATER PROOF OC OD OUTSIDE DIAMETER DO NOT SCALE THE DRAWINGS. DIMENSIONS ARE EITHER TO THE FACE OF FINISHED ELEMENTS OR TO THE CENTER WITHOUT _ 12. THE COAXIAL ANTENNA CABLE INSTALLER SHALL BE RESPONSIBLE FOR PERFORMING AND SUPPLYING THREE (3 LINE OF ELEMENTS, UNLESS NOTED OTHERWISE, CRITICAL DIMENSIONS SHALL BE VERIFIED AND NOTIFY THE TYPEWRITTEN SWEEP TESTS (ANTENNA RETURN LOSS TEST). THIS TEST SHALL BE PERFORMED TO THE SPECIFICATIONS AND PARAMETERS OUTLINED BY THE VERIZON WIRELESS RADIO FREQUENCY THRU ENGINEER. THIS TEST SHALL BE PERFORMED PRIOR TO FINAL ACCEPTANCE OF THE SITE. (1) COPY TO BE PLACED IN SHELTER. CONSULTANT OF ANY DISCREPANCIES. THE CONTRACTOR SHALL BE RESPONSIBLE FOR DAILY CLEAN UP OF ALL TRADES AND REMOVE ALL DEBRIS FROM THE CONSTRUCTION SITE. AT THE COMPLETION OF THE PROJECT, THE CONTRACTOR SHALL THOROUGHLY CLEAN TH BUILDING, SITE, AND ANY OTHER SURROUNDING AREAS TO A BETTER THAN EXISTING CONDITION. ---- UGP ---- UG POWER CONDUIT ---- UGT ----- UG TELCO CONDUIT _ 13. THE COAXIAL ANTENNA CABLE INSTALLER SHALL BE RESPONSIBLE FOR PERFORMING AND SUPPLYING VERIZON WIRELESS WITH THREE TYPE WRITTEN TIME DOMAIN REFLECTOMETER TESTS TO VERIFY CABLE LENGTH AND TO CHECK — P — POWER CONDUIT --- T --- TELCO CONDUIT 10. THE CONTRACTOR IS RESPONSIBLE FOR ADEQUATELY BRACING AND PROTECTING ALL WORK DURING CONSTRUCTION FOR WATER DAMAGE. AGAINST DAMAGE, BREAKAGE, COLLAPSE, ETC. ACCORDING TO APPLICABLE CODES, STANDARDS, AND GOOD 08/03/18 ISSUED FOR PERMIT CONSTRUCTION PRACTICES 14. VAPOR WRAP WILL BE USED TO SEAL ALL CONNECTIONS. 15. ALL JUMPERS TO THE ANTENNAS FROM THE MAIN TRANSMISSION LINE WILL BE 1/2" DIA, AND SHALL NOT EXCEED 6'-0" 11. THE CONTRACTOR SHALL MEET ALL OSHA REQUIREMENTS FOR ALL INSTALLATIONS. 05/23/18 ISSUED FOR REVIEW 12. THE CONTRACTOR SHALL BE RESPONSIBLE FOR ALL DAMAGES TO THE EXISTING CONSTRUCTION AND REPAIR ALL DAMAGES TO BETTER THAN NEW CONSTRUCTION. THE CONTRACTOR SHALL NOTIFY THE ARCHITECT OF ANY DAMAGE TO THE BUILDING SITE OR ANY ADJACENT STRUCTURES AROUND THE PROJECT. THE CONSULTANT SHALL BE SOLE AND FINAL JUDGE AS TO THE QUALITY OF THE REPAIRED CONSTRUCTION. ANY ADDITIONAL MODIFICATIONS WHICH MUST BE 16. ALL MAIN TRANSMISSION CABLE WILL BE TERMINATED AT A VERIZON WIRELESS POLYPHASER PROTECTOR LOCATED WITHIN 1'-0" OF THE EQUIPMENT SHELTER. Date 17. ANTENNA CABLE LENGTHS HAVE BEEN DETERMINED BASED ON THESE PLANS, CABLE LENGTHS LISTED ARE APPROXIMATED AND ARE NOT INTENDED TO BE USED FOR FABRICATION DUE TO FIELD CONDITIONS ACTUAL CABLE LENGTHS REQUIRE. CONTRACTOR MUST FIELD VERIFY ANTENNA CABLE LENGTHS PRIOR TO ORDER. MADE SHALL BE MADE AT THE CONTRACTOR'S EXPENSE WHERE ONE DETAIL IS SHOWN FOR ONE CONDITION, IT SHALL APPLY FOR ALL LIKE OR SIMILAR CONDITIONS, EVEN THOUGH NOT SPECIFICALLY MARKED ON THE DRAWINGS OR REFERRED TO IN THE SPECIFICATIONS, UNLESS NOTED OTHERWISE. verizon 18. ALL MAIN CABLES WILL BE COLOR CODED AT FOUR LOCATIONS: A) AT ANTENNA PRIOR TO JUMPER, B) AT T BOTTOM OF THE TOWER, C) EXTERIOR PART OF THE WAVE GUIDE ENTRY PORT (AT THE SHELTER/CABINET WALL), D) WHERE NEW PAVING, CONCRETE SIDEWALKS OR PATHS MEET EXISTING CONSTRUCTION, THE CONTRACTOR SHALL MATCH INTERIOR OF THE SHELTER/CABINET. THE EXISTING PITCH, GRADE, AND ELEVATION SO THE ENTIRE STRUCTURE SHALL HAVE A SMOOTH TRANSITION ALL MAIN CABLES WILL BE GROUNDED AT: A) AT THE ANTENNA MOUNTING PIPE, B) MIDDLE OF THE CABLE RUN IF OVER 200', C) PRIOR TO ENTERING EQUIPMENT SHELTER/CABINET (WITHIN 1' OF ENTRY). THE CONTRACTOR SHALL MODIFY THE EXISTING FLOORS, WALL, CEILING, OR OTHER CONSTRUCTION AS REQUIRED TO GAIN ACCESS TO AREAS FOR ALL MECHANICAL, PLUMBING, ELECTRICAL, OR STRUCTURAL MODIFICATIONS. WHERE THE EXISTING CONSTRUCTION DOORS, PARTITIONS, CEILING, ETC., ARE TO BE REMOVED, MODIFIED, OR REARRANGED OR WHERE THE EXPOSED OR HIDDEN MECHANICAL, ELECTRICAL, SYSTEMS ARE ADDE OR MODIFIED, THE GENERAL CONTRACTOR SHALL REPAIR, PATCH AND MATCH ALL EXISTING CONSTRUCTION AND FINISHES OF ALL FLOORS WALLS AND CEILINGS. WHERE CONCRETE MASONRY CONSTRUCTION IS MODIFIED, THE CONTRACTOR SHALL TOOTH IN ALL NEW CONSTRUCTION TO MATCH THE EXISTING BOND. WHERE CONCRETE CONSTRUCTION IS MODIFIED, THE CONTRACTOR SHALL VERIFY THE EXACT DETAILS TO BE USED FOR CONSTRUCTION. ALL WORK SHALL BE COVERED UNDER THE GENERAL CONTRACT 20. PROVIDE AT LEAST 6" OF SLACK IN THE MAIN COAXIAL CABLES AT THE TOWER TOP TO PROVIDE FOR FUTURE Implementation Teams CONNECTOR REPLACEMENT 21. PROVIDE A CABLE DRIP LOOP AT THE BOTTOM OF THE TOWER BELOW THE TOWER BOTTOM GROUND CONNECTIONS AND AS THE CABLE TRANSITIONS TO THE SHELTER/CABINET. 22. ANTENNAS AND COAX TO BE PROVIDED BY VERIZON WIRELESS, CONTRACTOR TO COORDINATE DELIVERY. 16. VERIFY ALL EXISTING DIMENSIONS PRIOR TO PERFORMING WORK. PROJECT INFORMATION 17. VERIFY LOCATION OF ALL BURIED UTILITIES PRIOR TO ANY EXCAVATION. 18. THE GENERAL CONTRACTOR SHALL BE RESPONSIBLE FOR APPLYING FOR COMMERCIAL POWER IMMEDIATELY UPON AWARD OF CONTRACT. THE GENERAL CONTRACTOR IS REQUIRED TO KEEP ALL DOCUMENTATION RECEIVED FROM THE POWER COMPANY, ACKNOWLEDGING APPLICATION FOR POWER, WITHTEN AND VERBAL DISCUSSIONS WITH THE POWER A&E Team: THIS IS AN UNMANNED FACILITY AND RESTRICTED ACCESS EQUIPMENT AND WILL BE USED FOR THE TRANSMISSION OF RADIO SIGNALS FOR THE PURPOSE OF PROVIDING PUBLIC CELLULAR SERVICE. 2. VERIZON WIRELESS CERTIFIES THAT THIS TELEPHONE EQUIPMENT FACILITY WILL BE SERVICED ONLY BY VERIZON WIRELESS EMPLOYEE SERVICE PERSONNEL FOR REPAIR PURPOSES ONLY. THIS FACILITY IS UNOCCUPIED AND NO DESIGNED FOR HUMAN OCCUPANCY THUS IT IS NOT OPEN TO THE PUBLIC. 19. THE GENERAL CONTRACTOR SHALL OBTAIN WRITTEN CONFIRMATION OF THE EXPECTED DATE OF COMPLETION OF THE POWER CONNECTION FROM THE POWER COMPANY MORRISON HERSHFIELD 20. IF THE POWER COMPANY IS UNABLE TO PROVIDE THE POWER CONNECTION BY OWNER'S REQUIRED DATE, THE GENERAL CONTRACTOR SHALL PROVIDE AND MAINTAIN A TEMPORARY GENERATOR UNTIL THE POWER COMPANY CONNECTION IS COMPLETED. COSTS ASSOCIATED WITH THE TEMPORARY GENERATOR TO BE APPROVED BY THE OWNER. 600 STEWART ST, SUITE 200 SEATTLE, WA 98101 3. THIS FACILITY WILL CONSUME NO UNRECOVERABLE ENERGY. Tel: 206.268.7370 4. NO POTABLE WATER SUPPLY IS TO BE PROVIDED AT THIS LOCATION. 21. IF THE GENERAL CONTRACTOR FAILS TO TAKE NECESSARY MEASURES AS DESCRIBED IN NOTES 18, 19 AND 20 IMPORTANT NOTICE 5. NO WASTE WATER WILL BE GENERATED AT THIS LOCATION. ABOVE, THE GENERAL CONTRACTOR SHALL PROVIDE A TEMPORARY GENERATOR AT NO COST TO THE OWNER roiect Info 22. PLANS PART OF THIS SET ARE COMPLEMENTARY, INFORMATION IS NOT LIMITED TO ONE PLAN, DRAWINGS AND SPECIFICATIONS ARE INSTRUMENTS OF SERVICE AND SHALL REMAIN THE PROPERTY OF THE ARCHITECT, WHETHER THE PROJECT FOR WHICH THEY ARE MADE IS EXECUTED OR NOT. THEY ARE NOT TO BE USED BY THE OWNER ON OTHER PROJECTS OR EXTENSION TO THIS PROJECT EXCEPT BY AGREEMENT IN WRITING AND WITH APPROPRIATE COMPENSATION TO THE ARCHITECT, THESE PLANS WERE PREPARED TO BE SUBMITTED TO GOVERNMENTAL BUILDING AUTHORITIES FOR REVIEW FOR COMPLIANCE WITH APPLICABLE CODES AND IT IS THE SOLE RESPONSIBILITY OF THE AUTHORITIES AND CONTENT OF THE MACHINE PURPOR THE OFFICE AND THE SOLE RESPONSIBILITY OF THE 6. NO SOLID WASTE WILL BE GENERATED AT THIS LOCATION. THE EXISTING CONDITIONS REPRESENTED HEREIN ARE BASED ON VISUAL OBSERVATIONS AND INFORMATION PROVIDED BY OTHERS. MORRISON HERSHFIELD CORPORATION CANNOT GUARANTEE THE CORRECTNESS NOR COMPLETENESS OF THE EXISTING CONDITIONS SHOWN AND ASSUMES NO RESPONSIBILITY THEREOF. CONTRACTOR AND HIS SUB-CONTRACTORS SHALL VISIT THE SITE AND VERIFY ALL EXISTING CONDITIONS AS REQUIRED FOR PROPER EXECUTION OF PROJECT. REPORT ANY CONFLICTS OR DISCREPANCIES TO THE CONSULTANT PRIOR TO CONSTRUCTION. 7. VERIZON WIRELESS MAINTENANCE CREW (TYPICALLY ONE PERSON) WILL MAKE AN AVERAGE OF ONE TRIP PER MONTH **OLY TIVOLI** 1517 CAPITOL WAY S. OWNER AND/OR CONTRACTOR TO BUILD ACCORDING TO APPLICABLE BUILDING CODES. OLYMPIA, WA 98501 23. IF CONTRACTOR OR SUB-CONTRACTOR FIND IT NECESSARY TO DEVIATE FROM ORIGINAL APPROVED PLANS, THEN IT IS THE CONTRACTOR'S AND THE SUB-CONTRACTOR'S RESPONSIBILITY TO PROVIDE THE ARCHITECT WITH 4 COPIES OF THE PROPOSED CHANGES FOR HIS APPROVAL BEFORE PROCEEDING WITH THE WORK. IN ADDITION THE CONTRACTOR AND SUB-CONTRACTORS SHALL BE RESPONSIBLE FOR PROCURING ALL NECESSARY APPROVALS FROM THE BUILDING AUTHORITIES FOR THE PROPOSED CHANGES BEFORE PROCEEDING WITH THE WORK. THE CONTRACTOR AND SUB-CONTRACTORS SHALL BE RESPONSIBLE FOR PROCURING ALL NECESSARY INSPECTIONS AND APPROVALS FROM BUILDING AUTHORITIES OF THE PROPOSED CHANGES BEFORE PROCEEDING WITH THE WORK. THE CONTRACTOR AND SUB-CONTRACTORS SHALL BE RESPONSIBLE FOR PROCURING ALL NECESSARY INSPECTIONS AND APPROVALS FROM BUILDING MICH THE PROPOSED CHANGE THE VERY THE PROCURING ALL NECESSARY INSPECTIONS AND APPROVALS FROM BUILDING MICH THE PROPOSED CHANGE THE PROPOSED SPECIAL INSPECTION NOTE **LEGEND BUILDING/WALL/DETAIL SECTION** SPECIAL INSPECTIONS REQUIRED: LARGE SCALE DETAIL GENERAL NOTES BUILDING AUTHORITIES DURING THE EXECUTION OF THE WORK. 24. IN EVERY EVENT, THESE CONSTRUCTION DOCUMENTS AND SPECIFICATIONS SHALL BE INTERPRETED TO BE A MINIMUM ACCEPTABLE MEANS OF CONSTRUCTION BUT THIS SHALL NOT RELIEVE THE CONTRACTOR, SUB-CONTRACTOR, AND/OR SUPPLIER/MANUFACTURER FROM PROVIDING A COMPLETE AND CORRECT JOB WHEN ADDITIONAL ITEMS ARE REQUIRED TO THE MINIMUM SPECIFICATION. IF ANY ITEMS NEED TO EXCEED THESE MINIMUM SPECIFICATIONS TO PROVIDE A COMPLETE, ADEQUATE AND SAFE WORKING CONDITION, THEN IT SHALL BE THE DEEMED AND UNDERSTOOD TO BE INCLUDED IN THE DRAWINGS, FOR EXAMPLE, IF AN ITEM AND/OR PIECE OF EQUIPMENT REQUIRES A LARGER WIRE SIZE (I.E. ELECTRICAL WIRE), STRONGER OR LARGER PIPING, INCREASED QUANTITY (I.E. STRUCTURAL ELEMENTS), REDUCED SPACING, AND/OR INCREASED LENGTH (I.E. BOLT LENGTHS, BAR LENGTHS) THEN IT SHALL BE DEEMED AND UNDERSTOOD TO BE INCLUDED IN THE BID/PROPOSAL. THESE DOCUMENTS ARE MEANT AS A GUIDE AND ALL ITEMS REASONABLY INFERRED SHALL BE DEEMED TO BE INCLUDED. SOILS COMPLIANCE PRIOR TO FOUNDATION INSPECTION CONCRETE OVER 4000 PSI (6½ SACK MIX) AT 28 DAYS ☐ VERIFICATIONS OF MILL REPORT ☐ SPRAYED -ON- FIREPROOFING ✓ DETAIL NUMBER AND SYMBOLS - DETAIL NUMBER ☐ IDENTIFICATION OF STEEL AND ☐ STRUCTURAL MASONRY AT JOB SITE ☐ STRUCTURAL STEEL CONCRETE PLACEMENT AT SLAB ON GRADE ADHESIVE BOLTS IN CONCRETE ☐ PRESTRESSED CONCRETE WRITTEN CERTIFICATION FOR PROPER SHEET NUMBER - SHEET NUMBER Project Number ☐ ALL FIELD WELDING PLACEMENT OF REINFORCEMENTS AT ☐ ANCHOR BOLTS INSTALLATION 180096700 05/16/18 SLAB ON GRADE AND PLACEMENT IN CONCRETE ☐ REINFORCING PLACEMENT TENUNDATION EXCAVATION AND FILL ☐ HIGH STRENGTH BOLTING ☐ DESIGNER SPECIFIED (SEE SHEET#__) Designer: NCLUDING UTILITY TRENCHES REFERENCE **ELEVATION DETAIL BUG** ☐ OTHER RB RR 25. THESE CONTRACT DOCUMENTS AND SPECIFICATIONS SHALL NOT BE CONSTRUED TO CREATE A CONTRACTUAL RELATIONSHIP OF ANY KIND BETWEEN THE ARCHITECT AND THE CONTRACTOR. CERTIFICATION OF BUILDING PAD, DETAIL NUMBER Professional of Record Project Manager GEOTECHNICAL ENGINEER OF RECORD LJB 26. CONTRACTOR & ANY SUBCONTRACTORS TO MAINTAIN KEEPING THE ROAD ACCESS GATE LOCKED AT ALL TIMES. SUBMITTAL DOCUMENTS FOR DEFERRED SUBMITTAL ITEMS SHALL BE SUBMITTED TO THE ARCHITECT OR ENGINEER OF RECORD, WHO SHALL REVIEW THEM AND FORWARD THEM TO THE BUILDING OFFICIAL WITH A NOTATION INDICATING THAT THE DEFERRED SUBMITTAL DOCUMENTS HAVE BEEN REVIEWED AND THAT THEY HAVE BEEN FOUND TO BE IN GENERAL CONFORMANCE WITH THE DESIGN OF THE BUILDING. THE DEFERRED AND SUBMITTAL ITEMS SHALL NOT BE INSTALLED UNTIL THEIR DESIGN AND SUBMITTAL THE DESIGN OF THE BUILDING. THE DEFERRED AND SUBMITTAL THEM SHALL NOT BE INSTALLED UNTIL THEIR DESIGN AND SUBMITTAL DOCUMENTS HAVE BEEN APPROVED BY THE BUILDING OFFICIAL. Revision No: Sheet No: IN RAWLAND CONDITIONS, TOWER FOUNDATION STRUCTURAL STEEL TO BE GROUNDED PRIOR TO CONCRETE POUR. TOWER FOUNDATION STRUCTURAL STEEL TO BE CONNECTED TO PERMANENT GROUND ROD PRIOR TO TOWER ERECTION. TOWER GROUND MUST BE MAINTAINED AT ALL TIMES. REFERENCED WHERE DETAILED T-20

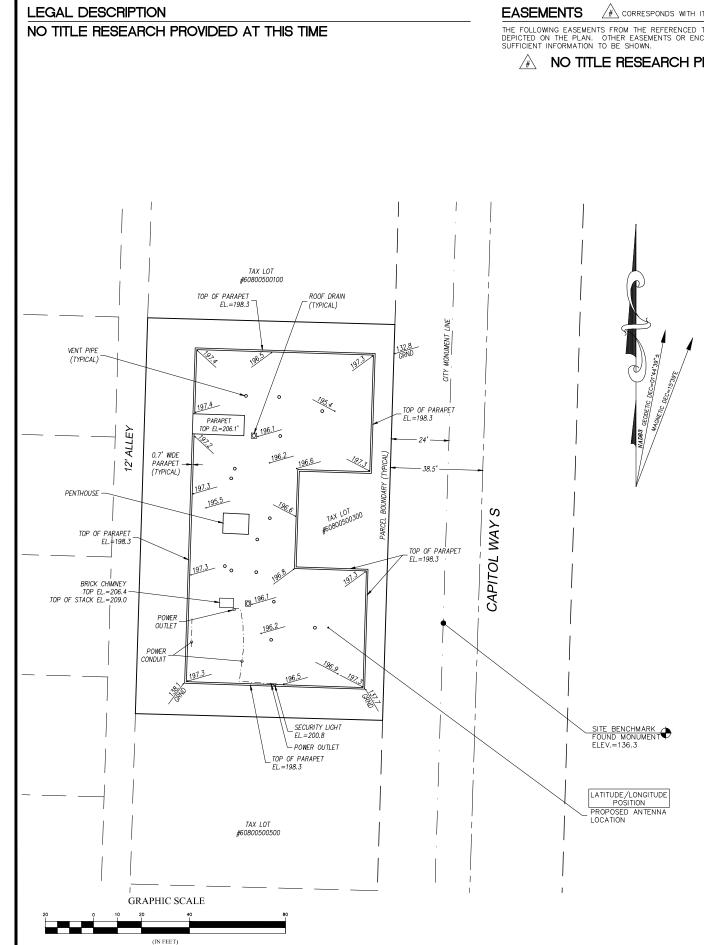

SITE DETAIL

1 inch = 20 ft. 1 inch = 40 ft. (11x17 SHEET)

CORRESPONDS WITH ITEM NUMBER IN 'SCHEDULE B' OF TITLE REPORT.

THE FOLLOWING EASEMENTS FROM THE REFERENCED TITLE REPORT CONTAIN SUFFICIENT INFORMATION TO BE DEPICTED ON THE PLAN. OTHER EASEMENTS OR ENCUMBRANCES, IF ANY, MAY AFFECT THE PROPERTY, BUT LACK SUFFICIENT INFORMATION TO BE SHOWN.

NO TITLE RESEARCH PROVIDED AT THIS TIME

BUILDING HEIGHT NOTE

AVERAGE GROUND ELEVATION IS 137.9 FEET: HEIGHTS BASED ON THIS ELEVATION ARE AS FOLLOWS: AVERAGE ROOF HT.=59.4' PARAPET HT.=60.4' PENTHOUSE ROOF HT.=68.2' CHIMNEY STACK HT.=71.1

14TH AVE SE

MAPLE PARK AVE SE 17TH AVE SE

> 18TH AVE S - SITE

15TH AVE SW

LATITUDE/LONGITUDE POSITION

COORDINATE DATA AT PROPOSED ANTENNA LOCATION NAVD 88

NAD 83 LAT - 47.033950° N LONG - 122.901058° W



BENCHMARK IS BASED ON WSRN PUGET SOUND REFERENCE NETWORK.

ELEV.= 137.9 FEET

ELEVATION DERIVED USING GPS. ACCURACY MEETS OR EXCEEDS 1A STANDARDS AS DEFINED ON THE FAA ASAC INFORMATION SHEET 91:003.

- NO TITLE RESEARCH PROVIDED AT THIS TIME.
 CALCULATED BOUNDARY MAY CHANGE UPON RECEIPT
 OF TITLE.
- FIELD WORK CONDUCTED IN MARCH, 2018. BASIS OF BEARING: WASHINGTON STATE PLANE COORDINATE SYSTEM, SOUTH ZONE (NAD83).
- UNDERGROUND UTILITIES SHOWN HEREON, IF ANY, WERE DELINEATED FROM SURFACE EVIDENCE AND/OR UTILITY COMPANY RECORDS. CRITICAL LOCATIONS SHOULD BE VERIFIED PRIOR TO DESIGN AND CONSTRUCTION.

LEGEND

- SUBJECT BOUNDARY LINE - RIGHT-OF-WAY CENTERLINE - RIGHT-OF-WAY LINE - ADJACENT BOUNDARY LINE ---- SECTIONAL BREAKDOWN LINE OVERHEAD POWER LINE BURIED POWER LINE - BURIED GAS LINE OVERHEAD TELEPHONE LINE - BURIED TELEPHONE LINE BURIED WATER LINE - BURIED SANITARY SEWER - BURIED STORM DRAIN · · - DITCH LINE/FLOW LINE ROCK RETAINING WALL VEGETATION LINE - CHAIN LINK FENCE WOOD FENCE BARBED WIRE/WIRE FENCE △ TRANSFORMER -Q- FIRE HYDRANT X SECURITY LIGHT M GATE VALVE P POWER VAULT WATER METER ☑ UTILITY BOX Q FIRE STAND PIPE Ø UTILITY POLE IRRIGATION CONTROL CV ← POLE GUY WIRE ☐ CATCH BASIN, TYPE DI GAS VALVE CATCH BASIN, TYPE ROOF DRAIN — SIGN T TELEPHONE VAULT BOLLARD TEL. MANHOLE □ MAIL BOX TELEPHONE RISER .234.21 SPOT ELEVATION

1) ALL FLEVATIONS SHOWN ARE ABOVE MEAN SEALEVEL (AMSL) AND ARE REFERENCED TO THE NAVD88 DATUM

2) ALL TOWER, TREE AND APPURTENANCE HEIGHTS ARE ABOVE GROUND LEVEL (AGL) AND ARE ACCURATE TO \pm 0.5 FEET OR \pm 1% OF TOTAL HEIGHT, WHICHEVER IS GREATER.

TREE LEGEND

DECIDUOUS TREE AL=ALDER MP=MAPLE DS=DECIDUOUS MA=MADRONA AL12 - TRUNK DIAMETER (IN) OK=OAK CH=CHERRY

EVERGREEN TREE CF=CFDAR DF=DOUGLAS FIR HE=HEMLOCK PI=PINE EVG=EVERGREEN

HEIGHT AGL IF MEASURED

NO IE:
TREE DRIP LINES ARE NOT TO SCALE. TREE SYMBOLS
REFERENCE TRUNK LOCATION ONLY. TRUNK DIAMETERS
WERE APPROXIMATED AT 3.5 TO 4' ABOVE GROUND LEVEL.
TREES APOWN ARE FOR REFERENCE ONLY AND OTHER
TREES AND VEGETATION MAY EXIST.

SITE INFORMATION

TAX LOT NUMBER 60800500300 1517 CAPITOL WAY S OLYMPIA, WA 98501 SITE ADDRESS SITE CONTACT JOHN PERANZI 253-921-5377 PO/RM (CITY OF OLYMPIA) TO BE DETERMINED PHONE NUMBER ZONING TOTAL LOT AREA PROJECT AREA TO BE DETERMINED

SURVEY REFERENCE

RECORD OF SURVEY PER A.F. NO. 4194030, RECORDS OF THURSTON COUNTY.

BOUNDARY DISCLAIMER

THIS PLAN DOES NOT REPRESENT A BOUNDARY SURVEY SUBJECT AND ADJACENT PROPERTY LINES ARE DEPICTED USING FIELD-FOUND EVIDENCE AND RECORD INFORMATION.

CAUTION!

VICINITY MAP

- NOT TO SCALE

UNDERGROUND UTILITIES EXIST IN THE AREA AND UTILITY INFORMATION SHOWN MAY BE INCOMPLETE. ONE—THAT IN THE INCOMPLETE.

ATE LAW REQUIRES THAT CONTRACTOR CONTACT THE
ONE—CALL UTILITY LOCATE SERVICE AT LEAST 48
HOURS BEFORE STARTING ANY CONSTRUCTION.

1-800-424-5555

verizon



10900 NE 8TH ST., SUITE 810 BELLEVUE, WA 98004 Tel: 425.451.1301 Fax: 425.451.1369



DUNCANSON Company, Inc.

145 SW 155th Street, Suite 102 Seattle, Washington 98166 Phone 206.244.4141 Fax 206.244.4455

OLY TIVOLI 1517 CAPITOL WAY S

OLYMPIA, WA 98501 THURSTON COUNTY

THIS DRAWING WAS CREATED FOR THE EXCLUSIVE USE OF THE CLIENT NAMED HEREO AND IS NOT TO BE USED IN WHOLE OR IN PRANT WITHOUT WRITTEN AUTHORIZATION FROM SAID CLIENT. ©2017, DUNCANSON COMPANY, INC.

LD. CREW: FLD. BOOK: 483/11 DRAWN BY: LAC 99544 2154 JOB #: DATE: 03/16/18

RI	EVISIONS	
DATE	DESCRIPTION	BY




SHEET TITLE EXISTING SITE SURVEY SEC 23, TWP 18 N, RNG 2 W, WM


> SHEET NUMBER SV₁


DO NOT SCALE DRAWINGS. CONTRACTOR MUST VERIFY ALL DIMENSIONS AND ADVISE CONSULTANTS OF ANY ERRORS OR MOSISIONS. NO VARIATIONS OR MODIFICATIONS TO WORK SHOWN SHALL BE IMPLEMENTED WITHOUT PRIOR WRITTEN APPROVAL ALL PREVIOUS ISSUES OF THIS DRAWING ARE SUPERSEDED BY THE LATEST REVISION. ALL DRAWINGS AND SPECIFICATIONS REMAIN THE PROPERTY OF MORRISON HERSHFIELD CORPORATION. NEITHER MORRISON HERSHFIELD NOR THE ARCHITECT WILL BE PROVIDING CONSTRUCTION REVIEW OF THIS PROJECT. NOTE:
THIS IS NOT A SURVEY. ALL INFORMATION AND TRUE NORTHHAVE BEEN OBTAINED FROM EXISTING DRAWINGS AND
JURISDICTIONAL GIS INFORMATION AND ARE APPROXIMATE. 15TH AVE. SW TAX LOT: 31300500100 ZONING: R-6-12 TAX LOT: 60800500100 ZONING: PO/RM ZONING TAX LOT: 31300500200 ZONING: R-6-12 _ A-1.1 PROPERTY LINE (103.0'±) 0 08/03/18 ISSUED FOR PERMIT _____ ISSUED FOR REVIEW 05/23/18 TAX LOT: ✓ INGRESS Ś 31300500300 WAY EGRESS > ZONING: R-6-12 verizon - Proposed Verizon Wireless 8'-0"x13'-0" Equipment Lease Area Located in Basement Parking Garage Implementation Team: PROPOSED VERIZON WIRELESS 8'x8' FRP ANTENNA SHROUD (DESIGNED BY OTHERS) 12' ALLEY TAX LOT: ROOFTOP 31300500400 ZONING: R-6-12 TAX LOT: 60800500300 A&E Team: - PROPOSED VERIZON WIRELESS 8'x8' FRP ANTENNA SHROUD (DESIGNED BY OTHERS) TAX LOT: MORRISON HERSHFIELD 600 STEWART ST, SUITE 200 SEATTLE, WA 98101 Tel: 206.268.7370 31300500501 ZONING: R-6-12 Project Info: **OLY TIVOLI** 1517 CAPITOL WAY S. OLYMPIA, WA 98501 PROPERTY LINE (103.0'±) TAX LOT: 31300500502 ZONING: R-6-12 19'-6" SITE PLAN TAX LOT: 60800500500 ZONING: PO/RM TAX LOT: - EXISTING ADJACENT PROPERTY LINE (TYP) 31300500600 ZONING: R-6-12 Know what's below. Call before you dig. 24"x36" SCALE: 1" = 20'-0" SITE PLAN 11"x17" SCALE: 1" = 40'-0"




Project Number:	Start Date:
180096700	05/16/18
Drafter:	Designer:
RB	RB
Project Manager:	Professional of Record:
LJB	LC
Revision No:	Sheet No:

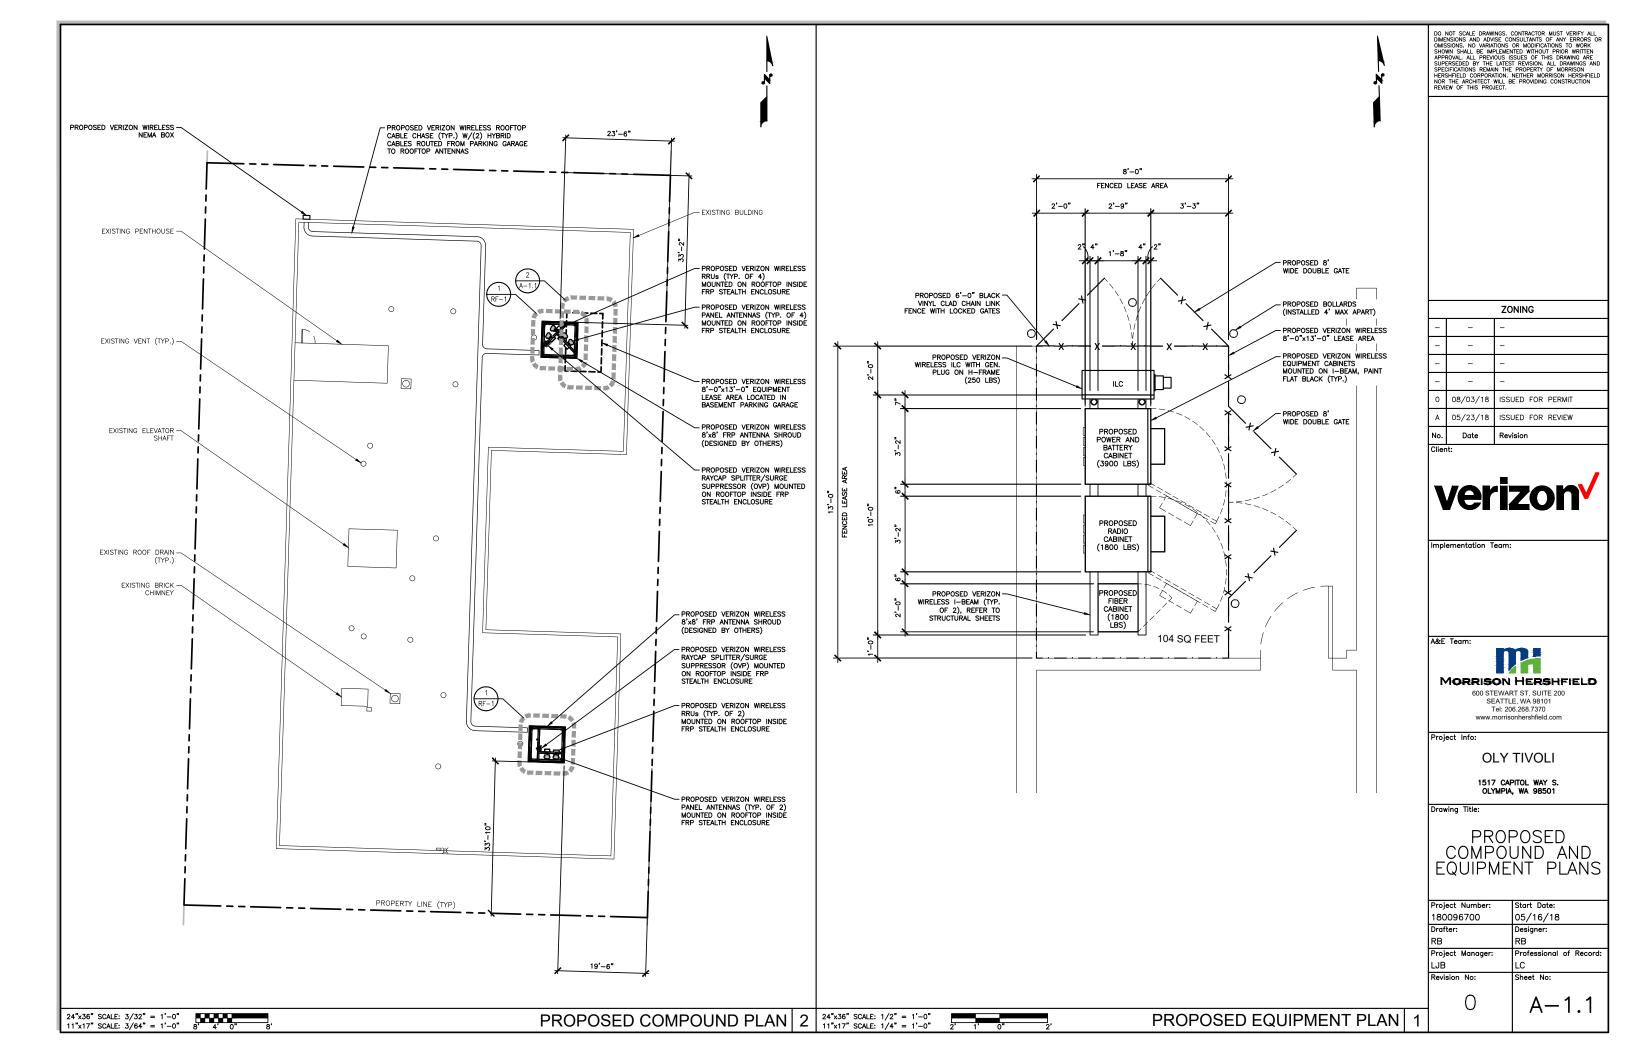

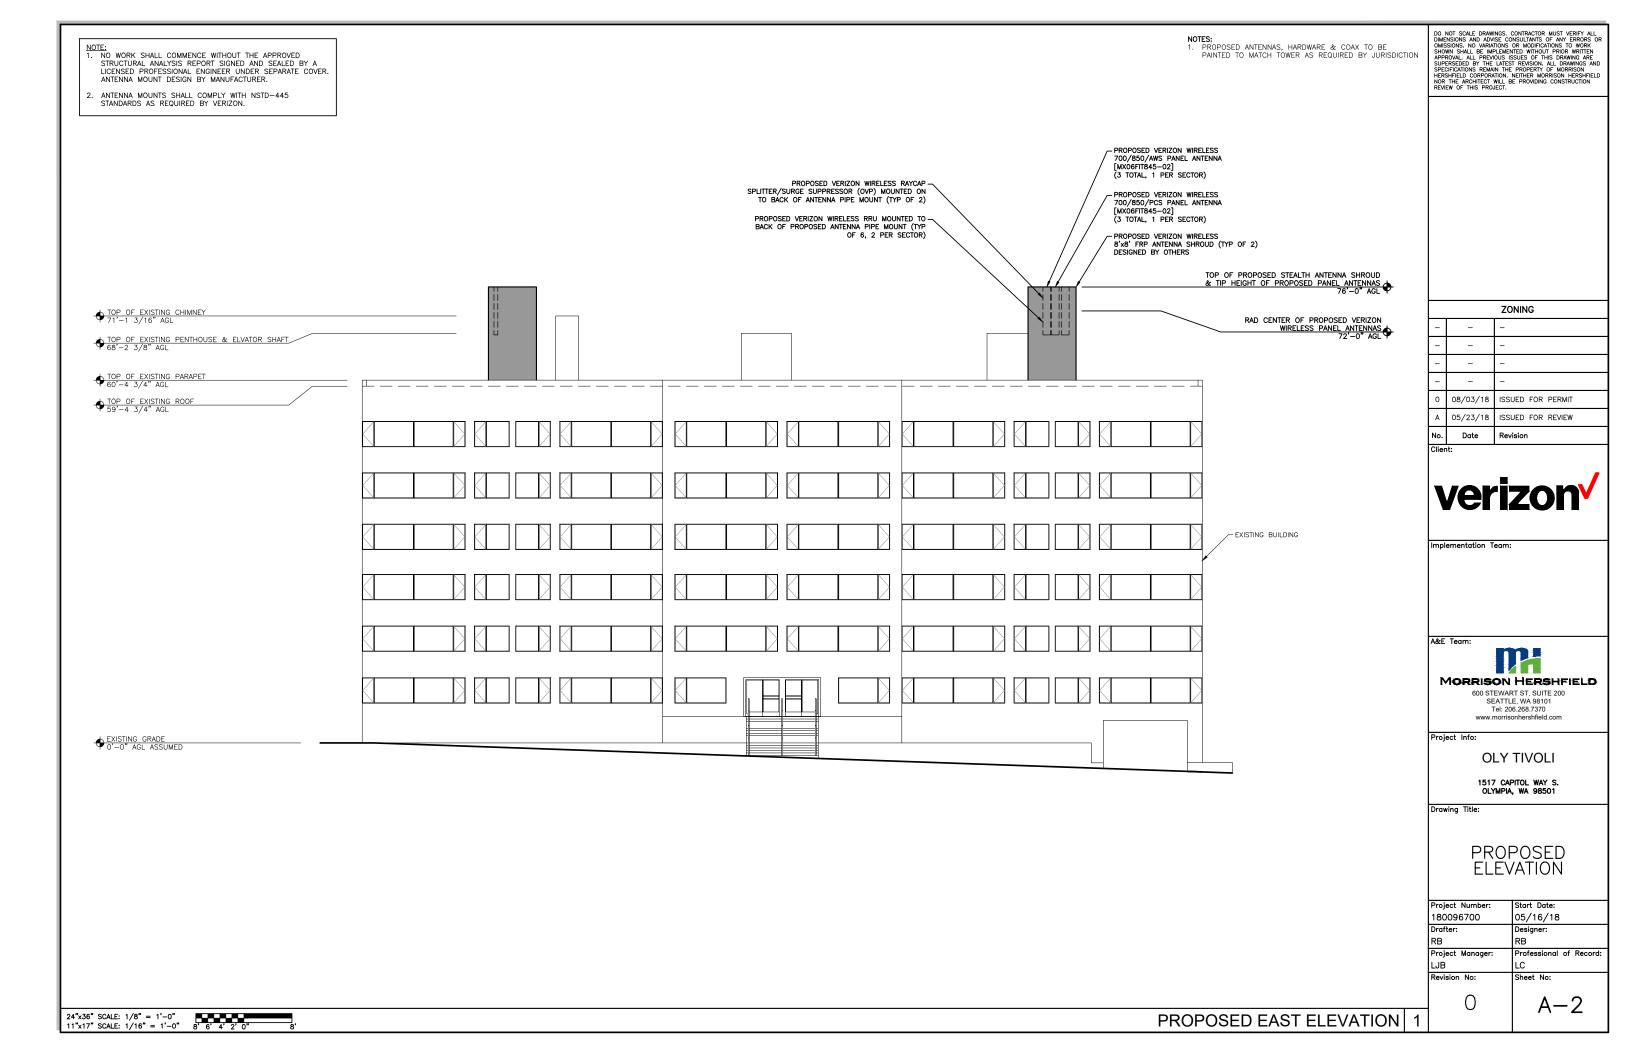

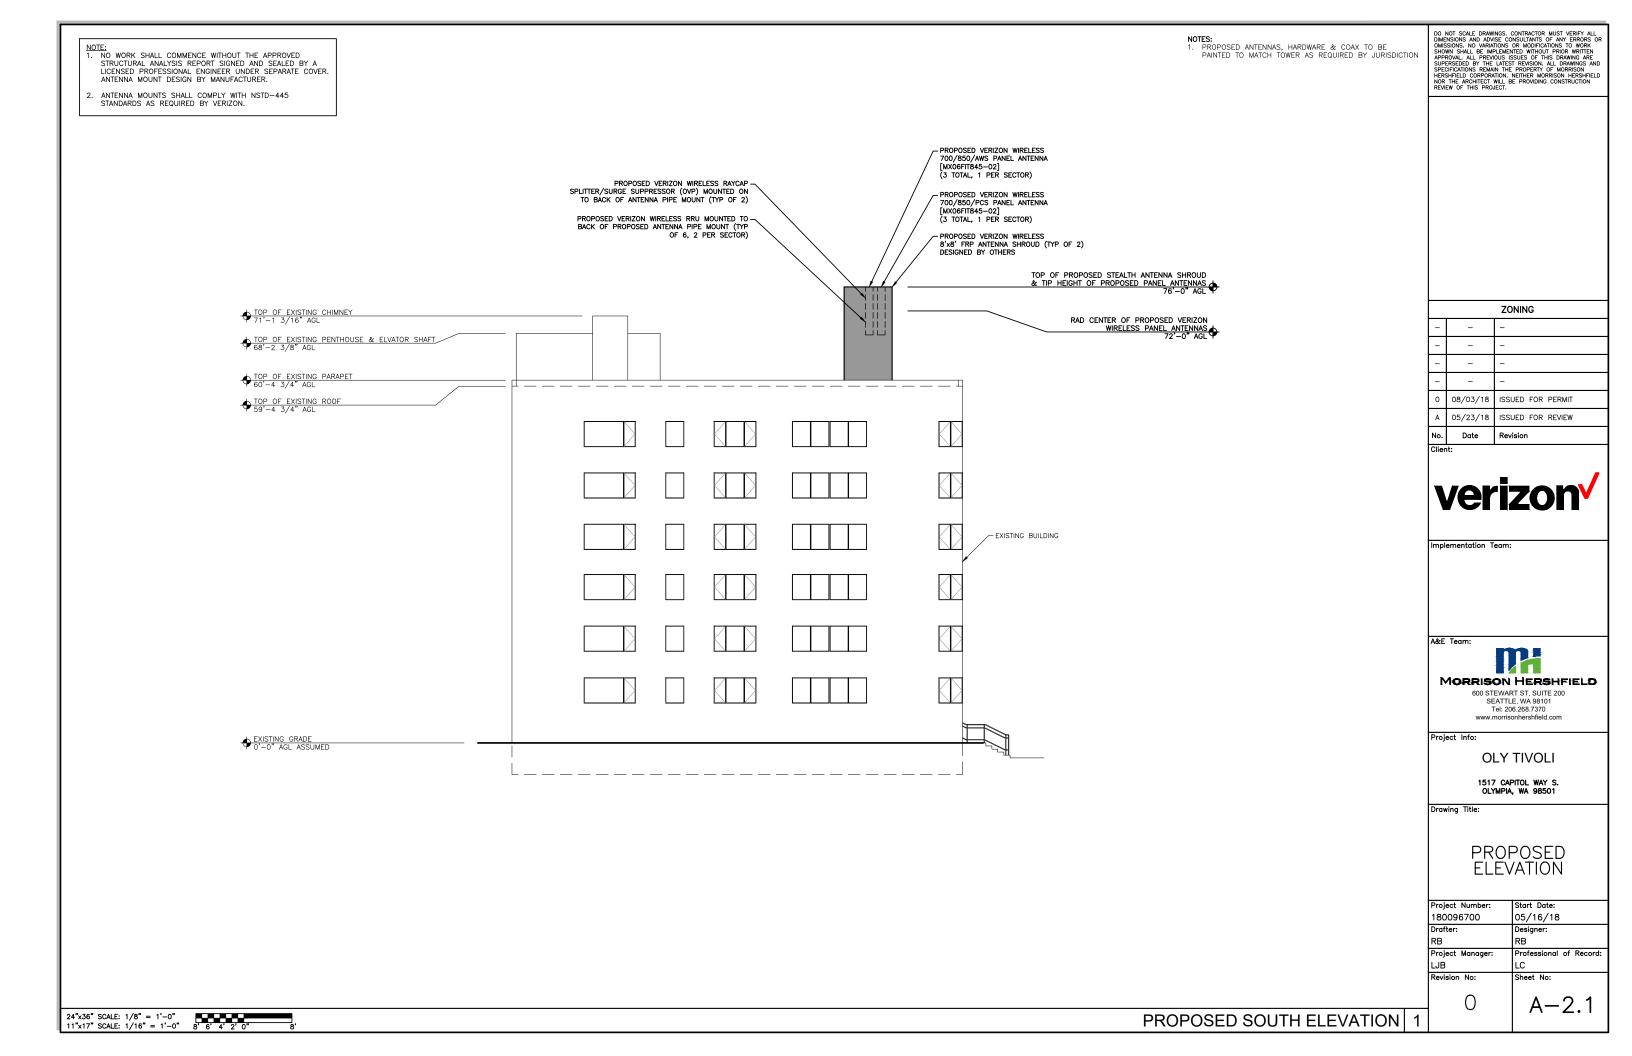

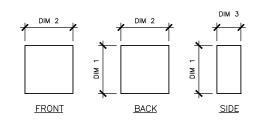


	QTY	DIM 1	DIM 2	DIM 3	WEIGHT
RRU 4449 B13/B5	3	18.0"	13.2"	9.4"	70.0 LBS
RRU 8843 B66A	3	18.0"	13.2"	11.3"	75.0 LBS

NOTES:
1. INSTALL UNITS PER MANUFACTURER SPECIFICATIONS

24"x36" SCALE: NOT TO SCALE 11"x17" SCALE: NOT TO SCALE

PROPOSED RRU DIMENSIONS | 4

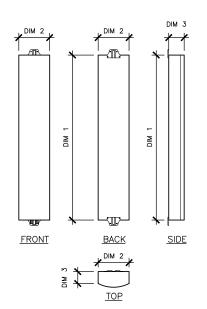


	QTY	DIM 1	DIM 2	DIM 3	WEIGHT
SECTOR ALPHA					
MX06FIT845-02	2	95.9"	15.4"	10.7"	51 LBS
SECTOR BETA					
MX06FIT845-02	2	95.9"	15.4"	10.7"	51 LBS
SECTOR GAMMA					
MX06FIT845-02	2	95.9"	15.4"	10.7"	51 LBS

- 1. INSTALL ANTENNAS PER MANUFACTURER SPECIFICATIONS
 2. CONTRACTOR TO TORQUE ALL MOUNTING HARDWARE
 PER MANUFACTURER SPECIFICATIONS

24"x36" SCALE: NOT TO SCALE 11"x17" SCALE: NOT TO SCALE

PROPOSED ANTENNA DIMENSIONS 3

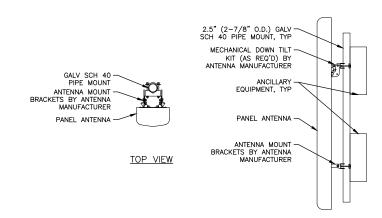


			PROPOS	SED ANTEN	INA AND COAX SCHE	DULE					
SECTOR ALPHA	AZIMUTH	RAD CENTER	NUMBER OF ANTENNAS	VENDOR	MODEL	ELEC TILT	MECH DOWNTILT	NUMBER OF FEEDERS	FEEDER TYPE	FEEDER LENGTH	ADDITIONAL EQUIPMENT
700/850/PCS LTE	50°	72'-0"	1	JMA	MX06FIT845-02	2*	0.	1	HYBRID	250'-X"	(1) RRU 4449 (1) RRU 8843
700/850/AWS LTE	50°	72'-0"	1	JMA	MX06FIT845-02	2*	0.	ļ	חושמוח	250 -X	(1) OVP
SECTOR BETA	AZIMUTH	RAD CENTER/ TIP HEIGHT	NUMBER OF ANTENNAS	VENDOR	MODEL	ELEC TILT	MECH DOWNTILT	NUMBER OF FEEDERS	FEEDER TYPE	FEEDER LENGTH	ADDITIONAL EQUIPMENT
700/850/PCS LTE	185*	72'-0"	1	JMA	MX06FIT845-02	2*	0,	1	HYBRID	335'-0"	(1) RRU 4449 (1) RRU 8843
700/850/AWS LTE	185°	72'-0"	1	JMA	MX06FIT845-02	2*	0.	ļ	חושמוח	335 -0	(1) OVP
SECTOR GAMMA	AZIMUTH	RAD CENTER/ TIP HEIGHT	NUMBER OF ANTENNAS	VENDOR	MODEL	ELEC TILT	MECH DOWNTILT	NUMBER OF FEEDERS	FEEDER TYPE	FEEDER LENGTH	ADDITIONAL EQUIPMENT
700/850/PCS LTE	300°	72'-0"	1	JMA	MX06FIT845-02	2*	0,		_		(1) RRU 4449
700/850/AWS LTE	300°	72'-0"	1	JMA	MX06FIT845-02	2*	0.	_	_	_	(1) RRU 8843

NOTIES:

1. ADJUST PIPE MOUNTS AS REQUIRED TO ACCOMMODATE REQUIRED ANTENNA SPACING.

2. ANTENNA MOUNTS SHALL COMPLY WITH NSTD-445 STANDARDS AS REQUIRED BY VERIZON.

3. PROVIDED 24" CENTER TO CENTER SPACE FOR ALL ANTENNAS

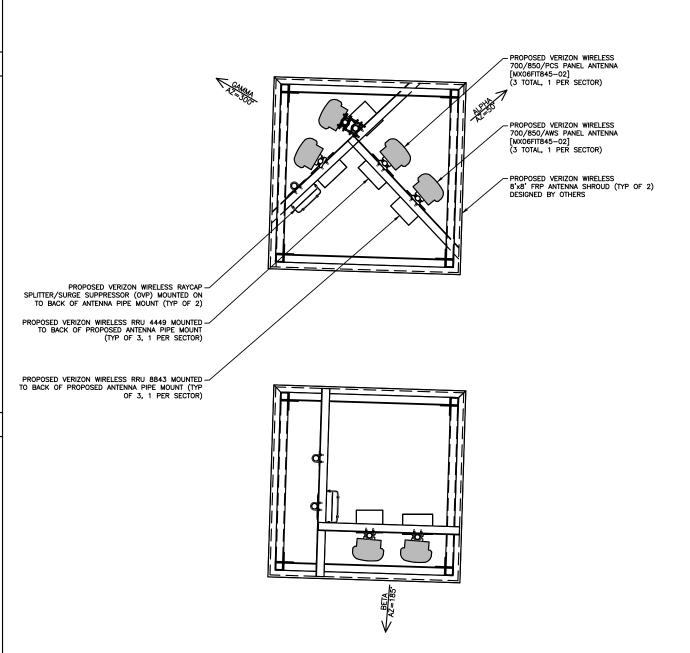

ZONING 08/03/18 ISSUED FOR PERMIT ISSUED FOR REVIEW 05/23/18

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Implementation Team:

A&E Team:



600 STEWART ST, SUITE 200 SEATTLE, WA 98101 Tel: 206.268.7370

Project Info:

OLY TIVOLI

1517 CAPITOL WAY S. OLYMPIA, WA 98501

PROPOSED ANTENNA CONFIGURATION

Project Number:	Start Date:
180096700	05/16/18
Drafter:	Designer:
RB	RB
Project Manager:	Professional of Record:
LJB	LC
200	

RF-1

24"x36" SCALE: NOT TO SCALE 11"x17" SCALE: NOT TO SCALE

TYPICAL ANTENNA ATTACHMENT 2 24"x36" SCALE: 1/2" = 1'-0" 11"x17" SCALE: 1/4" = 1'-0"

PROPOSED ANTENNA CONFIGURATION