

DESIGN REVIEW APPLICATION - CONCEPT

OFFICIA	AL USE ON	LY	
Case #:	18-0709	Master File #:	Date: 2/28/18 JL
Receive	d B <mark>. FLO</mark>	YD/S.LODHOLMelated Cases:	Project Planner: <u>C.MCCOY</u>
Project	Name: Sto	I Road Apartments	
Site Ado	lress: 431 \$	Stoll Road	
Applicar	nt Name: _	th Street Housing, LLC	
Phone N	lumber: 36	60-352-4553	
E-Mail A	ddress: gl	ennwellsarchitect@gmail.com	
Descript	tion of Proje	ect: New 50 unit apartment building, four floors with 68 parking sta	lls and 5 street stalls.
A Conce	pt Design R	eview Application shall be submitted electronically with two	hard copies and shall include:
1	Gonoral La	nd Use Application Refer to the General Land Use Applicatio	on for Submittal requirements
1.	General La	id use Application Refer to the defieral Land use Application	on tor Submittar requirements
		t of property owners within 300 feet of project site prepared	d by a title company. Submit the list
	OII a IIasii u	rive or memory stick in Excel worksheet format.	
3.		n including plan and elevation views in relation to surround	
		Footprint(s) of proposed and existing buildings, including the site on the same side of the street.	lose within 100° of the project
		Scaled elevations of proposed and existing buildings, includ	ing those within 100' of the
		project site on the same side of the street.	
4.	<u>Preliminary</u>	Site Plan illustrating:	
		Property lines with distances.	
		Adjacent public rights-of-way.	
		Existing and proposed grades at 2-foot contour intervals. Existing and proposed site features, including stormwater for	acilities and soil and vegetation
	Ш	protection areas.	acilities and son and vegetation
		Existing and proposed building footprint(s) with dimensione	ed setbacks from property lines.
		Clearly delineated and labeled landscape and hardscape are	eas.
5.	Preliminary	Landscape Plan meeting the provisions of OMC 18.36, illust	rating features such as, but not
	limited to:		
		Location of existing (to remain) and proposed plants.	
		Type of existing and proposed plants (i.e., groundcover, shr	· · · · · · · · · · · · · · · · · · ·
		Graphic depiction of the size of proposed tree canopies at r	· · · ·
		Clearly delineated and labeled landscape, hardscape, and b	uliding areas.

<u>Preliminar</u>	<u>r Building Elevations (</u> fully scale and dimer	nsion each elevation) illustrating:					
	Building elevations of all sides of the buil	lding(s) labeled as north, south, east or west					
	elevation.						
	☐ Location of building doors and windows.						
	Indicate finished floor elevations and loc	ation of exterior steps and stairways.					
	Area(s) on building where signs will be in	nstalled.					
This form	has been approved for use by the Olyr	mpia Community Planning and Development					
This form (CPD) Dep		mpia Community Planning and Development					
		mpia Community Planning and Development					
(CPD) Dep							

PHOTO 2



1 PHOTO



PHOTO 4



3 PHOTO



6 PHOTO



5 PHOTO






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9 PHOTO



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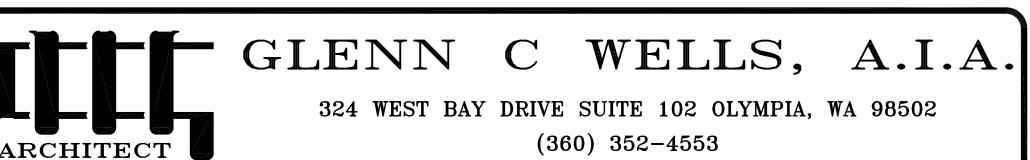
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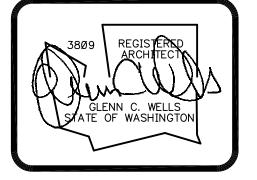


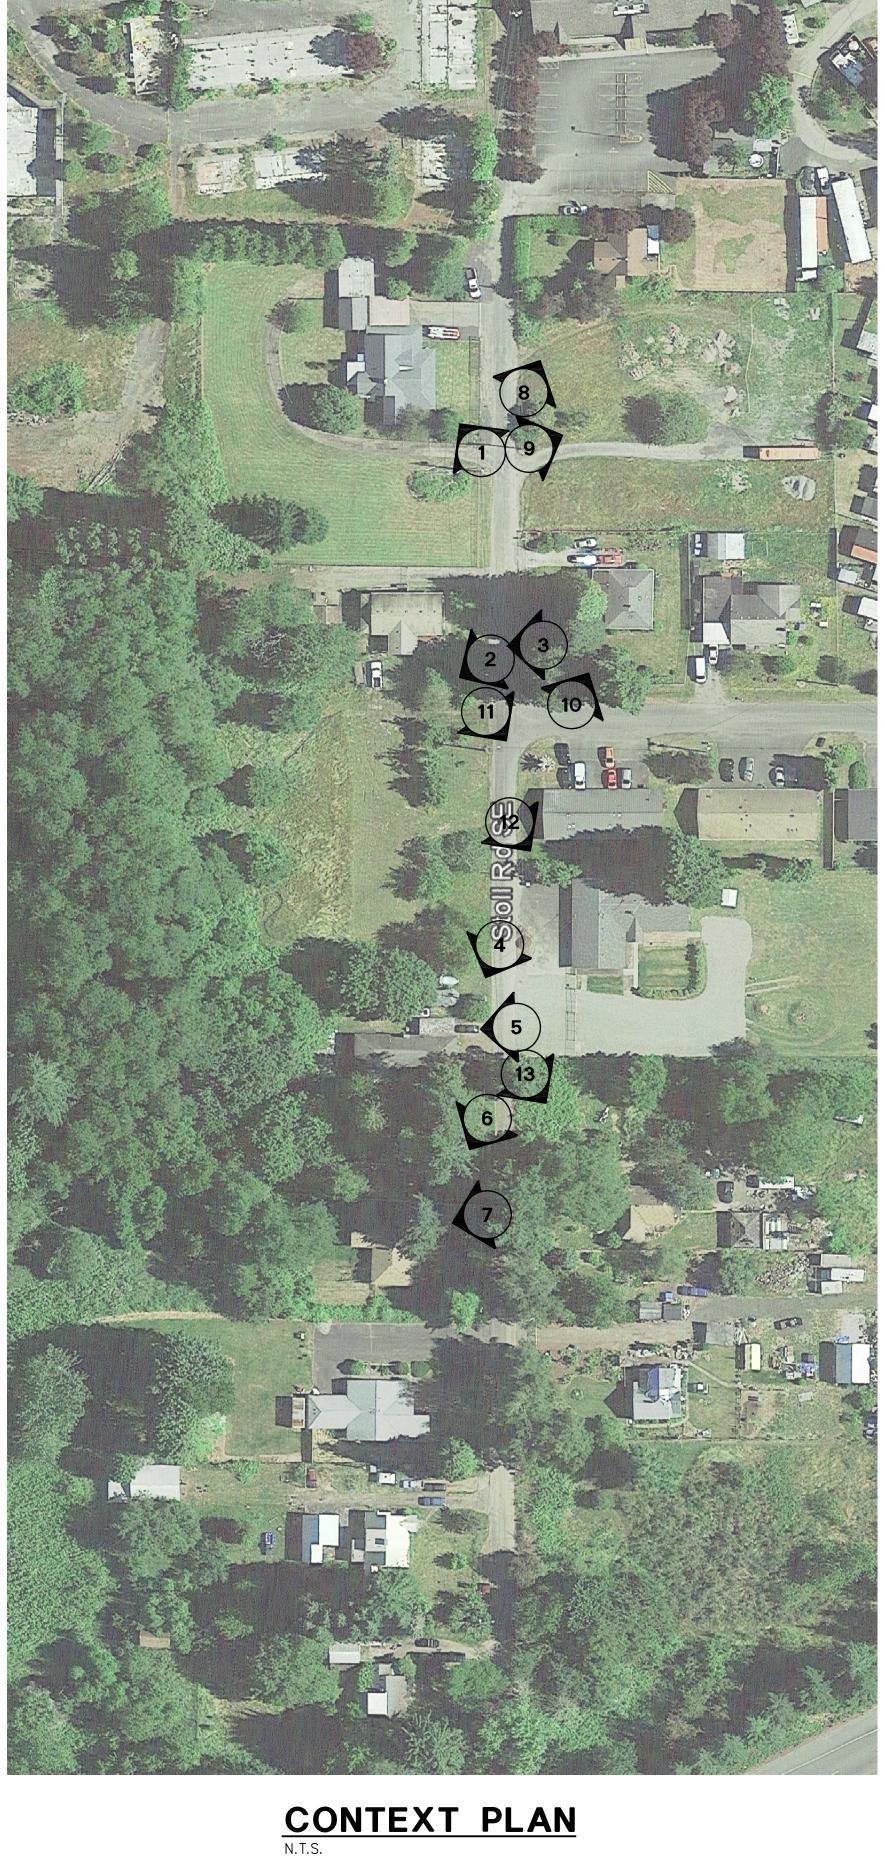(13) <u>PHOTO</u>



7 PHOTO





date: 02-28-17 drawn: R.C.T. checked: G.C.W.

city issue: . revisions:

title:

CONTEXT PHOTOS STOLL ROAD APARTMENTS
431 STOLL ROAD
OLYMPIA, WASHINGTON

sheet no. CONTEXT 1.0




CONTEXT ELEVATION
SCALE: 1/16"=1'-Ø"



GLENN C WELLS, A.I.A.

324 WEST BAY DRIVE SUITE 102 OLYMPIA, WA 98502 (360) 352-4553

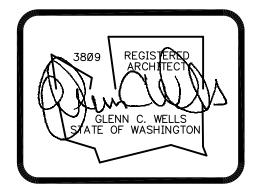

date: 02-28-17
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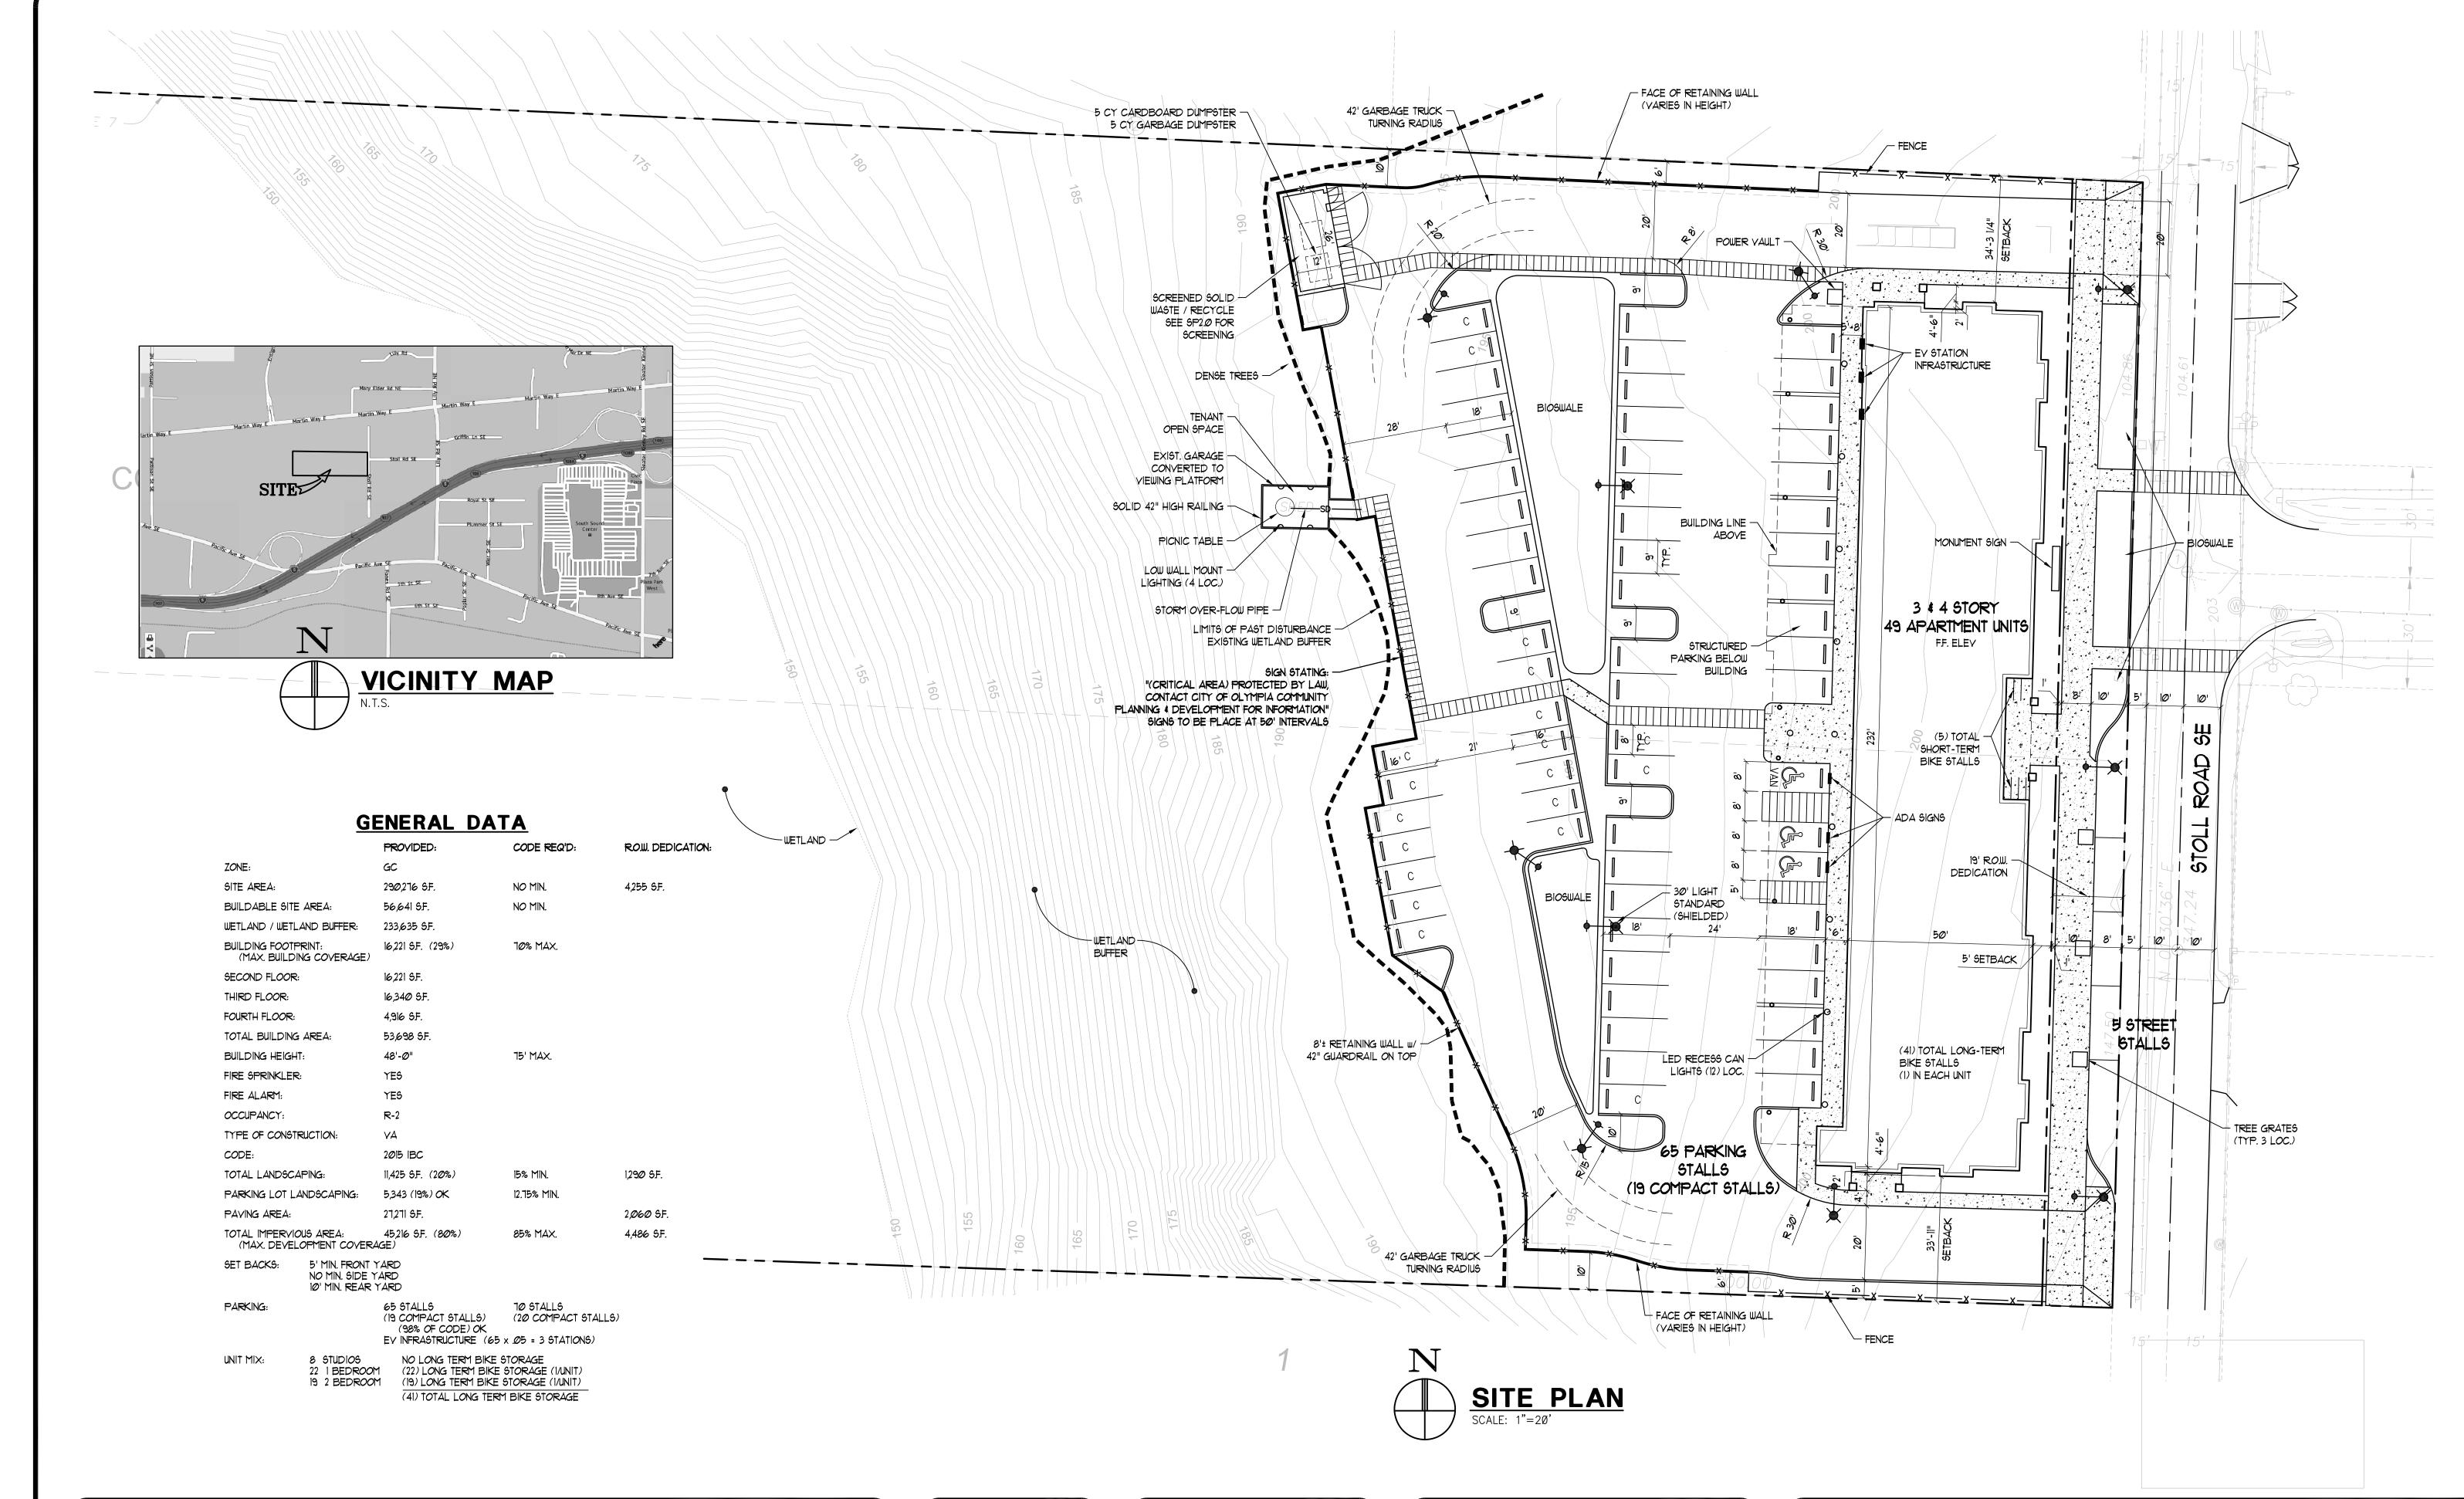
city issue: .	
revisions:	

CONTEXT ELEVATIONS
STOLL ROAD APARTMENT

STOLL ROAD APARTMENTS
431 STOLL ROAD
OLYMPIA, WASHINGTON

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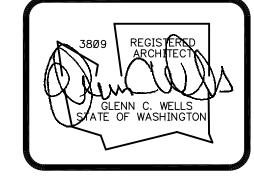
CONTEXT
2.0



ARCHITECT

GLENN C WELLS, A.I.A.

324 WEST BAY DRIVE SUITE 102 OLYMPIA, WA 98502 (360) 352-4553



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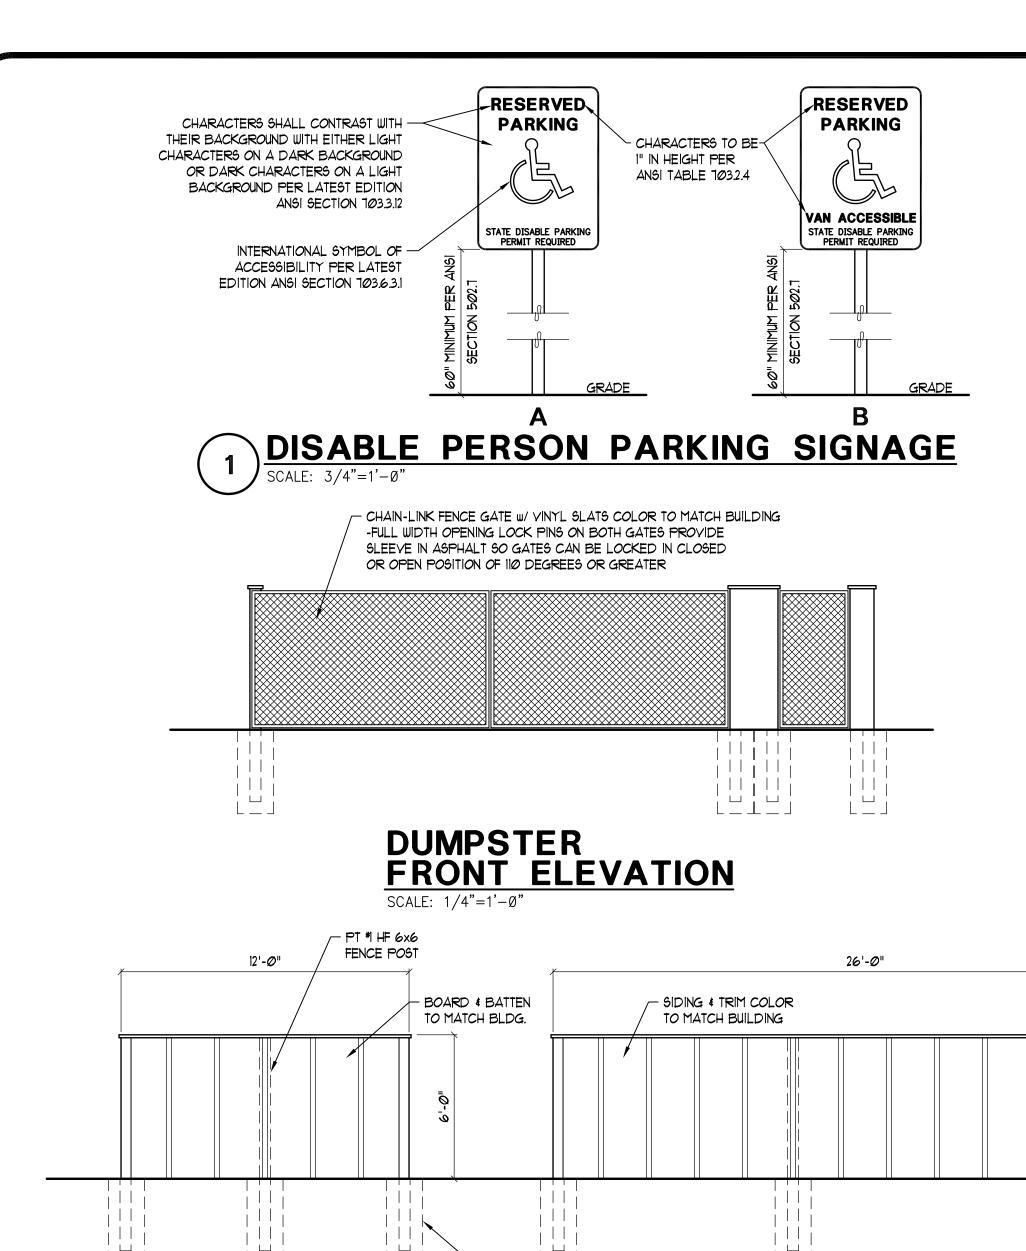
title:


SITE PLAN
STOLL ROAD APARTMENTS
501 STOLL ROAD
OLYMPIA, WASHINGTON

SP1.0

sheet no.

W:\Commercial\Clients\G\Glenn Wells\- Stoll Road\171083 - Stoll Road Apartments\171083- SP01.0.dwg, 9/5/2



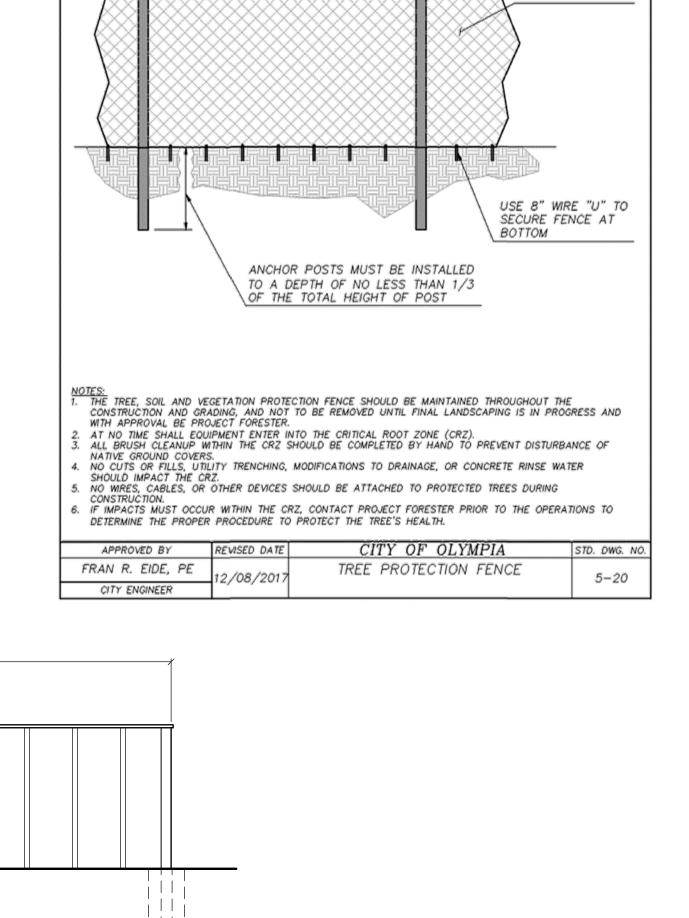


8' MAXIMUM


ANCHOR POSTS SHOULD BE


LINK FENCE

MINIMUM 6' TALL "T-BAR"

FENCE POSTS

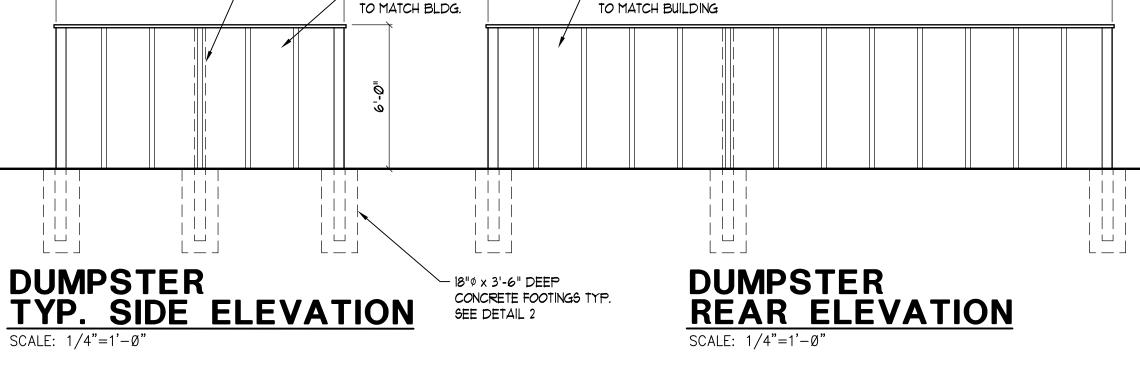

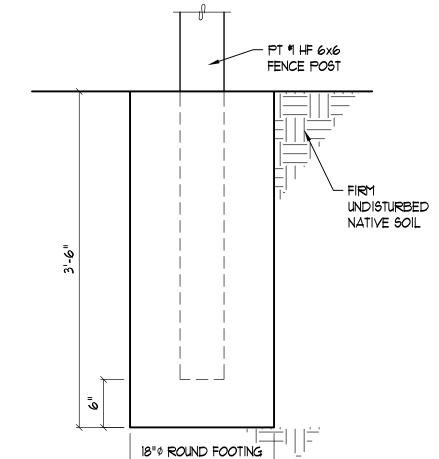

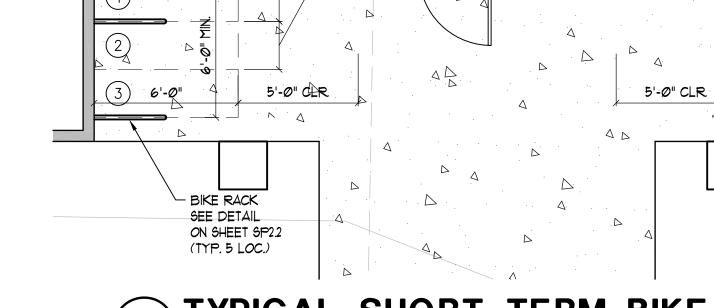


- (3) 2'x 6'

SHORT-TERM

BIKE STALLS

CONCRÉTE POLE FOOTING FOR TIMBER FENCE POST



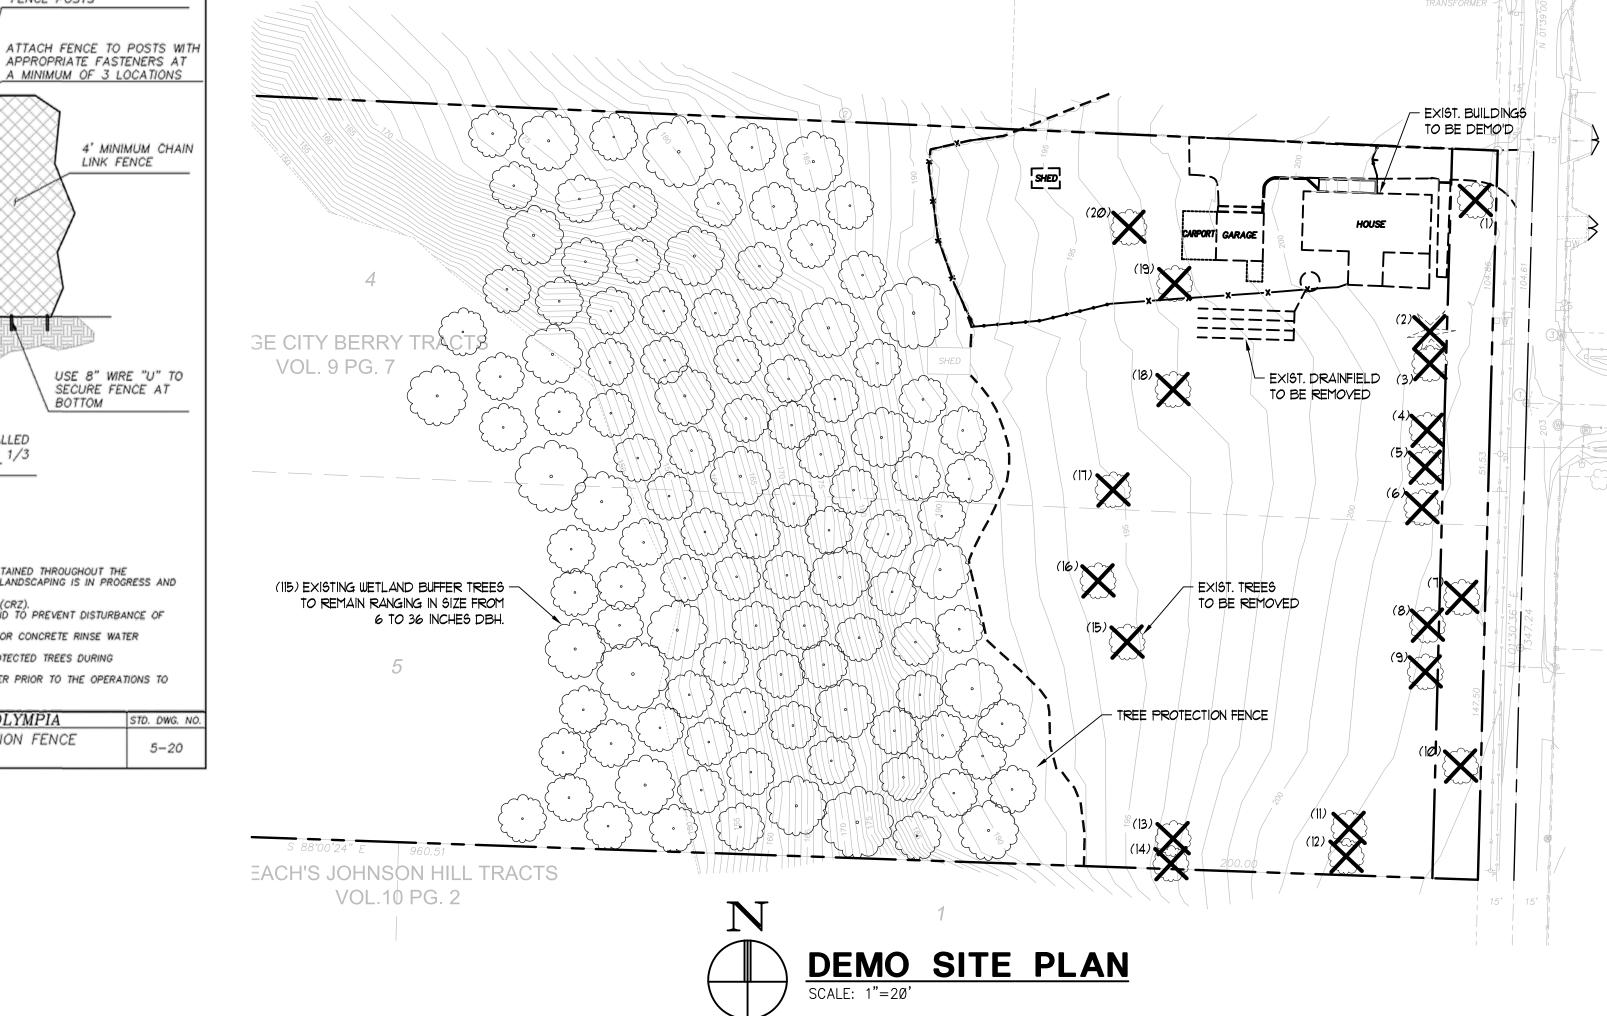

Chapter 7 Tree Protection Measures

7.1 Placing Materials near Trees

No person may conduct any activity within the protected area of any tree designated to remain including but not limited to parking equipment, placing solvents, storing building material and soil deposits, dumping concrete washout and locating burn holes


7.2 Attachments to Trees

During construction no person shall attach any object to any tree designated for protection

7.3 Protective Barrier

Before development, land clearing, filling or any land alteration for which a Tree Removal Permit is required, the applicant:

 Shall erect and maintain readily visible protective tree fencing along the outer edge and completely surrounding the protected area of all protected trees or groups of trees. Fences shall be constructed of chain link and at least four feet high, unless other type of fencing is authorized by the Urban Forester

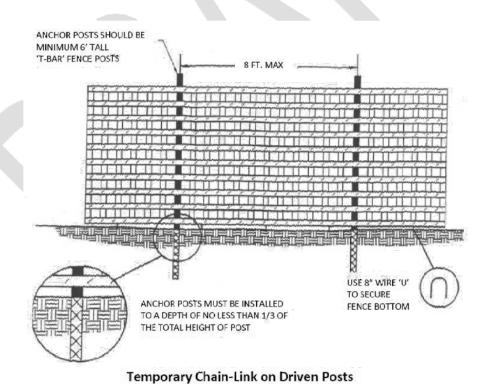

- May be required to cover with mulch to a depth of at least six (6) inches or with plywood or similar material the areas adjoining the critical root zone of a tree in order to protect roots from damage caused by heavy equipment
- Shall prohibit excavation or compaction of earth or other potentially damaging activities within
- May be required to minimize root damage by excavating a two (2) foot deep trench to cleanly sever the roots of trees to be retained Shall maintain the protective barriers in place until the Urban Forester authorizes their removal
- or a final Certificate of Occupancy is issued, whichever occurs first
- Shall ensure that any landscaping done in the protected zone subsequent to the removal of the barriers shall be accomplished with light machinery or hand labor

7.4 Grade


- 1. The grade shall not be elevated or reduced within the critical root zone of trees to be preserved without the Urban Forester's authorization. The Urban Forester may allow coverage of up to onehalf of the area of the Tree's critical root zone with light soils (no clay) to the minimum depth necessary to carry out grading or landscaping plans, if it will not imperil the survival of the tree. Aeration devices may be required to ensure the tree's survival
- 2. If the grade adjacent to a preserved tree is raised such that it could slough or erode the tree's critical root zone, it shall be permanently stabilized to prevent suffocation of the roots
- 3. The applicant shall not install an impervious surface within the critical root zone of any tree to be retained without the authorization of the Urban Forester. The Urban Forester may require specific construction methods and/or use of aeration devices to ensure the tree's survival and to minimize the potential for root induced damage to the impervious surface
- 4. To the greatest extent practical, utility trenches shall be located outside of the critical root zone of trees to be retained. The Urban Forester may require that utilities be tunneled under the roots of trees to be retained if the Urban forester determines that trenching would significantly reduce the chances of the trees survival
- 5. Trees and other vegetation to be retained shall be protected from erosion and sedimentation

7.5 Directional Felling

Directional felling of trees shall be used to avoid damage to trees designated for retention


7.6 Additional Requirements

The Urban Forester may require additional tree protection measures which are consistent with accepted urban forestry practices

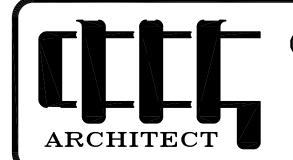

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date: 02	2-28-17
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checked:	G.C.W.

(2) 2'x 6' ¬

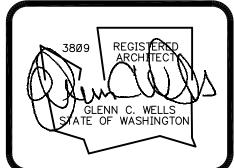SHORT-TERM

BIKE STALLS

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title: DEMO SITE PLAN AND DETAILS STOLL ROAD APARTMENTS

501 STOLL ROAD OLYMPIA, WASHINGTON SP2.0

sheet no.




FIRST FLOOR PLAN SCALE: 1/8"=1'-0"

ARCHITECT

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revisions:

FIRST FLOOR PLAN
STOLL ROAD APARTMENTS
501 STOLL ROAD
OLYMPIA, WASHINGTON

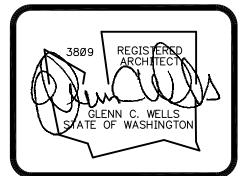
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sheet no.



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SECOND FLOOR PLAN
STOLL ROAD APARTMENTS

LL ROAD APARTMENTS
501 STOLL ROAD
OLYMPIA, WASHINGTON

sheet no

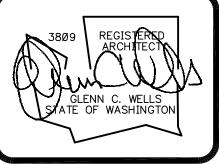A2.0




THIRD FLOOR PLAN SCALE: 1/8"=1'-Ø"



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THIRD FLOOR PLAN
STOLL ROAD APARTMENTS

title:

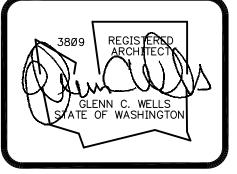L ROAD APARTMENTS
501 STOLL ROAD
OLYMPIA, WASHINGTON

A3.0

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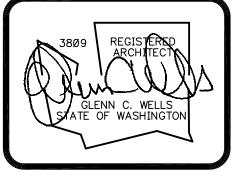


FOURTH FLOOR PLAN SCALE: 1/8"=1'-0"



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FOURTH FLOOR PLAN
STOLL ROAD APARTMENTS
501 STOLL ROAD
OLYMPIA, WASHINGTON

sheet no.

A4.0



501 STOLL ROAD OLYMPIA, WASHINGTON

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(360) 352-4553

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	BOTANICAL NAME	COMMON NAME	QUANTITY	INSTALLED SIZE	MATURE	MATURE		TYPE (
MBOL					HEIGHT	DIA.		PLAN
(*)	BETULA JACQUEMONTII CLUMPING	CLUMPING BIRCH	5	2 1/2" CALIPER	25'	8'	DT NN	D
®	BETULA NIGRA	RIVER BIRCH	8	2 1/2" CALIPER	_	_	DT NN	D
\Diamond	PYRUS CALLERYANA 'CAPITAL'	CAPITAL PEAR	6	2 1/2" CALIPER	25'	25'	DT NN	D
⊗	ACER PALMATUM	-	8	2 1/2" CALIPER	_	_	_	_
\$	SANGO KAKU MAPLE	CORAL BARK MAPLE	6	2 1/2" CALIPER	15'	15'	DT NN	D
$\overline{()}$	ACER PALMATUM DISSECTUM 'RED DRAGON'	RED DRAGON JAPANESE MAPLE	2	2 1/2" CALIPER	20'	6'	DT NN	D
**	PICEA OMORIKA 'BURNS'	BRUNS SERBIAN SPRUCE	9	2 1/2" CALIPER	30'	10'	DT NN	EG
**	PSEUDOTSUGA MENZIESII	DOUGLAS FIR	11	6' TALL	100'	25'	DT N	EC
0	ABIES GRANDIS	GRAND FIR	9	6' TALL	100'	25'	DT N	EG
Ō	PRUNUS EMARGINATA	BITTER CHERRY	8	6' TALL	25'	13'	DT N	D
8	CORNUS SERICEA & CORNUS STOLONIFERA	RED & YELLOW TWIG DOGWOOD	51	1 GALLON	6'	6'	_	_
	SARCOCOCCA HIMALAYAN	SWEET BOX	375	1 GALLON	2'	2'	DT NN	EC
\bigcirc	NANDINA DOMESTICA 'FIRE POWER'	HEAVENLY BAMBOO	35	2 GALLON	2'	2'	DT NN	EG
()	NANDINA DOMESTICA	HEAVENLY BAMBOO	6	5 GALLON	6'	4'	DT NN	EG
	CAREX OSHINENSIS 'EVERGOLD'	VARIEGATED JAPANESE SEDGE	31	1 GALLON	1'	2'	DT NN	D
· · · · · · · · · · · · · · · · · · ·	ARCTOSTAPHOLYS UVA-URSI "MASSACHUSETTS"	KINNINNICK (SPACE 18" O.C.)	_	1 GALLON	_	_	_	_
	JUNCUS ENSOFOLIUS	DAGGER-LEAVED RUSH (SPACE 18" O.C.)	_	1 GALLON	_	_	_	_

DROUGHT TOLERANT NON NATIVE

DROUGHT TOLERANT NATIVE

DECIDUOUS EVERGREEN

Minimum Density Calculations

The City of Olympia's Tree Protection and Replacement Ordinance requires that 30 units per acre of existing trees be retained in the buildable area of the site. The buildable area excludes public rights-of-ways. If suitable trees are not retained in tree protection areas, then trees must be planted to achieve the minimum density requirement.

The following is a summary of the estimated tree density planned for retention:

Total acreage Wetland area and buffer

Buildable area

5.14 acres 1.39 acres

Minimum Density Required:

(30 units/acre x 1.39 acres)

Planned Tree Retention:

Buffer (50% of required tree units) 20.8 Tree Units Total Tree Units-To be Saved

20.8 Tree Units


6.53 acres

41.7 Tree Units

20.9 Tree Units Shortfall of Tree Units

Planned tree retention is short of the minimum density requirement by 20.9 tree units. Twentyone trees will need to be planted to meet the minimum density requirement. Trees need to be 2 in. caliper if broadleaved, or 6 ft. tall if coniferous at the time of planting. For areas with wet soils, we recommend planting green ash (Fraxinus pennsylvanica 'Patmore or Summit'), black tupelo (Nyssa sylvatica), and/or bald cypress (Taxodium distichum).

23 TREES ADDED +20.8 = 44 TREE UNITS > 41.7 OK

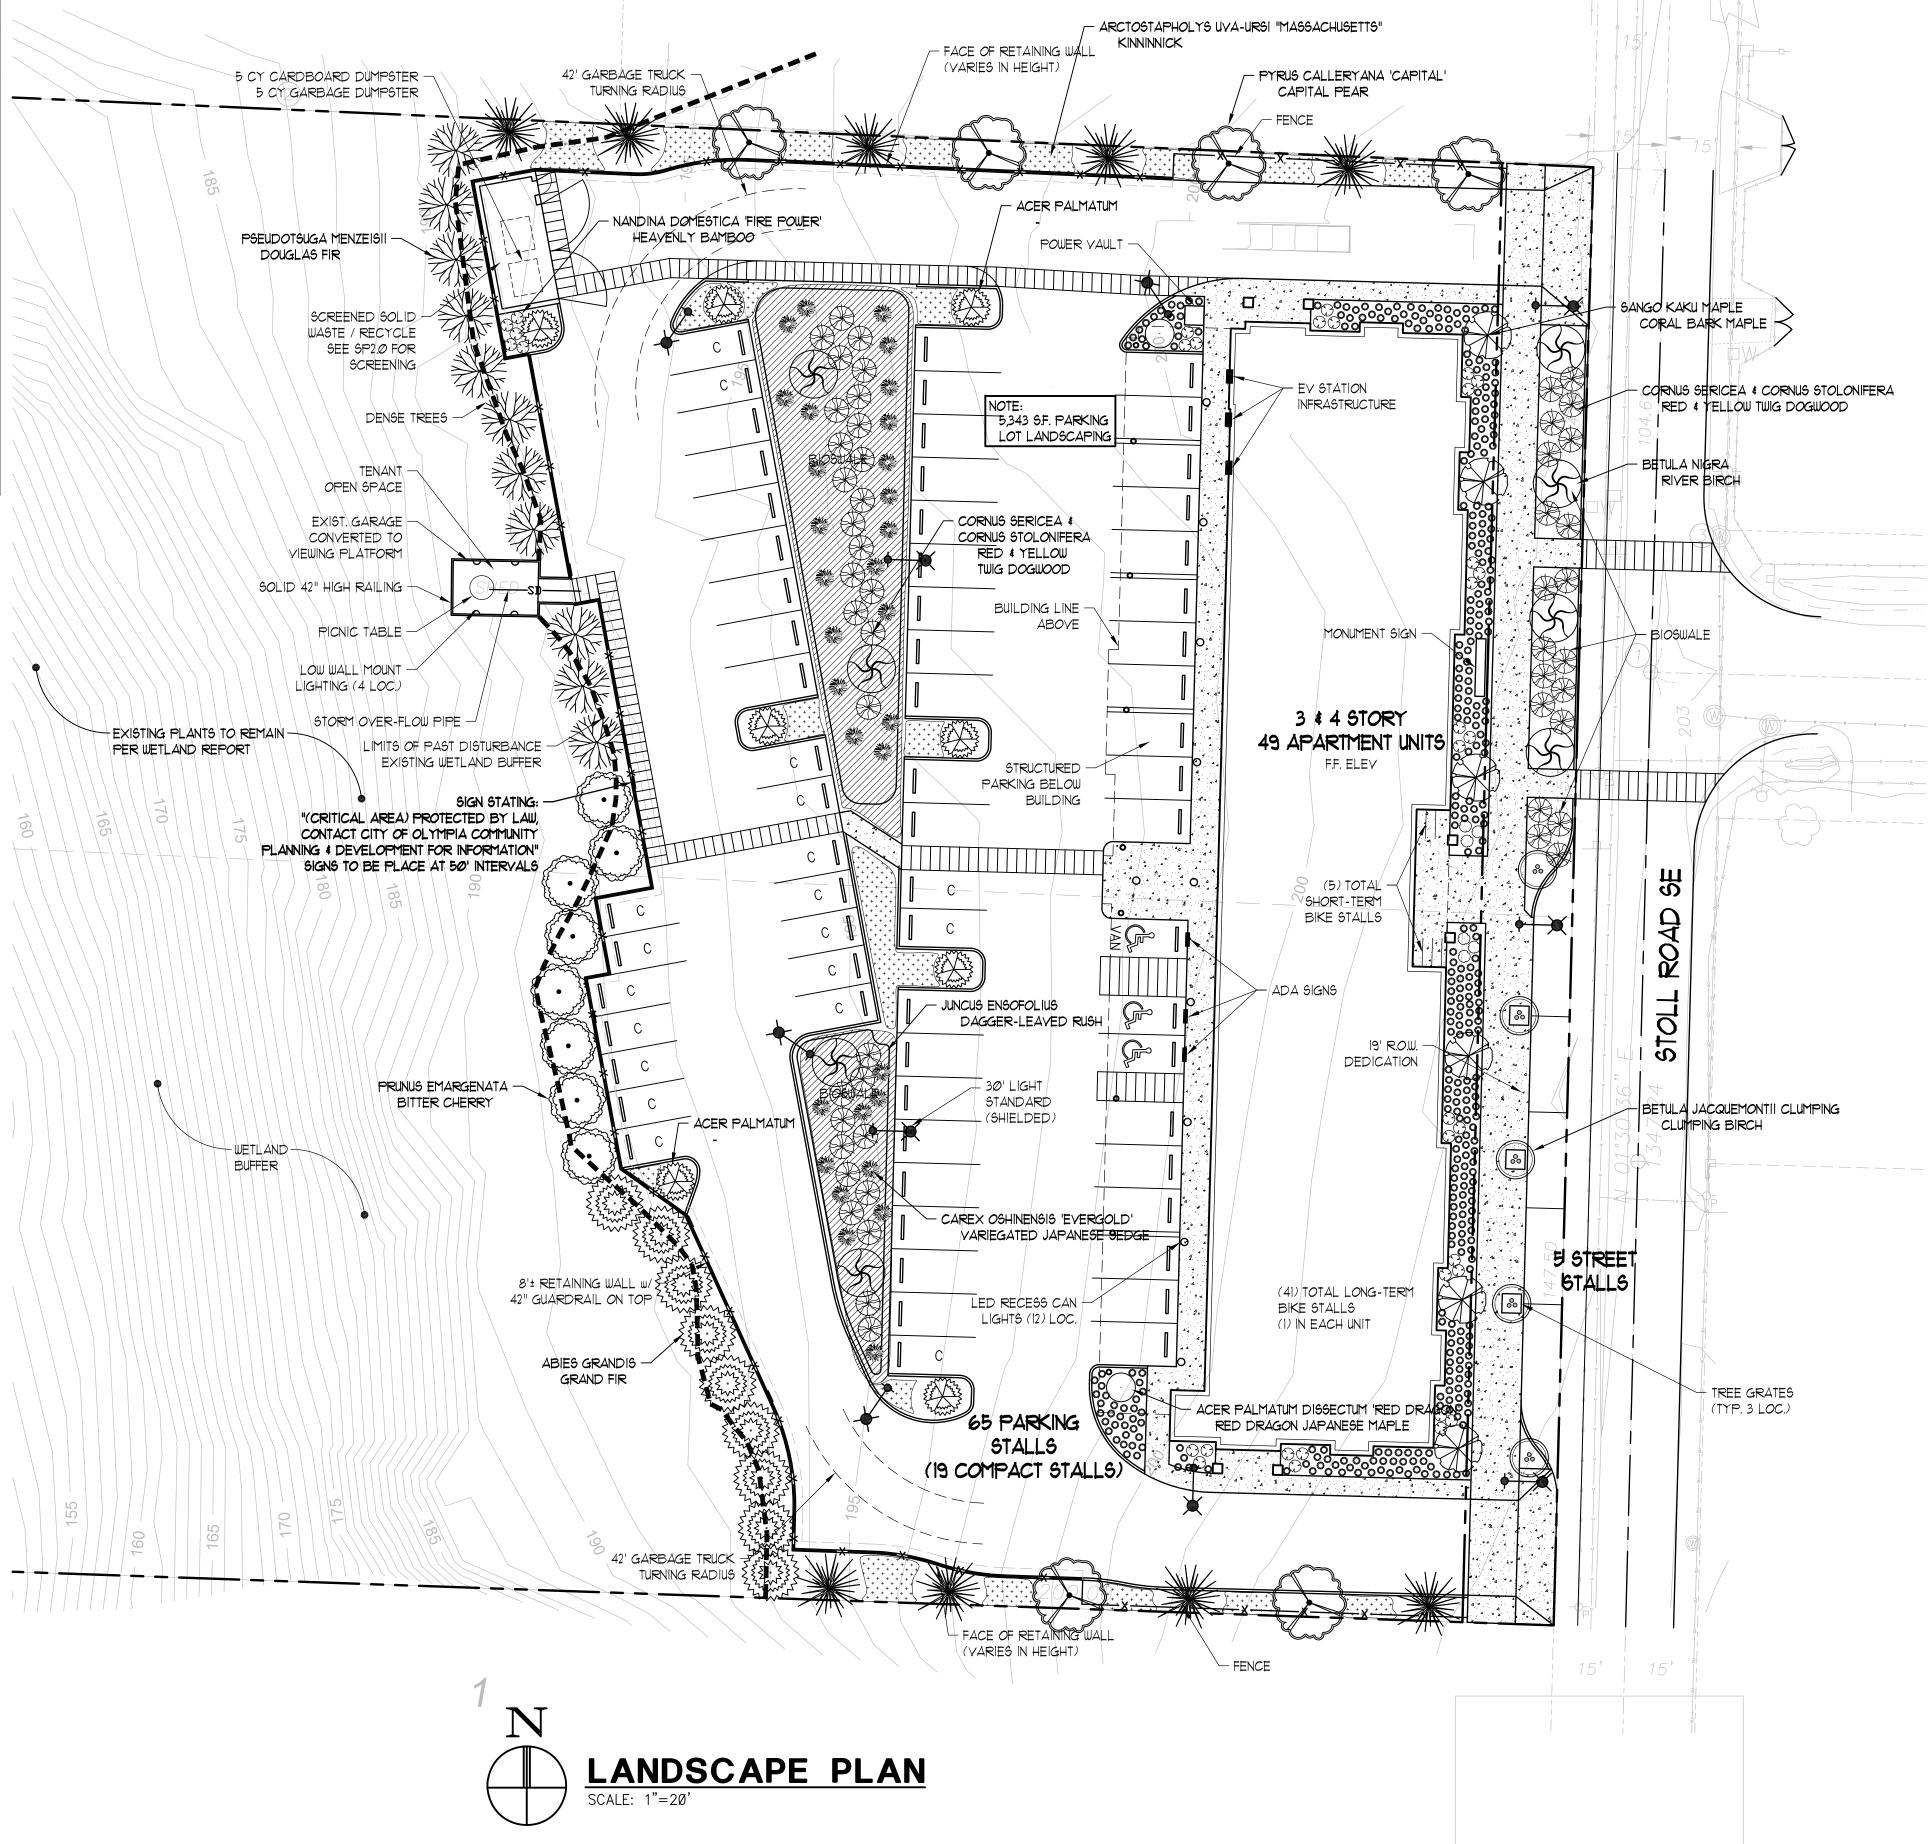






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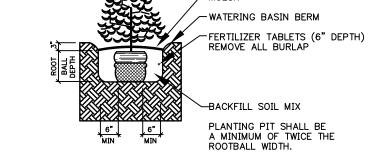
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title: LANDSCAPE PLAN STOLL ROAD APARTMENTS 501 STOLL ROAD OLYMPIA, WASHINGTON

sheet no.


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GROUND COVER PLANT SPACING DETAIL **PLANTING DETAIL**


SHRUB PLANTING DETAIL

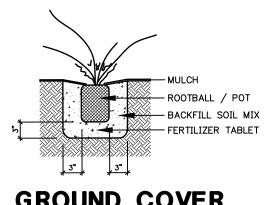

TREE PLANTING **& STAKING DETAIL**

to infrastructure.

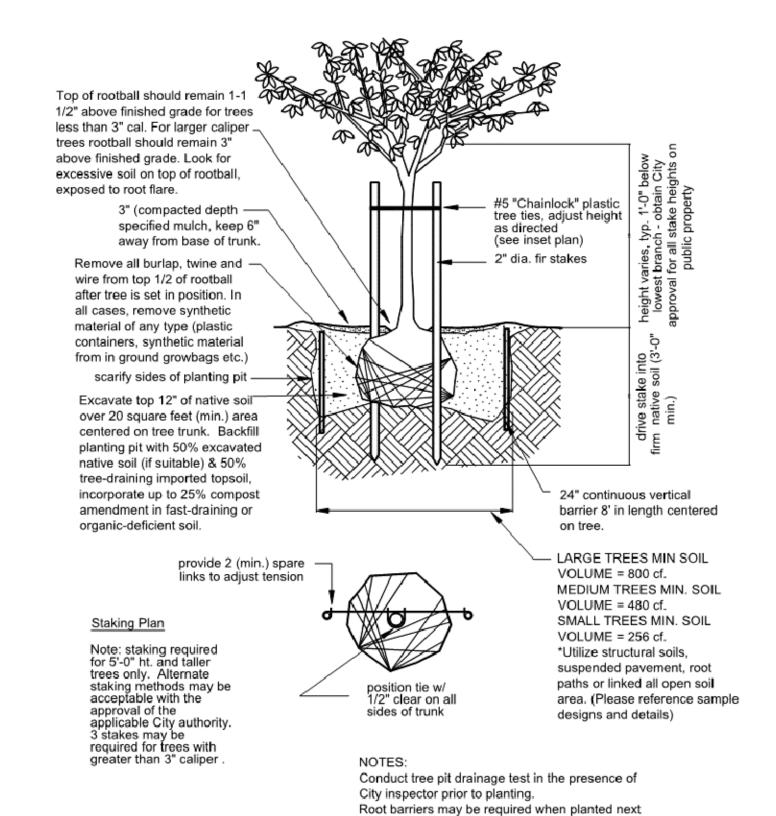SIZE: TREES SHALL BE A MINIMUM OF 2" CALIPER. GRADE: UNLESS OTHERWISE SPECIFIED BY THE URBAN FORESTER, ALL TREES SHALL HAVE COMPARATIVELY STRAIGHT TRUNKS, WELL-DEVELOPED LEADERS AND CROWNS, SHALL EXHIBIT EVIDENCE OF PROPER NURSERY PRUNING PRACTICES, AND SHALL HAVE A BRANCH HEIGHT OF AT LEAST 6 FEET. AT THE TIME OF PLANTING, ALL TREES MUST BE FREE OF MECHANICAL INJURIES AND OTHER OBJECTIONABLE FEATURES THAT AFFECT THE FUTURE FORM AND BEAUTY OF THE PLANT.

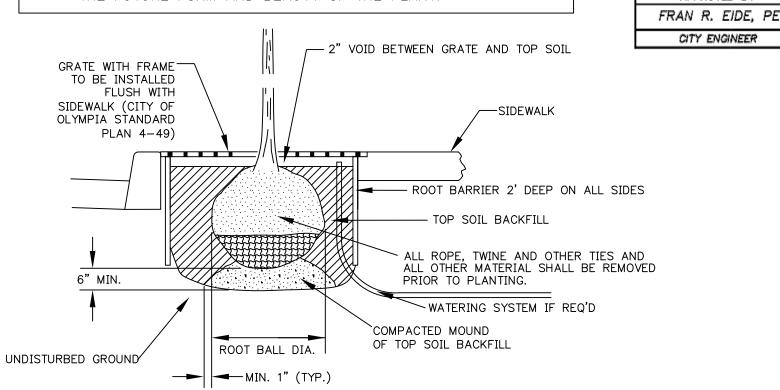

TREE & WELL GRATE

LANDSCAPE SPECIFICATIONS

- 1. WEED REMOVAL CONTRACTOR SHALL MECHANICALLY PULL ANY NOXIOUS WEED SPECIES AND DISPOSE OF IN AN OFF-SITE DUMP, TAKING CARE TO REMOVE AS MUCH AS THE ROOT SYSTEM AS POSSIBLE OF THE WEEDS. CHEMICAL WEED CONTROL IS NOT PERMITTED DUE TO THE CLOSE PROXIMITY OF THE WATERWAY.
- 2. SOIL MIX FOR SOIL PREPARATION SHALL BE A 3-WAY MIX
- CONSISTING OF COMPOST, CLEAN SAND AND LOAMY TOPSOIL.
- 3. ALL LANDSCAPED AREAS SHALL BE EXCAVATED TO A DEPTH OF 12 INCHES BELOW FINISH GRADE IN SHRUB AREAS AND 6 INCHES BELOW IN LAWN AREAS AND REPLACE WITH SPECIFIED TOPSOIL.
- 4. FINE GRADE ALL LANDSCAPE BEDS PRIOR TO PLANTING OPERATIONS.
- 5. ALL PLANT SUBSTITUTIONS REQUIRE APPROVAL BY APPLICANTS FORESTER.
- 6. ALL PLANTS SHALL CONFORM TO THE LATEST EDITION OF THE AMERICAN STANDARD FOR NURSERY STOCK GRADE 1 OR BETTER.
- 7. ALL PLANT MATERIAL AND LOCATION SHALL BE APPROVED BY PROJECT FORESTER PRIOR TO INSTALLATION. ALL PLANT MATERIAL SHALL BE THOROUGHLY WATERED AFTER PLANTING.
- 8. PLANTING AREAS SHALL BE TOP-DRESSED WITH MUCLH TO A DEPTH OF 4".
- 9. ALL WORK SHALL BE PERFORMED TO THE SATISFACTION OF THE PROJECT FORESTER
- AND CITY OF OLYMPIA LANDSCAPE INSPECTOR.
- 10. ALL PLANTS SHALL BE GUARANTEED FOR ONE FULL YEAR FROM DATE OF PROJECT ACCEPTANCE BY INSTALLER AND ALL REPLACED PLANTS SHALL BE RE-GUARANTEED.
- 11. SEE BONDING STATEMENT.

I INCH TACK

STD. DWG. NO.

4-49

WELD, BOTH

SIDES (TYP)

– 47 7/8" —

4. GRATE IS 1 INCH THICK WITH 1 1/4 INCH THICK SUPPORT RIBS.

9. GRATE WITH FRAME TO BE INSTALLED FLUSH WITH SIDEWALK.

7. ALTERNATE SIZES AND PATTERNS ARE ACCEPTABLE IF ABOVE CRITERIA IS MET AND

<u>CITY OF OLYMPIA</u>

STREET TREE FRAME AND

GRATE DETAILS

8. GRATES SHALL BE INSTALLED WITH BRACKETS AND/OR FRAMES PER THE

11. TREE GRATE SHALL BE PLACED ADJACENT TO CURB, WITHIN THE SIDEWALK.

STANDARD 16 INCH OPENING.

3. NO OPENING GREATER THAN 3/8 INCH.

MANUFACTURE'S RECOMMENDATION.

10. ALL GRATES SHALL MEET ADA STANDARDS.

REVISED DATE

5. KNOCKOUTS AT 22 INCHES AND 33 INCHES.

6. 1 INCH "TACK" OR "SPOT" WELD, BOTH SIDES.

APPROVED BY THE CITY URBAN FORESTER.

2. CAST IN TWO PIECES.

APPROVED BY

CITY ENGINEER

- 12. GROUNDCOVER SHALL BE PLANTED AND SPACED IN A TRIANGULAR PATTERN WHICH RESULTS IN EIGHTY (80%) COVERAGE IN THREE YEARS.
- 13. CONTRACTOR SHALL PROVIDE A WATERING SCHEDULE FOR ALL TREES AND SHRUBS OR ALTERNATIVE WATERING DEVISES TO INSURE ADEQUATE WATER THROUGH THE MONTHS OF MAY - OCTOBER
- 14. PROVIDE A THREE-YEAR MAINTENANCE SCHEDULE FOR ALL TREES AND SHRUBS

TIMELINE FOR SITE PREPARATION AND INSTALLATION OF PLANT MATERIALS — SPRING 2020 INVASIVE PLANT REMOVAL - SUMMER 2019

VEGETATION MAINTENANCE BOND (3 YEARS)

OMC 18.36.200, 18.36.220, & 16.60.100; EDDS 2.030; DDECM VOLUME I - 2.6.1 THIS BOND IS TO GUARANTEE ALL PLANT MAINTENANCE (INCLUDING STREET TREES), VEGETATION MAINTENANCE, IRRIGATION, AND HARDSCAPE ASSOCIATED WITH THE PROJECT ARE MAINTAINED IN AN ACCEPTABLE CONDITION FOR A PERIOD OF THREE YEARS. THIS BOND IS REQUIRED TO BE SUBMITTED AND ACCEPTED BY THE CITY PRIOR TO THE ISSUING OF ANY CERTIFICATE OF OCCUPANCY AND ENGINEERING PERMIT CLOSE OUT. THE CITY WILL PERFORM YEARLY INSPECTIONS OF THE PROJECT TO ASSURE THE MAINTENANCE IS IN AN ACCEPTABLE CONDITION THE AMOUNT OF THIS BOND IS 125% OF THE COST OF PURCHASE, SITE PREPARATION, INSTALLATION AND MAINTENANCE OF ALL OF THE LANDSCAPING, AND IRRIGATION. THIS IS DETERMINED BY THE COSTS SUBMITTED PER THE LANDSCAPE PLAN REQUIREMENTS AND APPROVED BY THE CITY. IF ALL ELEMENTS OF THE MAINTENANCE ARE IN AN ACCEPTABLE CONDITION AT THE END OF THE THREE-YEAR PERIOD, THE BOND WILL BE RELEASED.

LANDSCAPING COST ESTIMATE-PURCHASE OF PLANT MATERIAL- \$ 20,000 PURCHASE OF IRRIGATION PARTS \$ 5,000 SITE PREPARATION \$ 5,000 LABOR \$ 10,000 3 YEARS MAINTENANCE \$ 5,000 PER YEAR = \$ 15,000 TOTAL \$ 55,000

SOIL TYPE

THE SOIL COMPOSITION IS DARK BROWN FINE TO COARSE SAND WITH SILT, ABUNDANT ROOTS, LOOSE MOIST IN THE FIRST 3 FEET AND BROWN FINE TO COARSE SAND, MEDIUM DENSE, MOIST IN THE NEXT 5 FEET.

(BARK & GARDEN)

4004 HARRISON AVE NW OLYMPIA, WA 98502

(CENTER)



date: 02-28-17 drawn: R.C.T. checked: K.R.


city	issue:	09-05-18	LAND-USE	REVISION
revis	sions:			

title: LANDSCAPE DETAILS

sheet no.

STOLL ROAD APARTMENTS 501 STOLL ROAD OLYMPIA, WASHINGTON

L2.0

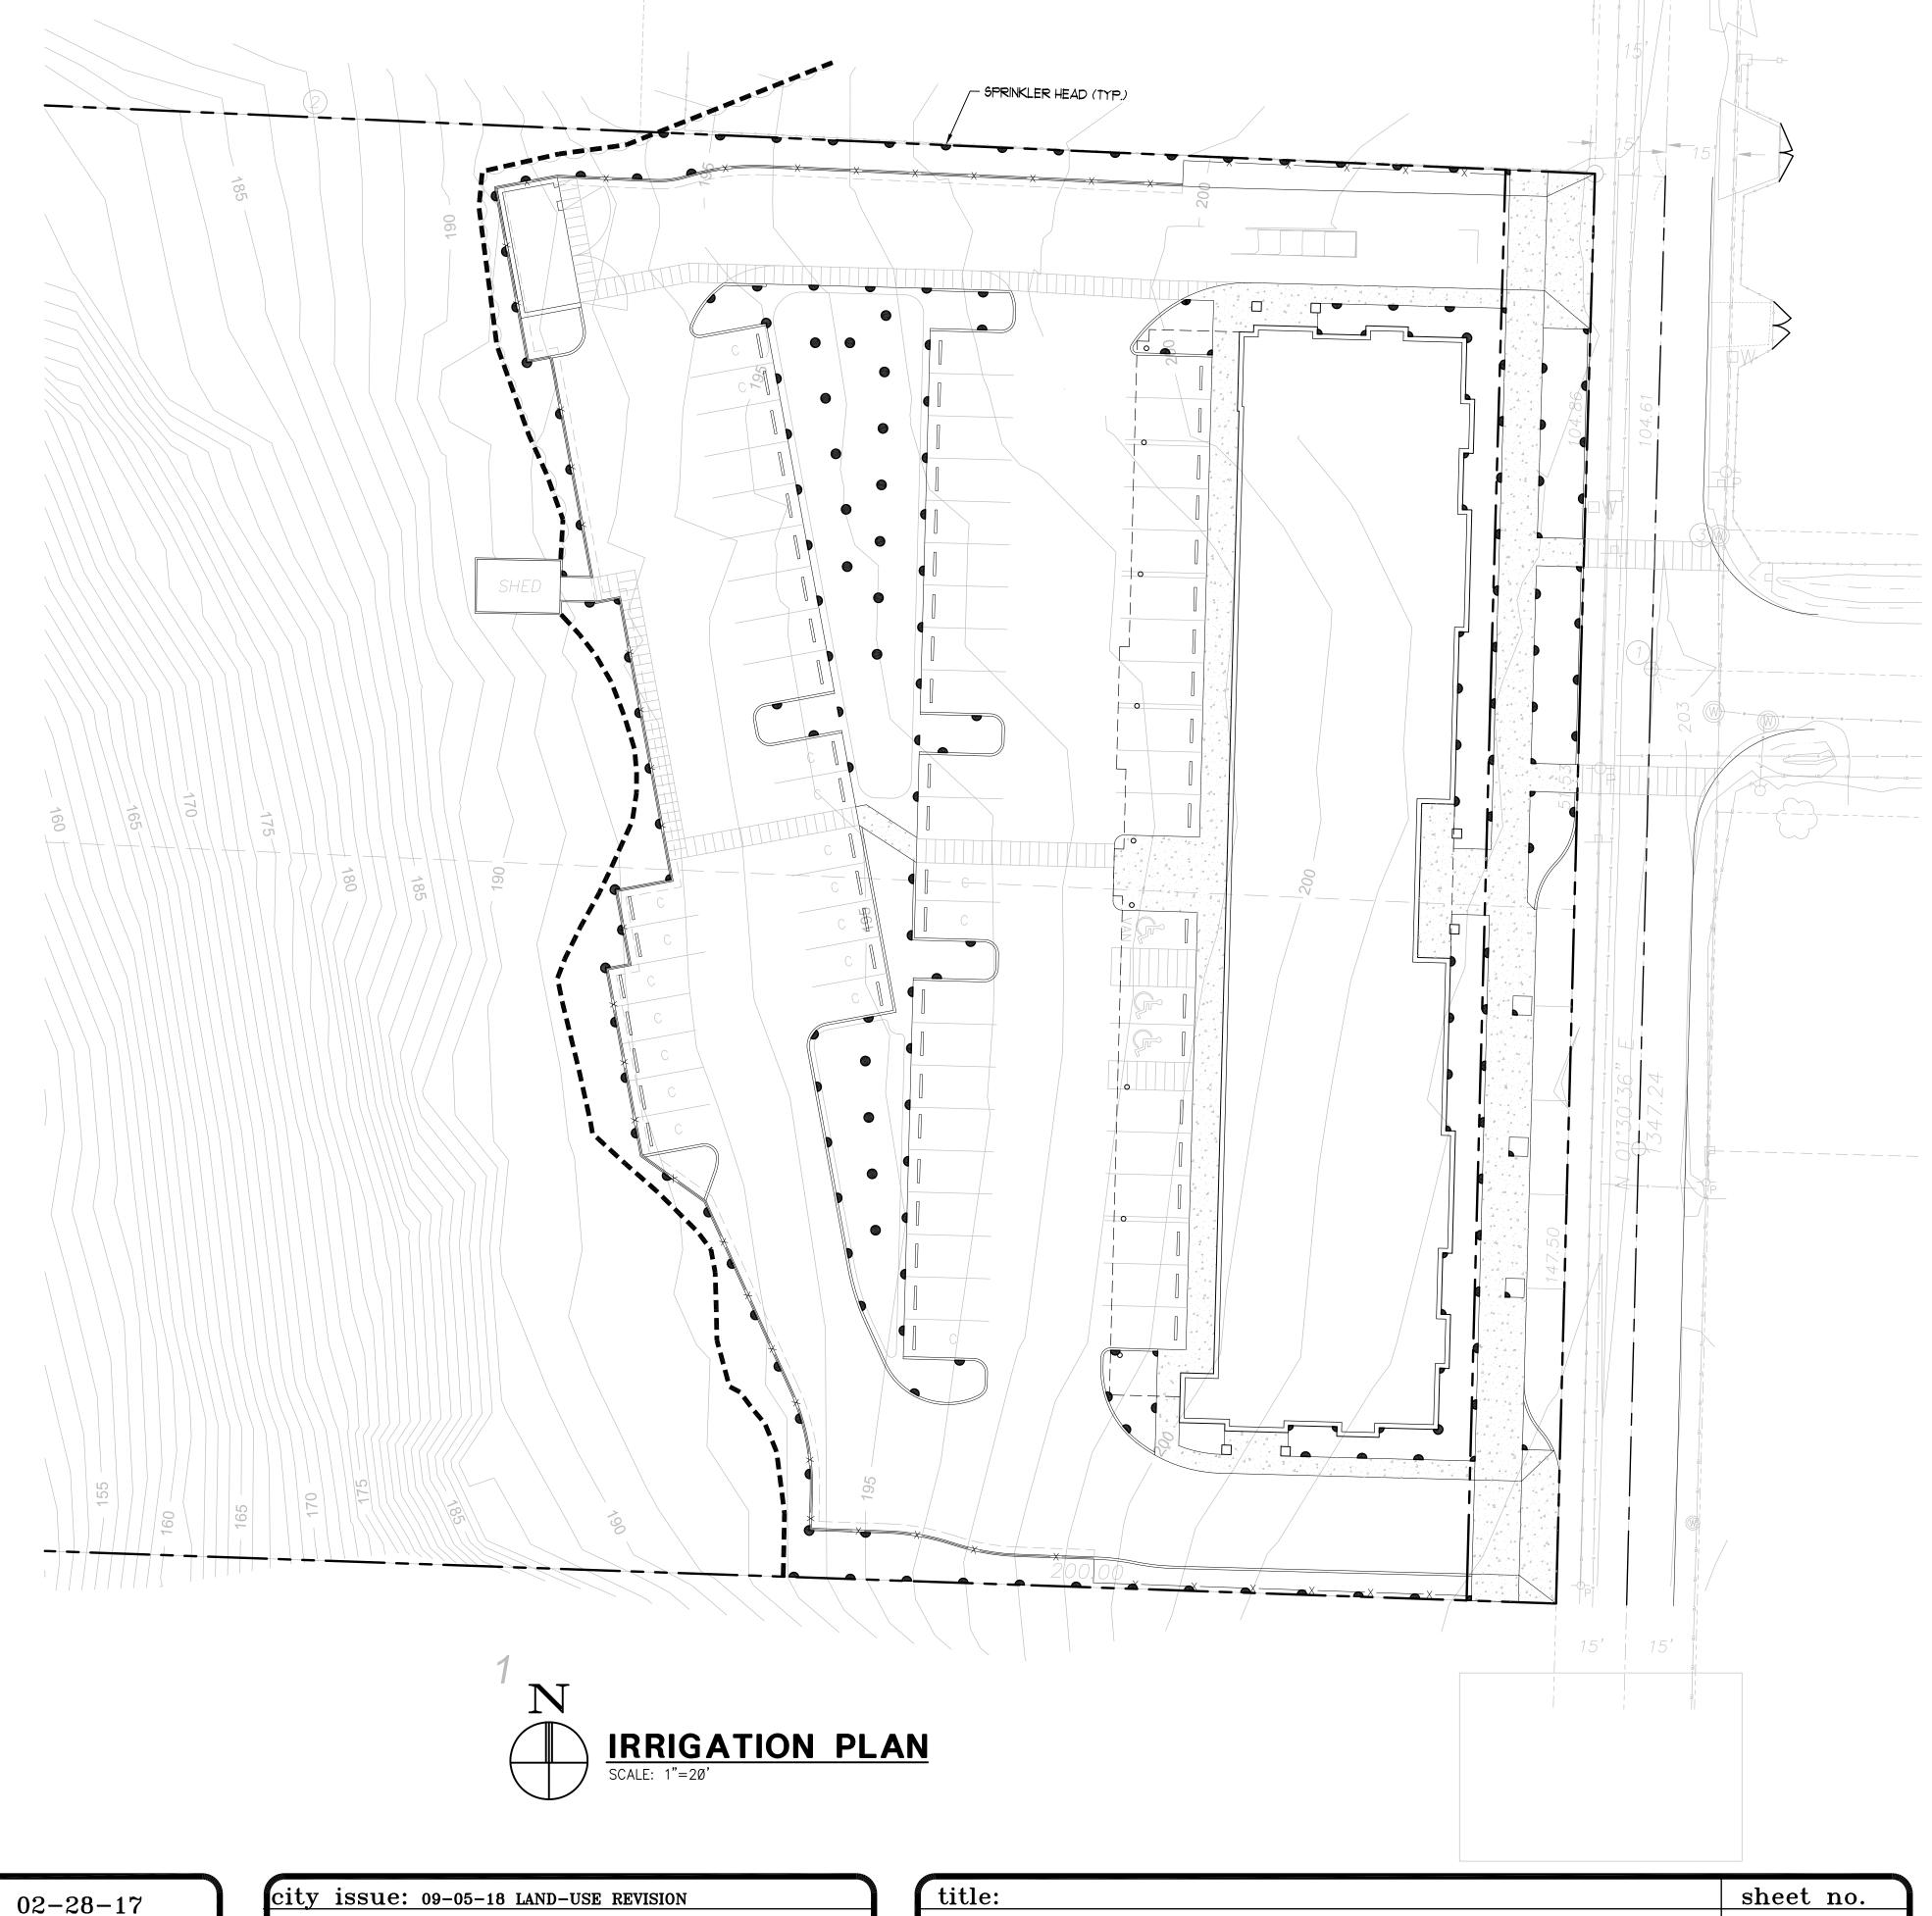

BARK & GARDEN
(CENTER)


4004 HARRISON AVE NW OLYMPIA, WA 98502

date:	02-28-17
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checke	d: K.R.


city	issue:	09-05-18	LAND-USE	REVISION	
revis	sions:				

IRRIGATION PLAN STOLL ROAD APARTMENTS
501 STOLL ROAD
OLYMPIA, WASHINGTON

L3.0

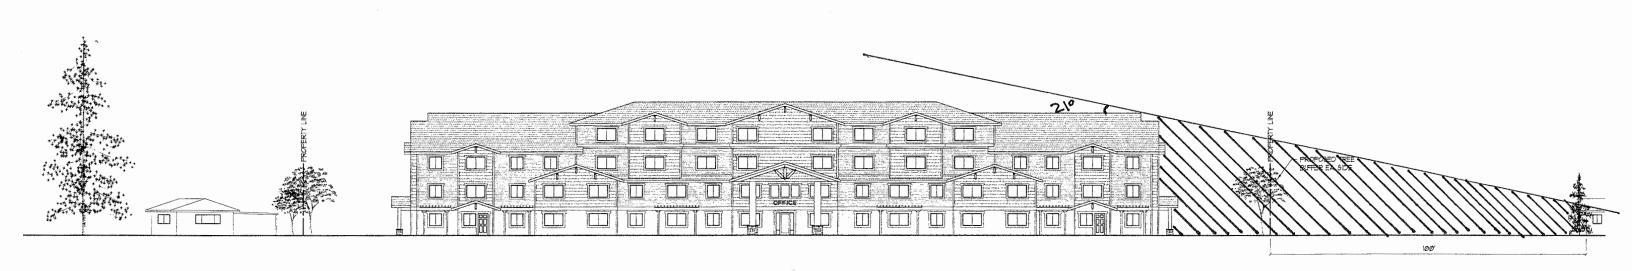

SOLAR STUDY 12:00 DECEMBER 21

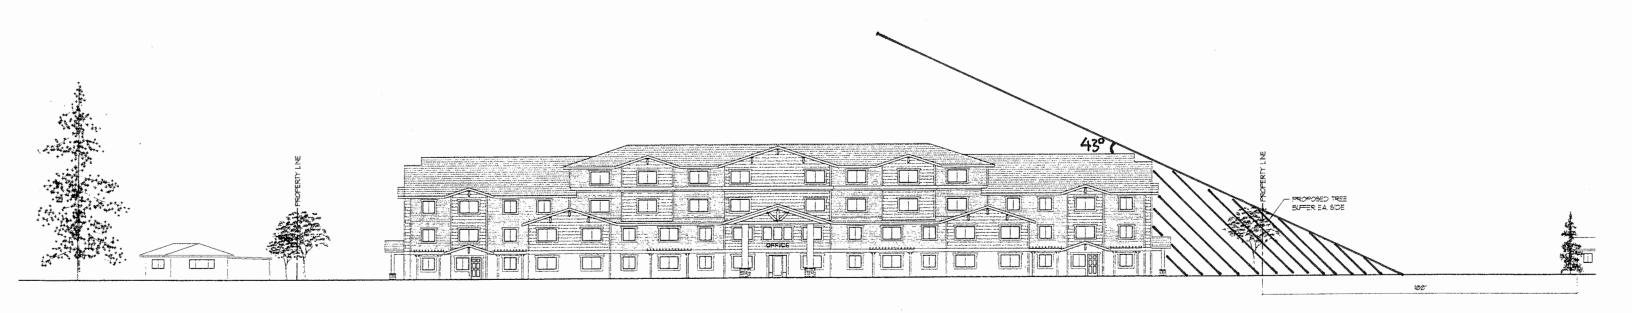

SOLAR STUDY 12:00 MARCH 21

12:00 September 21



SOLAR STUDY 12:00 JUNE 21