




W:\Commercial\Clients\G\Glenn Wells\- Stoll Road\171083 - Stoll Road Apartments\171083- SP01.0.dwg, 2/20/2019 2:23:17 PM, TODD JACKSON Drafting Servic

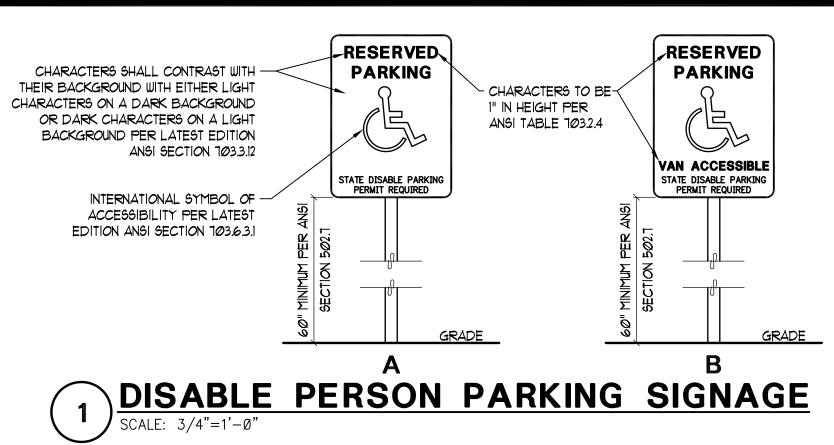

- CHAIN-LINK FENCE GATE W/ VINYL SLATS COLOR TO MATCH BUILDING

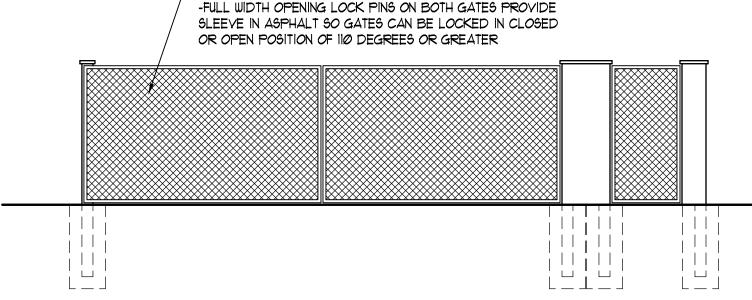


DUMPSTER FRONT ELEVATION SCALE: $1/4"=1'-\emptyset"$

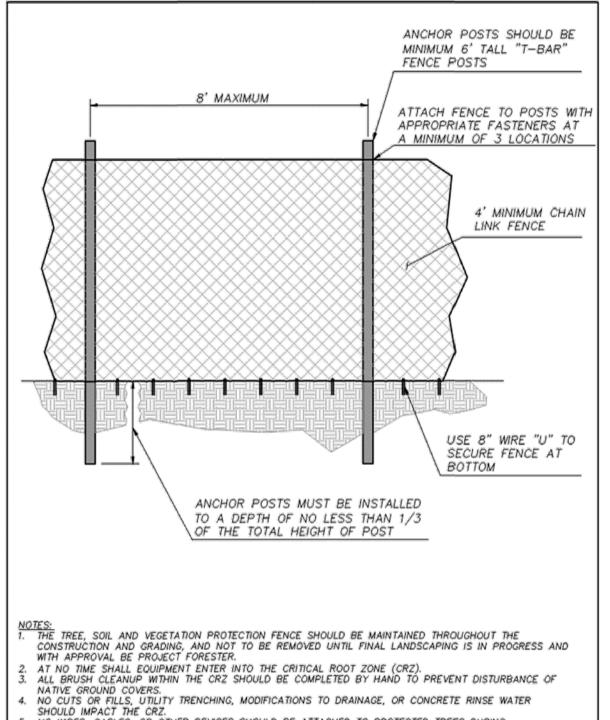


NO WIRES, CABLES, OR OTHER DEVICES SHOULD BE ATTACHED TO PROTECTED TREES DURING CONSTRUCTION.


IF IMPACTS MUST OCCUR WITHIN THE CRZ, CONTACT PROJECT FORESTER PRIOR TO THE OPERATIONS TO

DETERMINE THE PROPER	PROCEDONE 16	PROTECT THE TREE S HEALTH.	
APPROVED BY	REVISED DATE	CITY OF OLYMPIA	STD. DWG. NO.
FRAN R. EIDE, PE	12/08/2017	TREE PROTECTION FENCE	5-20
CITY ENGINEER			

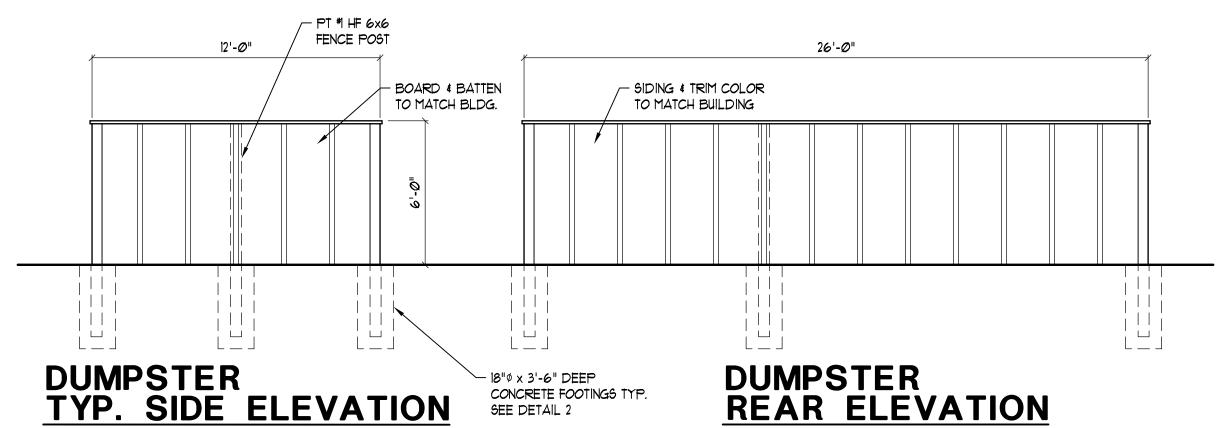


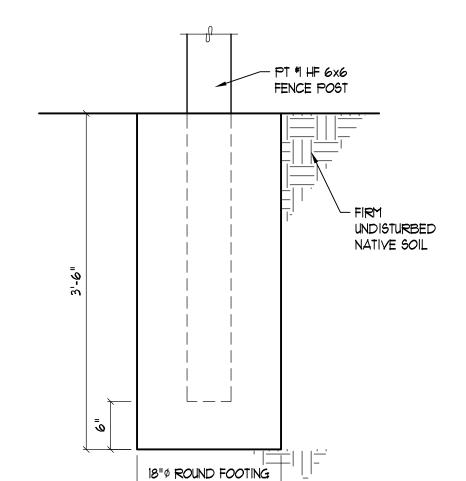


CONCRÉTE POLE FOOTING FOR TIMBER FENCE POST

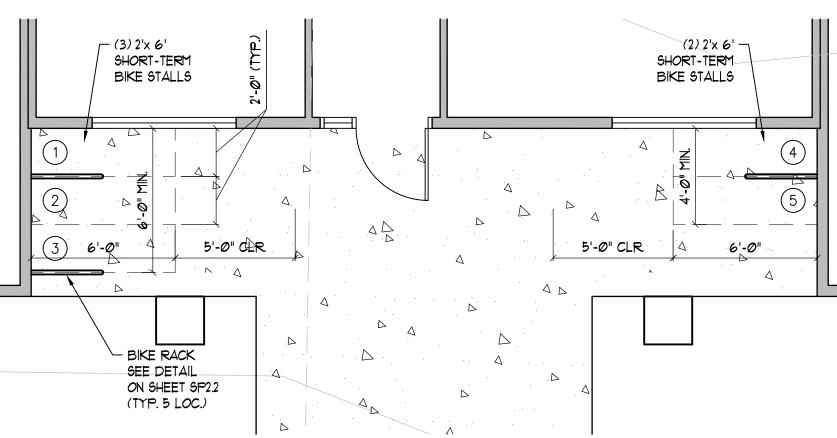

TYPICAL SHORT TERM BIKE STALLS

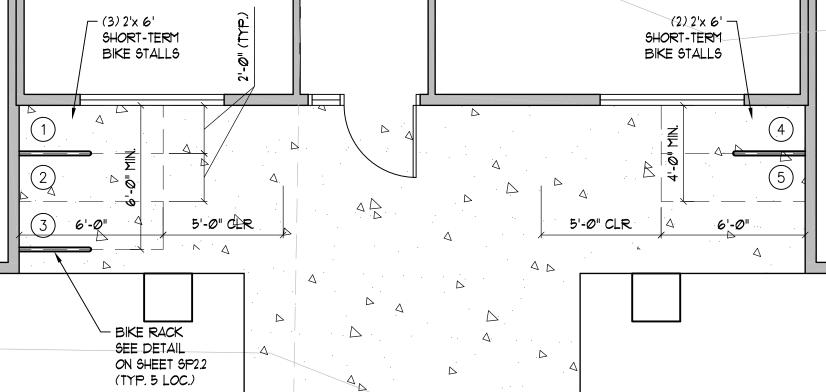

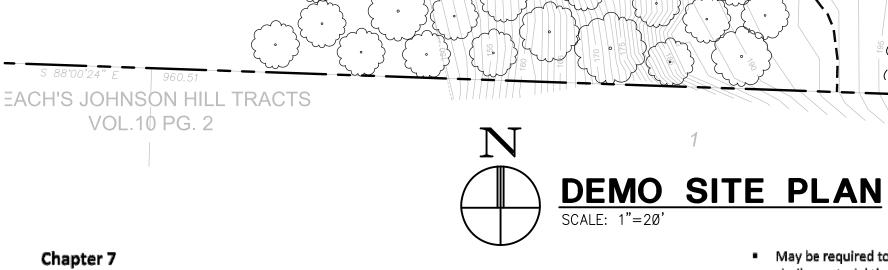

Chapter 7 Tree Protection Measures

GE CITY BERRY TRAC

(115) EXISTING WETLAND BUFFER TREES

TO REMAIN RANGING IN SIZE FROM

6 TO 36 INCHES DBH.

VOL. 9 PG. 7

7.1 Placing Materials near Trees

No person may conduct any activity within the protected area of any tree designated to remain including but not limited to parking equipment, placing solvents, storing building material and soil deposits, dumping concrete washout and locating burn holes


7.2 Attachments to Trees

During construction no person shall attach any object to any tree designated for protection

7.3 Protective Barrier

Before development, land clearing, filling or any land alteration for which a Tree Removal Permit is required, the applicant:

 Shall erect and maintain readily visible protective tree fencing along the outer edge and completely surrounding the protected area of all protected trees or groups of trees. Fences shall be constructed of chain link and at least four feet high, unless other type of fencing is authorized by the Urban Forester

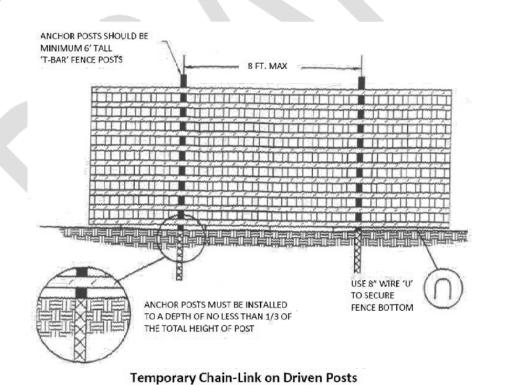

 May be required to cover with mulch to a depth of at least six (6) inches or with plywood or similar material the areas adjoining the critical root zone of a tree in order to protect roots from

- EXIST. BUILDINGS

TO BE DEMO'D

damage caused by heavy equipment Shall prohibit excavation or compaction of earth or other potentially damaging activities within

TO BE REMOVED

TREE PROTECTION FENCE

TO BE DEMO'D

L EXIST. DRAINFIELD

TO BE REMOVED

- May be required to minimize root damage by excavating a two (2) foot deep trench to cleanly sever the roots of trees to be retained Shall maintain the protective barriers in place until the Urban Forester authorizes their removal
- or a final Certificate of Occupancy is issued, whichever occurs first Shall ensure that any landscaping done in the protected zone subsequent to the removal of the

barriers shall be accomplished with light machinery or hand labor 7.4 Grade


- 1. The grade shall not be elevated or reduced within the critical root zone of trees to be preserved without the Urban Forester's authorization. The Urban Forester may allow coverage of up to onehalf of the area of the Tree's critical root zone with light soils (no clay) to the minimum depth necessary to carry out grading or landscaping plans, if it will not imperil the survival of the tree. Aeration devices may be required to ensure the tree's survival
- 2. If the grade adjacent to a preserved tree is raised such that it could slough or erode the tree's critical root zone, it shall be permanently stabilized to prevent suffocation of the roots
- 3. The applicant shall not install an impervious surface within the critical root zone of any tree to be retained without the authorization of the Urban Forester. The Urban Forester may require specific construction methods and/or use of aeration devices to ensure the tree's survival and to minimize the potential for root induced damage to the impervious surface
- 4. To the greatest extent practical, utility trenches shall be located outside of the critical root zone of trees to be retained. The Urban Forester may require that utilities be tunneled under the roots of trees to be retained if the Urban forester determines that trenching would significantly reduce the chances of the trees survival
- 5. Trees and other vegetation to be retained shall be protected from erosion and sedimentation

7.5 Directional Felling

Directional felling of trees shall be used to avoid damage to trees designated for retention


7.6 Additional Requirements

The Urban Forester may require additional tree protection measures which are consistent with accepted urban forestry practices

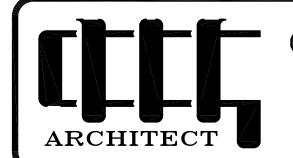

GLENN C WELLS, A.I.A.

324 WEST BAY DRIVE SUITE 102 OLYMPIA, WA 98502 (360) 352-4553

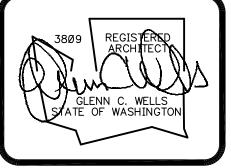

<u>date: 02</u>-28-17 drawn: R.C.T. checked: G.C.W.

city issue: 09-05-18 LAND-USE REVISION

revisions: 02-20-19 LAND-USE REVISION

DEMO SITE PLAN AND DETAILS STOLL ROAD APARTMENTS

501 STOLL ROAD OLYMPIA, WASHINGTON

sheet no.

title:

SP2.0