Development of 28 units of multi-family affordable housing consisting of one- and two-bedroom sizes.

OLYMPIA CREST III APARTMENTS

PROJECT TEAM

OWNER	
Housing Author	rity of Thu

ABBREVIATIONS

ADJACENT ADJUSTABLE

ALUMINUM

APARTMENT

AUDIO VISUAL

BUILDING

BOTTOM OF

CORNER GUARD

CLOTHES HOOK CONTROL JOINT

CONCRETE MASONRY UNIT

CONTRACTOR SUPPLIED & CONTRACTOR

CENTER LINE

CEILING

CARPET

DOUBLE

DOWN DOWNSPOUT

DOOR

DETAIL DRAWING

DRAWER

EXISTING

EACH

EQUAL

EQUIPMENT

ELEVATION

FACTORY FINISH

FLOOR DRAIN

FINISH FLOOR

FACE OF CONCRETE

FACE OF STRUCTURE

FINISH

FLOOR

FACE OF

GAUGE

GLASS

HOLLOW CORE

FIRE EXTINGUISHER CABINET

FIRE DEPARTMENT CONNECTION

EXTERIOR

INSTALLED

DEMOLITION

DIMENSION

DIAMETER

CONCRETE

CONTINUOUS

CONSTRUCTION

ARCHITECT(URAL)

ACOUSTICAL CEILING TILE

ABOVE FINISH FLOOR

ACT

ARCH

BLDG

CONC

CONT

CONST

DN

EQ

EXT

FD

FO

FOC

FOS

GALV

INSUL

EQUIP

EL/ELEV

ВО

MWA Architects 1206 12th Avenue SE 70 NW Couch Street, Suite 401 Portland, Oregon 97209 Olympia, WA 98501 Contact: Bob Ricks, Deputy Director Contact: Chad Sanderson, AIA T: 360-918-5819 T: 503-416-8002 E: bobr@hatc.org

ARCHITECTURAL

Gibbs & Olson 1157 3rd Avenue #219 Longview, WA 98632 Contact: Carol Ruiz, PE T: 360-425-0991 E: csanderson@mwaarchitects.com E: cruiz@gibbs-olson.com

MECH

MIN

MTL

NTS

OSOI OSCI

PLYWD

PREFIN

REF

REINF REQ'D

CIVIL

LAVATORY

MAXIMUM

MINIMUM

METAL

MECHANICAL

MANUFACTURER

NOT IN CONTRACT

NOT TO SCALE

OPPOSITE HAND OPPOSITE

PLASTIC LAMINATE

PRESSURE TREATED

PAPER TOWEL DISPENSER

OWNER SUPPLIED & OWNER INSTALLED

OWNER SUPPLIED & CONTRACTOR

ON CENTER

INSTALLED

PLYWOOD

PREFINISHED

PANEL

PAINT

PLATE

LANDSCAPE

MacDonald Environmental Planning 9020 SW Washington Square Road #410 Portland, OR 97223 Contact: Laurel Macdonald Bonnell, ASLA T: 503-224-1225 E: Imacdonald@mep-pc.com

STRUCTURAL

Waypoint Engineering

601 Main Street #400

T: 360-635-6611

Vancouver, WA 98660

Contact: Jared Fischer, PE

E: jared@waypointwa.com

Interface Engineering 100 SW Main Street #1600 Portland, OR 97204 Contact: Andrew Lasse, PE T: 503-382-2615 E: andrewl@interfaceeng.com

MEP

SHEET INDEX

GENERAL

G1.00	COVER SHEET
G2.00	ZONING AND SITE CODE PLAN
G3.00	ASSEMBLIES

CIVIL

L3.01	PLANTING PLAN	
L4.01	FURNITURE AND NATURE PLAY	
L4.02	PLANT PALETTE	
L4.03	PLANT PALETTE	

A1.00	SITE PLAN
A2.11	BUILDING 1 GROUND/SECOND FLOOR PLANS
A2.12	BUILDING 1 ROOF PLAN
A2.15	BUILDING 1 REFLECTED CEILING PLANS
A2.21	BUILDING 2 GROUND/SECOND FLOOR PLANS
A2.22	BUILDING 2 ROOF PLAN
A2.25	BUILDING 2 REFLECTED CEILING PLANS
A2.31	BUILDING 3 GROUND/SECOND FLOOR PLANS
A2.32	BUILDING 3 ROOF PLAN
A2.35	BUILDING 3 REFLECTED CEILING PLANS
A3.11	ENLARGED UNIT PLANS
A4.11	BUILDING 1 ELEVATIONS
A4.21	BUILDING 2 ELEVATIONS
A4.31	BUILDING 3 ELEVATIONS
A5.11	BUILDING 1 SECTIONS
A5.21	BUILDING 2 SECTIONS
A5.31	BUILDING 3 SECTIONS

S2.11	BUILDING 1 - FOUNDATION/SECOND FLOOR FRAMING PLAN
S2.12	BUILDING 1 - ROOF FRAMING PLAN
S2.31	BUILDING 3 - FOUNDATION/SECOND FLOOR FRAMING PLAN
S2.32	BUILDING 3 - ROOF FRAMING PLAN
S7.11	BUILDING 1 - SHEARWALL/HOLD-DOWN SCHEDULE AND DETAILS
S7.12	BUILDING 1 - TYPICAL WOOD DETAILS
S7.13	BUILDING 1 - TYPICAL WOOD DETAILS
S7.14	BUILDING 1 - TYPICAL WOOD DETAILS
S7.31	BUILDING 3 - SHEARWALL/HOLD-DOWN SCHEDULE AND DETAILS
S7.32	BUILDING 3 - TYPICAL WOOD DETAILS
S7.33	BUILDING 3 - TYPICAL WOOD DETAILS
a= - :	DIW DIVIO A TOTAL WOOD DETAILS

VICINITY MAP

SYMBOLS - ARCHITECTURAL

SHEET NO.

- SHEET NO.

- DETAIL NO.

DETAIL NO.

SHEET NO.

DETAIL NO.

SHEET NO.

- DETAIL NO.

- SHEET NO.

\AX.XX✓

1-

\AX.XX/

1_

AX.XX

ROOM NAME

101

101

(X)

<u>(x)</u>

DRAWING TITLE

BUILDING

WALL SECTION

DETAIL KEY

DOOR MARK

KEYNOTE

WINDOW MARK

ASSEMBLY TYPE

ROOM NAME/NUMBER

EXTERIOR ELEVATION







REVISION NO

FINISH TO BE FLUSH

SLOPE TO DRAIN

AREA/FLOOR DRAIN

INTERNATIONAL

SYMBOL OF

ACCESSIBILITY

NORTH ARROW

GRID BUBBLE

CEILING HEIGHT

FLOOR TRANSITION

ELEVATION HEIGHT

WORK POINT, CONTROL

REVISION MARK AND

CLOUD

POINT, OR DATUM POINT

FIRE EXTINGUISHER CABINET

CENTERLINE

F.E.C.

+0'-0"

T.O. WALL 9'-0"

OC-III **APARTMENTS**

206 LILLY RD NE OLYMPIA, WA 95806

DATE 10/14/2020 SCALE 12" = 1'-0" PROJECT NUMBER

SCHEMATIC DESIGN

202010.00 DRAWN BY

ISSUANCE

DRAWING TITLE

SHEET NUMBER

COVER SHEET

RADIUS **RUBBER BASE** REFRIGERATOR REINFORCE REQUIRED ROOM ROUGH OPENING

RM RO SELF ADHESIVE MEMBRANE SOLID CORE SCHEDULE SMOKE DETECTOR SQUARE FEET SHEET SHTG SIM SOG SPECS SHEATHING SIMILAR SLAB ON GRADE **SPECIFICATIONS** STAINLESS STEEL SS STD STANDARD STEEL

STRUCT STRUCTURAL T/TEMP TEMPERED GLASS TO TOC TOSR TOP OF CONCRETE TOP OF SINK RIM TOLS TOP OF LOWER SHELF TOW TOP OF WALL TS TYP TUBE STEEL TYPICAL

WITH

UNO UNLESS NOTED OTHERWISE GALVANIZED VCT VINYL COMPOSITION TILE GENERAL CONTRACTOR VIF VERIFY IN FIELD VERT VERTICAL GYPSUM BOARD WASHER HOSE BIBB

WC WATER CLOSET HOLLOW METAL HORIZONTAL WOOD WDW WINDOW W/O WITHOUT INTERIOR WO WHERE OCCURS WEATHER RESISTIVE BARRIER/ INSULATION AIR BARRIER

C1.00 SITE PLAN

_	LAND	SCAPE
	L3.01	PLANTING PLAN
	L4.01	FURNITURE AND NATURE PLAY
	L4.02	PLANT PALETTE
	L4.03	PLANT PALETTE

ARCHITECTURAL

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STRUCTURAL

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S7.34	BUILDING 3 - TYPICAL WOOD DETAILS

ENERGY CODE REQUIREMENTS

PROVISIONS SHOWN ARE F	OR RESIDENT	TAL STRUCTUR	ES
	REQ	PROVIDED	
	ASSEMBLY MAXIMUM	MIN R VALUE	
ROOFS			
INSULATION ENTIRELY ABOVE DECK	U-0.032	R-30ci	X
METAL BUILDING	U-0.037	R-19+R-11 Ls R-25+R-8 Ls	Х
ATTIC AND OTHER	U-0.021	R-49	Х
WALLS ABOVE GRADE			
MASS	U-0.090	R-11.4ci	Х
METAL BUILDING	U-0.050	R-0+R-19ci	Х
STEEL FRAMED	U-0.064	R-13+R-7.5ci	Х
WOOD FRAME AND OTHER	U-0.064	R-13+R-3.8ci or R-20	Х
WALLS BELOW GRADE			X
BELOW GRADE WALL	C-0.092	R-10ci	Х
FLOORS			
MASS	C-0.051	R-16.7ci	Х
STEEL JOIST	C-0.038	R-30	X
WOOD FRAMED AND OTHER	C-0.033	R-30	X
SLAB ON GRADE FLOORS			
UNHEATED	F-0.520	R-15 for 24"	X
HEATED	F-0.668	R-20 for 48"	Х
OPAQUE DOORS			
SWINGING	U-0.370		X
NON SWINGING	U-0.310		Х

VERTICAL FENESTRATIONS		REQUIR	PROVIDED	
	MAX U	MAX SHGC	MIN VT/SHGC	
NON METAL FRAMING - ALL	0.31	0.36	1.10	Х
METAL FRAME - FIXED	0.38	0.36	1.10	Х
METAL FRAME - OPERABLE	0.46	0.36	1.10	Х
METAL FRAME - ENTRANCE DOORS	0.68	0.36	1.10	Х
SKYLIGHTS				Х
ALL	0.50	0.40	0	X

AIR BARRIER SYSTEM REQUIREMENTS

THE AIR BARRIER SYSTEM IS AN AIR TIGHT BUILDING ENCLOSURE AND IS COMPRISED OF MULTIPLE PRODUCTS THAT FORM A CONTINUOUS PATH THAT CONTROLS INFILTRATION OR EXFILTRATION OF AIR. ADDITIONAL DESCRIPTIONS AND SYSTEM REQUIREMENTS ARE AS FOLLOWS:

1. THE AIR TIGHT COMPONENTS OF THE BUILDING ENCLOSURE AND THE JOINTS, JUNCTURES AND TRANSITIONS BETWEEN MATERIALS, PRODUCTS AND ASSEMBLIES FORMING THE AIR TIGHTNESS OF THE BUILDING ENCLOSURE ARE CALLED THE "AIR BARRIER SYSTEM". SERVICES INCLUDE COORDINATION BETWEEN THE TRADES, THE PROPER SCHEDULING AND SEQUENCING OF THE WORK, AND PRECONSTRUCTION MEETINGS.

2. THE CONTRACTOR SHALL ENSURE THAT THE INTENT OF CONSTRUCTING THE BUILDING ENCLOSURE WITH A CONTINUOUS AIR BARRIER SYSTEM TO CONTROL AIR LEAKAGE, INTO OR OUT OF THE CONDITIONED SPACE IS ACHIEVED. THE AIR BARRIER SYSTEM SHALL HAVE THE FOLLOWING CHARACTERISTICS:

A. IT MUST BE CONTINUOUS, WITH ALL JOINTS SEALED.

B. IT MUST BE STRUCTURALLY SUPPORTED TO WITHSTAND POSITIVE AND NEGATIVE AIR PRESSURES APPLIED TO THE BUILDING ENCLOSURE.

C. CONNECTION SHALL BE MADE BETWEEN: 1. FOUNDATION AND WALLS 2. WALLS AND WINDOWS/DOORS

DUCT PENETRATIONS

3. DIFFERENT WALL SYSTEMS 4. WALL AND ATTIC ROOF/CEILING ASSEMBLY 5. WALLS, FLOORS, AND ROOF AT UTILITY, PIPE AND

3. AIR BARRIER PENETRATIONS: ALL PENETRATIONS OF THE AIR BARRIER AND PATHS OF AIR INFILTRATION/EXFILTRATION SHALL BE SEALED.

4. AIR BARRIER TESTING: (1) AIR BARRIER TEST MUST BE PERFORMED AND SUBMITTED TO THE JURISDICTION HAVING AUTHORITY ONCE THE TEST IS COMPLETE; (2) IF TEST RESULTS EXCEED 0.4 CFM/FT2 AT 0.3 IN. WG IN ACCORDANCE WITH ASTM E779 THEN VISUALLY INSPECT AIR BARRIER AND SEAL NOTED SOURCES OF LEAKAGE; (3) SUBMIT A FOLLOW-UP REPORT TO JURISDICTION HAVING AUTHORITY NOTING CORRECTIVE MEASURES TAKEN.

PARKING SUMMARY

		FROM ZONING CODE
	REQUIRED	PROVIDED
MIN ON SITE PARKING	42 SPACES	44
STANDARD		28
ACCESSIBLE		0
EXISTING		14
MINIMUM BICYCLE PARKING	SEE BELOW	SEE BELOW

SHORT TERM BIKE PARKING

	NING CODE
# UNITS REQUIRED (1 PER 10 UNITS) PROV	IDED
28 3 TB	D

LONG TERM BIKE PARKING

CODE: 1 PER UNIT X 28 = 28

1 BEDROOM: IN UNIT STORAGE = 20 2 BEDROOM: EXTERIOR STORAGE = 8

TOTAL SPACES PROVIDED: 28

ROOM NUM

ROOM NAME

LONG TERM STORAGE RM BIKE PARKING

SUBTOTAL

FROM ZONING CODE **ROOM AREA** WALL HUNG STAPLE COUNT COUNT XXX XXX XXX

XXX

TOTAL LONG TERM STORAGE XXXX

XXX

LONG TERM IN-UNIT BIKE PARKING

ROOM TYPE	ROOM AREA SF	BIKE HOOK COUNT
XXX	XXX	1 PER ROOM
	SUBTOTAL	XXX

TOTAL LONG TERM STORAGE

SEE UNIT PLANS FOR LOCATION AND KEYNOTE.

ZONING DATA

SHORT-TERM BIKE PARKING

HEIGHT

ZOMING DATA				
ZONING CLAS	SSIFICAT	ION: MEDICAL SERVICE	E (MS)	
BASE ZONE:	IEDICAL SERVICE			
PLAN OVERLAY	MS - MEDICAL SERVICE			
OVERLAY ZONE	DESIGN ZONE - D			
ALLOWED USES	FULL-SERVICE HEALTH CARE FACILITIES, COMPLEMENTARY HEALTH CARE FACILITIES, COMMERICAL SERVICES FOR MEDICAL USERS AND EMPLOYEES, HIGH DENSITY HOUSING NEAR MEDICAL FACILITIES TO HELP MEET THE NEEDS OF THOSE EMPLOYED THERE.			
STREET CLASSIFICATIONS	LILLY F	RD NE - MINOR ARTERIA	AL	
	FAR RE	QUIREMENTS		
MINIMUM FAR		REQUIRED	PROVIDED	
MINIMUM DENSITY CHAPTER 18.06, TABLE 6.02		18 UNITS / ACRE	28 TOTAL	
MAXIMUM DENSITY CHAPTER 18.06, TABLE 6.02		30 UNITS / ACRE	28 TOTAL	
L	OT SIZE	REQUIREMENTS		
MINIMUM LOT SIZE		7,200 SF	62,292 SF	
MAXIMUM LOT COVERAGE CHAPTER 18.06, TABLE 6.02		MAXIMUM - 50%	31,146 SF	
MINIMUM LOT WIDTH		80'	100'	
MINIMUM LOT DEPTH		NOT REGULATED	600'	
SETBAC	K STAN	DARD REQUIREMENTS		
FRONT YARD (NORTH)		MAXIMUM - 10'-0"	10'-0"	
SIDE YARD (EAST)		MINIMUM - 10'-0"	41'-5" - 54'-0"	
REAR YARD (SOUTH)		MINIMUM - 15'-0"	95'-3"	
SIDE YARD (WEST)		MINIMUM - 10'-0"	15'-0"	
(OTHER F	REQUIREMENTS		
MAXIMUM LANDSCAPING ARE	ΞA	60%	15% - 7,905 SF	
PARKING		1.5 SPACES / UNIT	1.25 / UNIT	
LONG-TERM BIKE PARKING		1 SPACE / UNIT	TBD	

GENERAL BUILDING INFO

	BUILDING OWNER:	HOUSING AUTHORITY OF THURSTON COUNTY (HATC)
	PERMIT APPLICANT	HATC, MWA ARCHITECTS
	PROJECT ADDRESS	206 LILLY RD NE, OLYMPIA, WA 95806
AR	LEGAL DESCRIPTION	XXX

APPLICABLE CODES:

SEISMIC ZONE:

- 2015 INTERNATIONAL BUILDING CODE • (IBC BASED ON 2015 IBC, 2015 EXISTING BUILDING CODE, AND 2009 ICC/ANSI A117.1)
- 2015 INTERNATIONAL RESIDENTIAL CODE (IRC) W STATE AMENDMENTS 2ND EDITION
- 2015 INTERNATIONAL MECHANICAL CODE (IMC) W STATE
- AMENDMENTS 3RD EDITION 2015 INTERNATIONAL FIRE CODE (IFC) W STATE AMENDMENTS
- 2015 UNIFORM PLUMBING CODE (UPC) W STATE AMENDMENTS 2015 WASHINGTON ENERGY CODE (WAC)

COMMERCIAL - WAC 51-11C 3RD ADDITION **RESIDENTIAL - WAC 51-11C** 4TH PRINTING

BUILDING DESCRIPTION

(3) TWO-STORY APARTMENT BUILDINGS WITH (20) 1 BEDRROM AND (8) 2 BÉDROOM UNITS FOR (28) UNITS TOTAL.

BUILDING SIZE: BUILDING 1: 2,632 SF BUILDING 2: 3,925 SF

BUILDING USE: MULTI-FAMILY RESIDENTIAL HOUSING

BUIDING ADJACENCIES: MEDICAL OFFICES AND OLYMPIA CREST PHASES I & II

BUILDING 3: 3,958 SF

ARCHITECT'S STATEMENT

- THE UNDERSIGNED HAS PROVIDED BUILDING ENCLOSURE DOCUMENTS
- THAT IN MY PROFESSIONAL JUDGEMENT ARE APPROPRIATE TO SATISFY THE REQUIREMENTS OF RCW 64.55.005 THROUGH 64.55.090 AND SECTIONS 1
- THROUGH 10 OF HB1848.

1 SPACE / UNIT

27'-8"

1 SPACE / 10 UNITS

75'-0"

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SUITE 401 PORTLAND, OR 97209 P 503 973 5151 F 503 973 5060 MWAARCHITECTS.COM

70 NW COUCH STREET





REVISION NO

OC-III **APARTMENTS**

206 LILLY RD NE OLYMPIA, WA 95806

ISSUANCE SCHEMATIC DESIGN DATE

10/14/2020 SCALE As indicated

PROJECT NUMBER 202010.00


DRAWN BY

DRAWING TITLE ZONING AND SITE CODE

SHEET NUMBER

PLAN



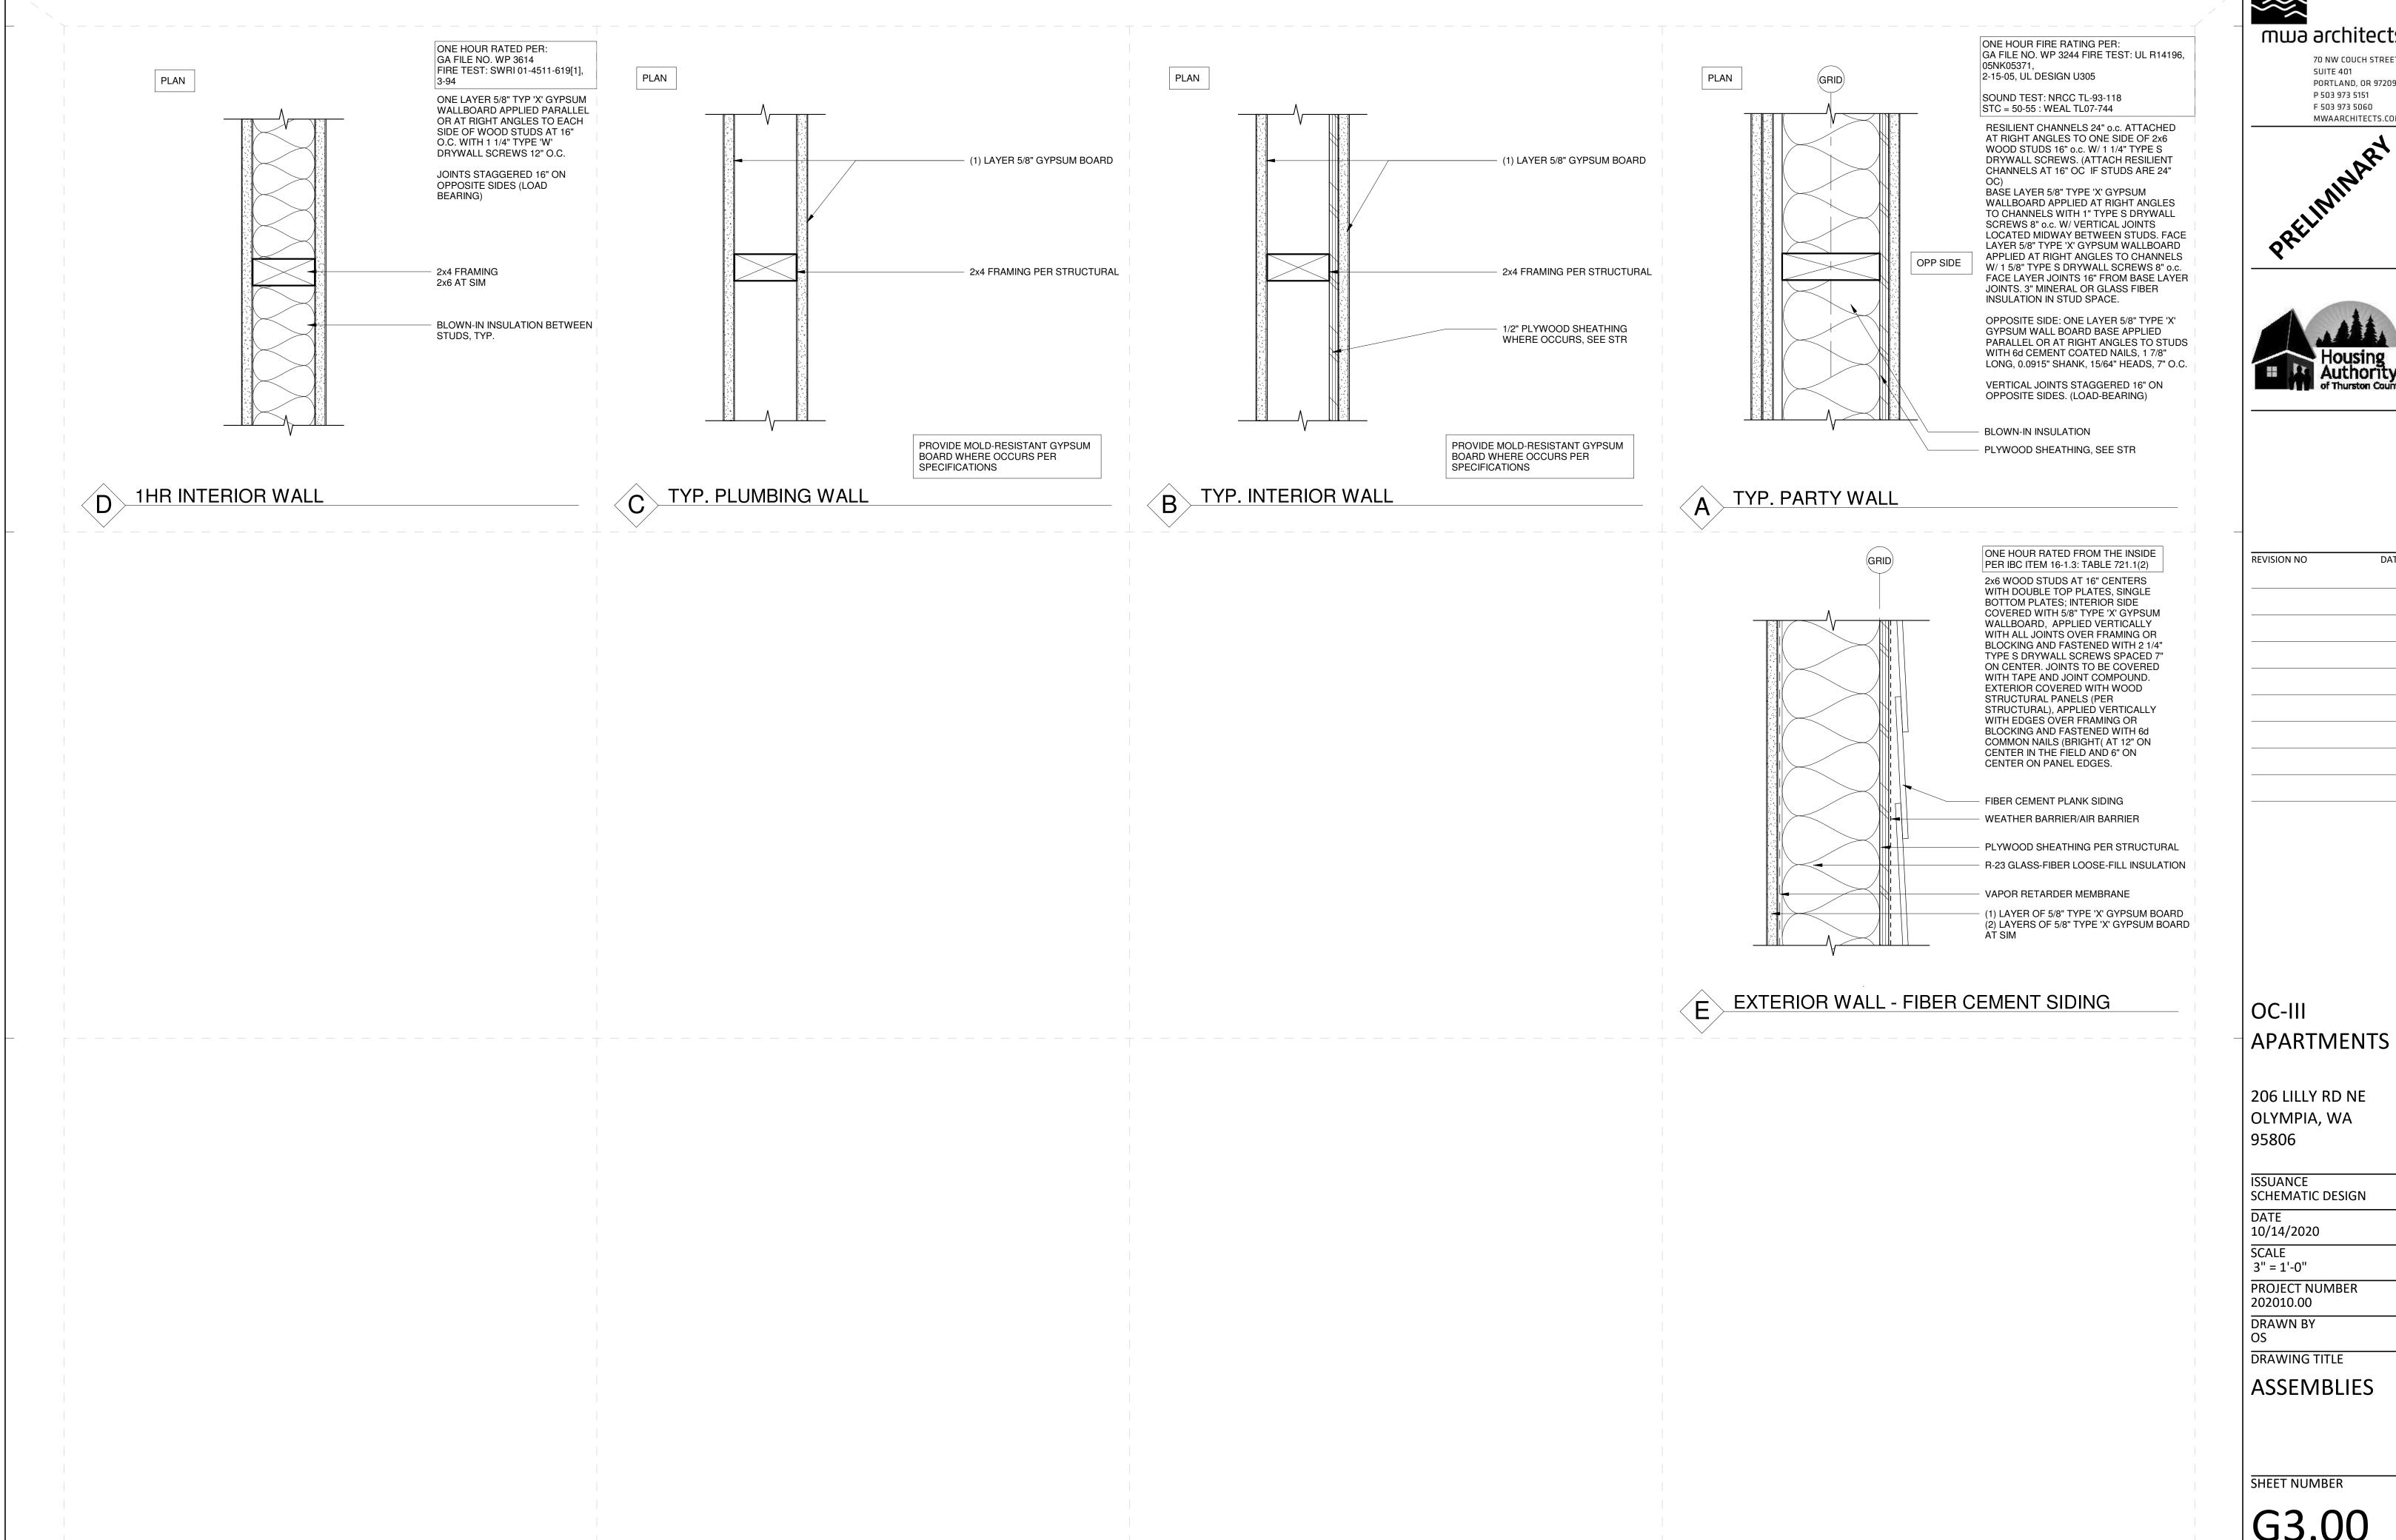

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REVISION NO

206 LILLY RD NE OLYMPIA, WA

ISSUANCE SCHEMATIC DESIGN

10/14/2020


3" = 1'-0"

PROJECT NUMBER


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SHEET NUMBER

G3.00




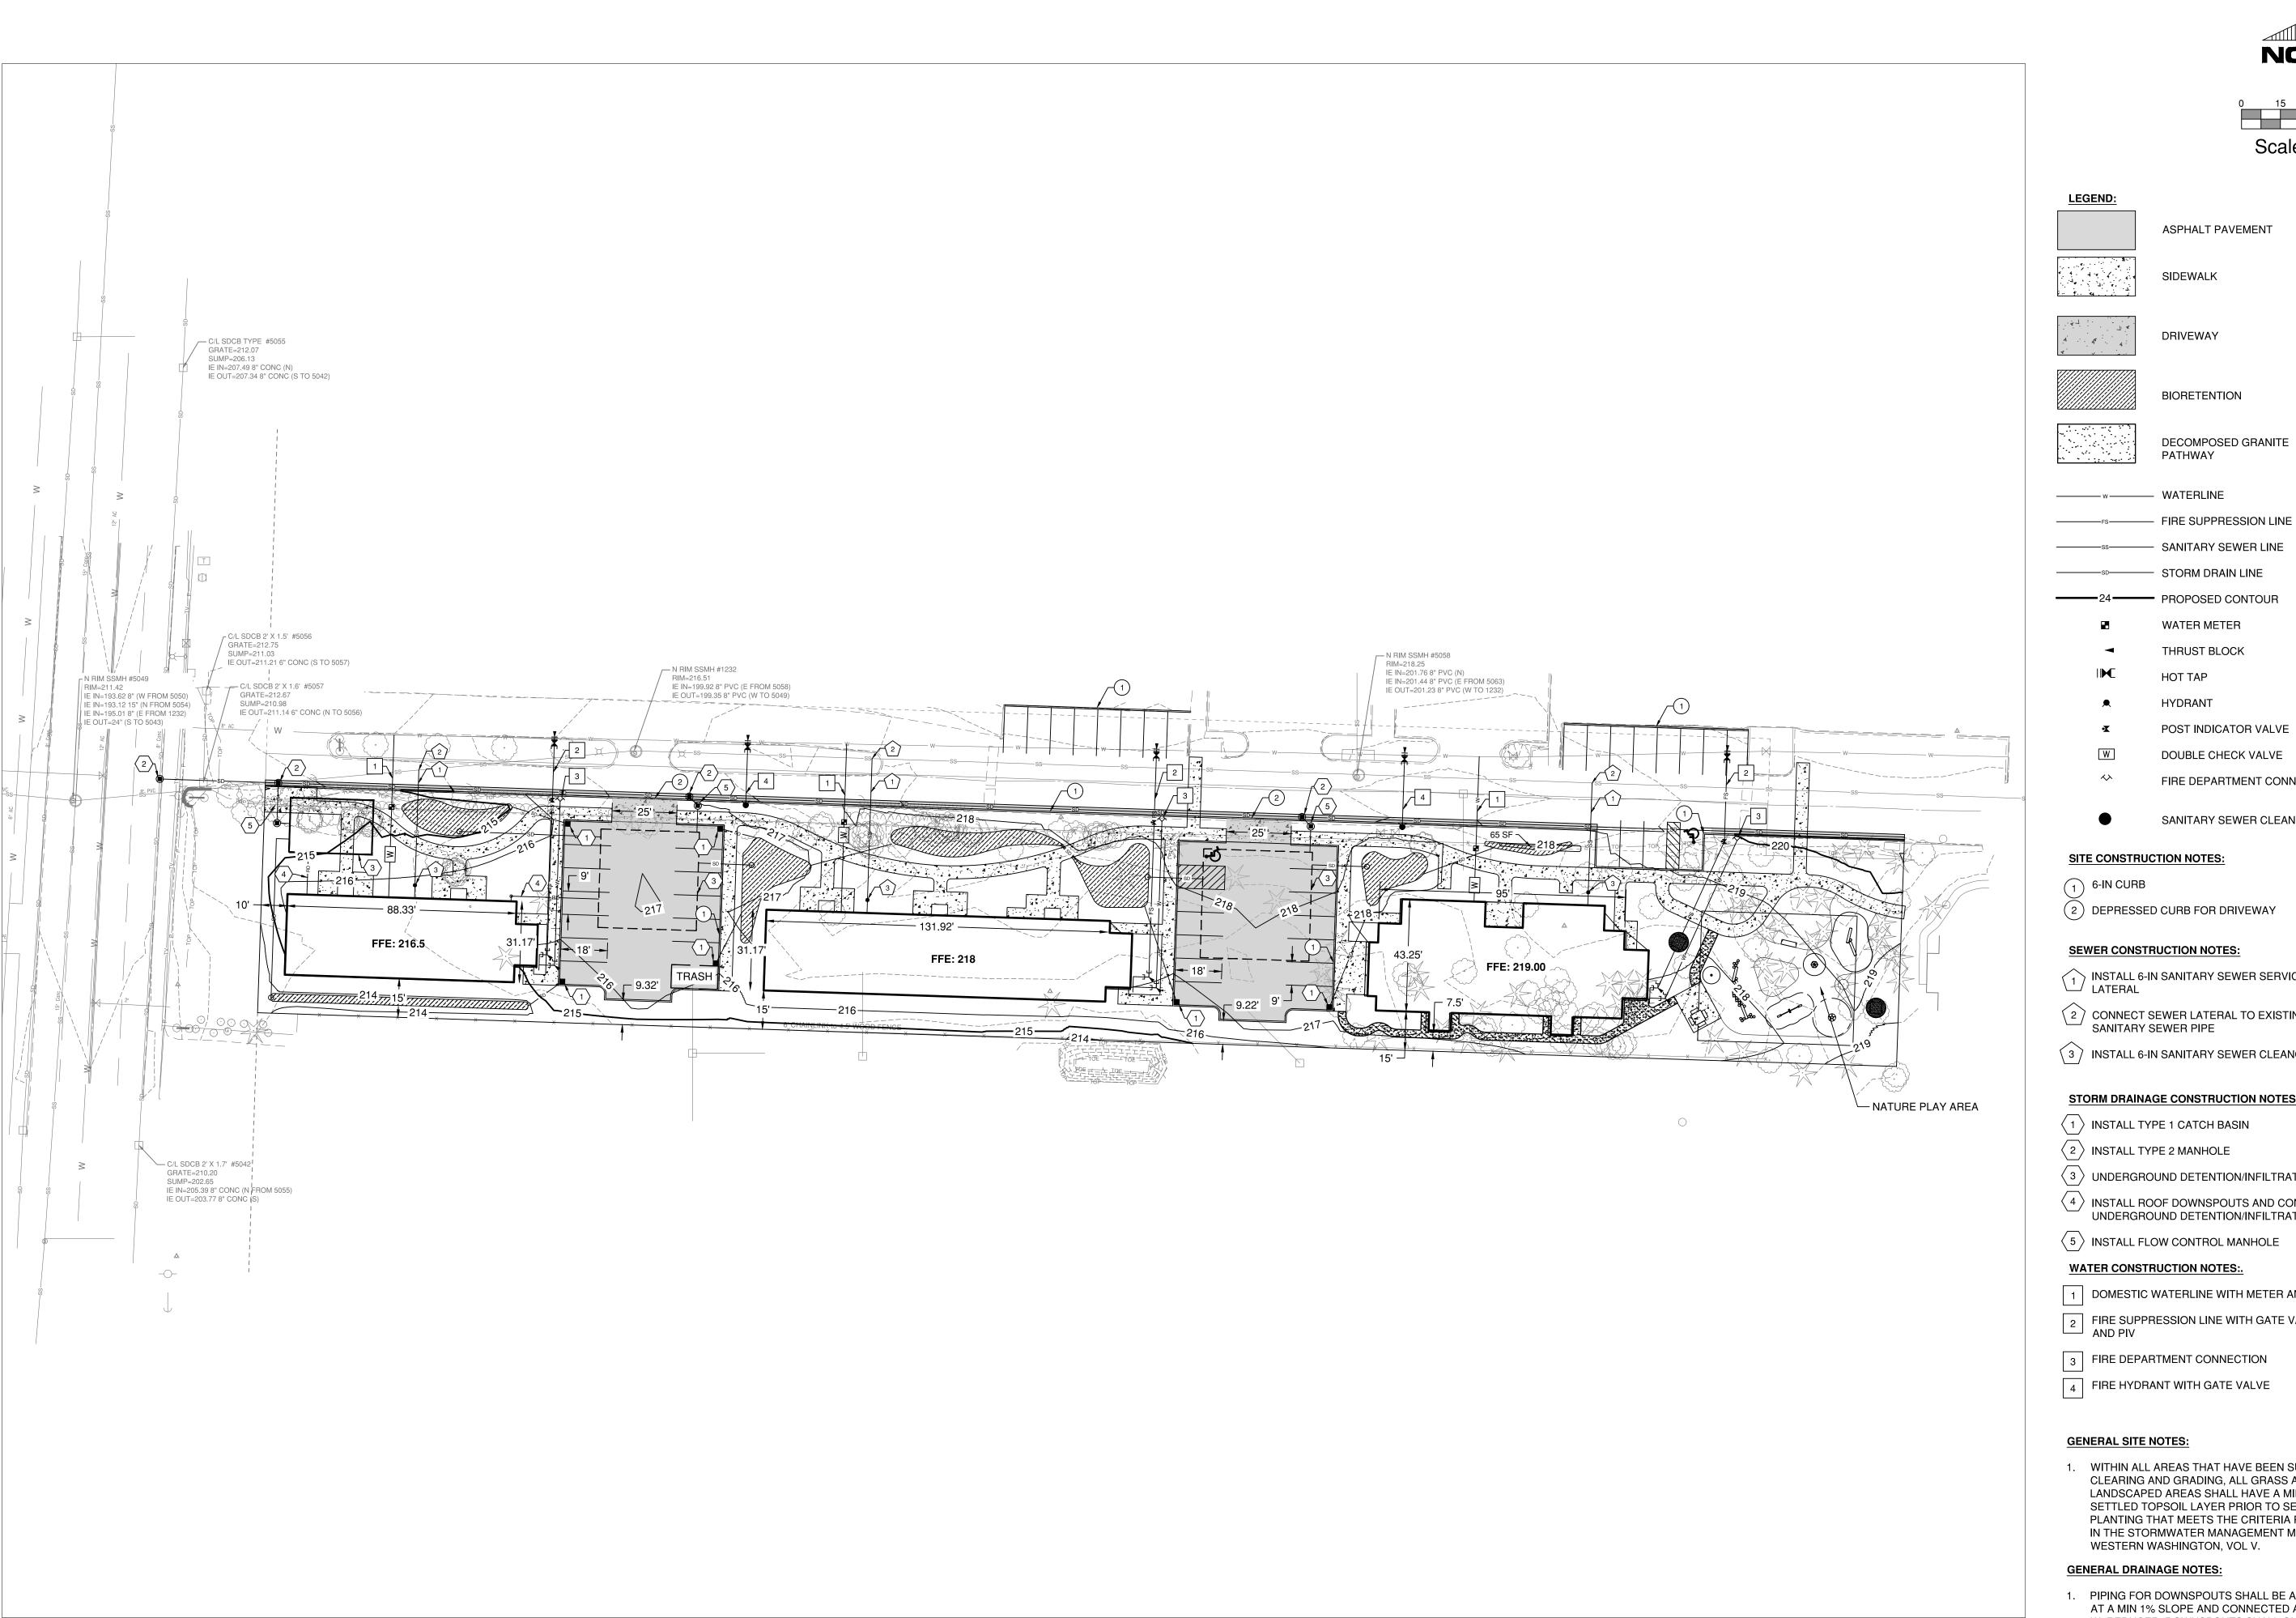

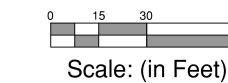


LEGEND:

ASPHALT PAVEMENT

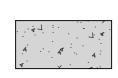

DRIVEWAY

SIDEWALK

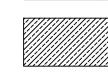

BIORETENTION



DECOMPOSED GRANITE



PATHWAY

———— w——— WATERLINE

——SD———— STORM DRAIN LINE

PROPOSED CONTOUR

WATER METER

THRUST BLOCK

POST INDICATOR VALVE

DOUBLE CHECK VALVE

FIRE DEPARTMENT CONNECTION

SANITARY SEWER CLEANOUT

SITE CONSTRUCTION NOTES:

(2) DEPRESSED CURB FOR DRIVEWAY

SEWER CONSTRUCTION NOTES:

1 INSTALL 6-IN SANITARY SEWER SERVICE LATERAL

2 CONNECT SEWER LATERAL TO EXISTING SANITARY SEWER PIPE

(3) INSTALL 6-IN SANITARY SEWER CLEANOUT

STORM DRAINAGE CONSTRUCTION NOTES:.

(1) INSTALL TYPE 1 CATCH BASIN

 $\langle 2 \rangle$ INSTALL TYPE 2 MANHOLE

3 UNDERGROUND DETENTION/INFILTRATION FACILITY

4 INSTALL ROOF DOWNSPOUTS AND CONNECT TO UNDERGROUND DETENTION/INFILTRATION FACILITY

 $\langle 5 \rangle$ INSTALL FLOW CONTROL MANHOLE

WATER CONSTRUCTION NOTES:.

1 DOMESTIC WATERLINE WITH METER AND DCVA

2 FIRE SUPPRESSION LINE WITH GATE VALVE, DCDA, AND PIV

3 FIRE DEPARTMENT CONNECTION

4 FIRE HYDRANT WITH GATE VALVE

GENERAL SITE NOTES:

1. WITHIN ALL AREAS THAT HAVE BEEN SUBJECT TO CLEARING AND GRADING, ALL GRASS AND LANDSCAPED AREAS SHALL HAVE A MINIMUM 8-INCH SETTLED TOPSOIL LAYER PRIOR TO SEEDING AND PLANTING THAT MEETS THE CRITERIA PER BMP T5.13 IN THE STORMWATER MANAGEMENT MANUAL FOR WESTERN WASHINGTON, VOL V.

GENERAL DRAINAGE NOTES:

- 1. PIPING FOR DOWNSPOUTS SHALL BE A MIN. 6-IN DIA AT A MIN 1% SLOPE AND CONNECTED AT THE BLDG W/ REDUCER. DOWNSPOUTS SHALL OUTLET TO PERFORATED STUB OUT CONNECTION.
- 2. CONTRACTOR TO POTHOLE AND VERIFY EXISTING UTILITIES PRIOR TO PROPOSED CONNECTIONS



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REVISION NO

OC-III **APARTMENTS**

206 LILLY RD NE OLYMPIA, WA 95806

ISSUANCE SCHEMATIC DESIGN

10/14/2020 SCALE


12" = 1'-0" PROJECT NUMBER

202010.00 DRAWN BY Author


DRAWING TITLE

SITE PLAN

SHEET NUMBER

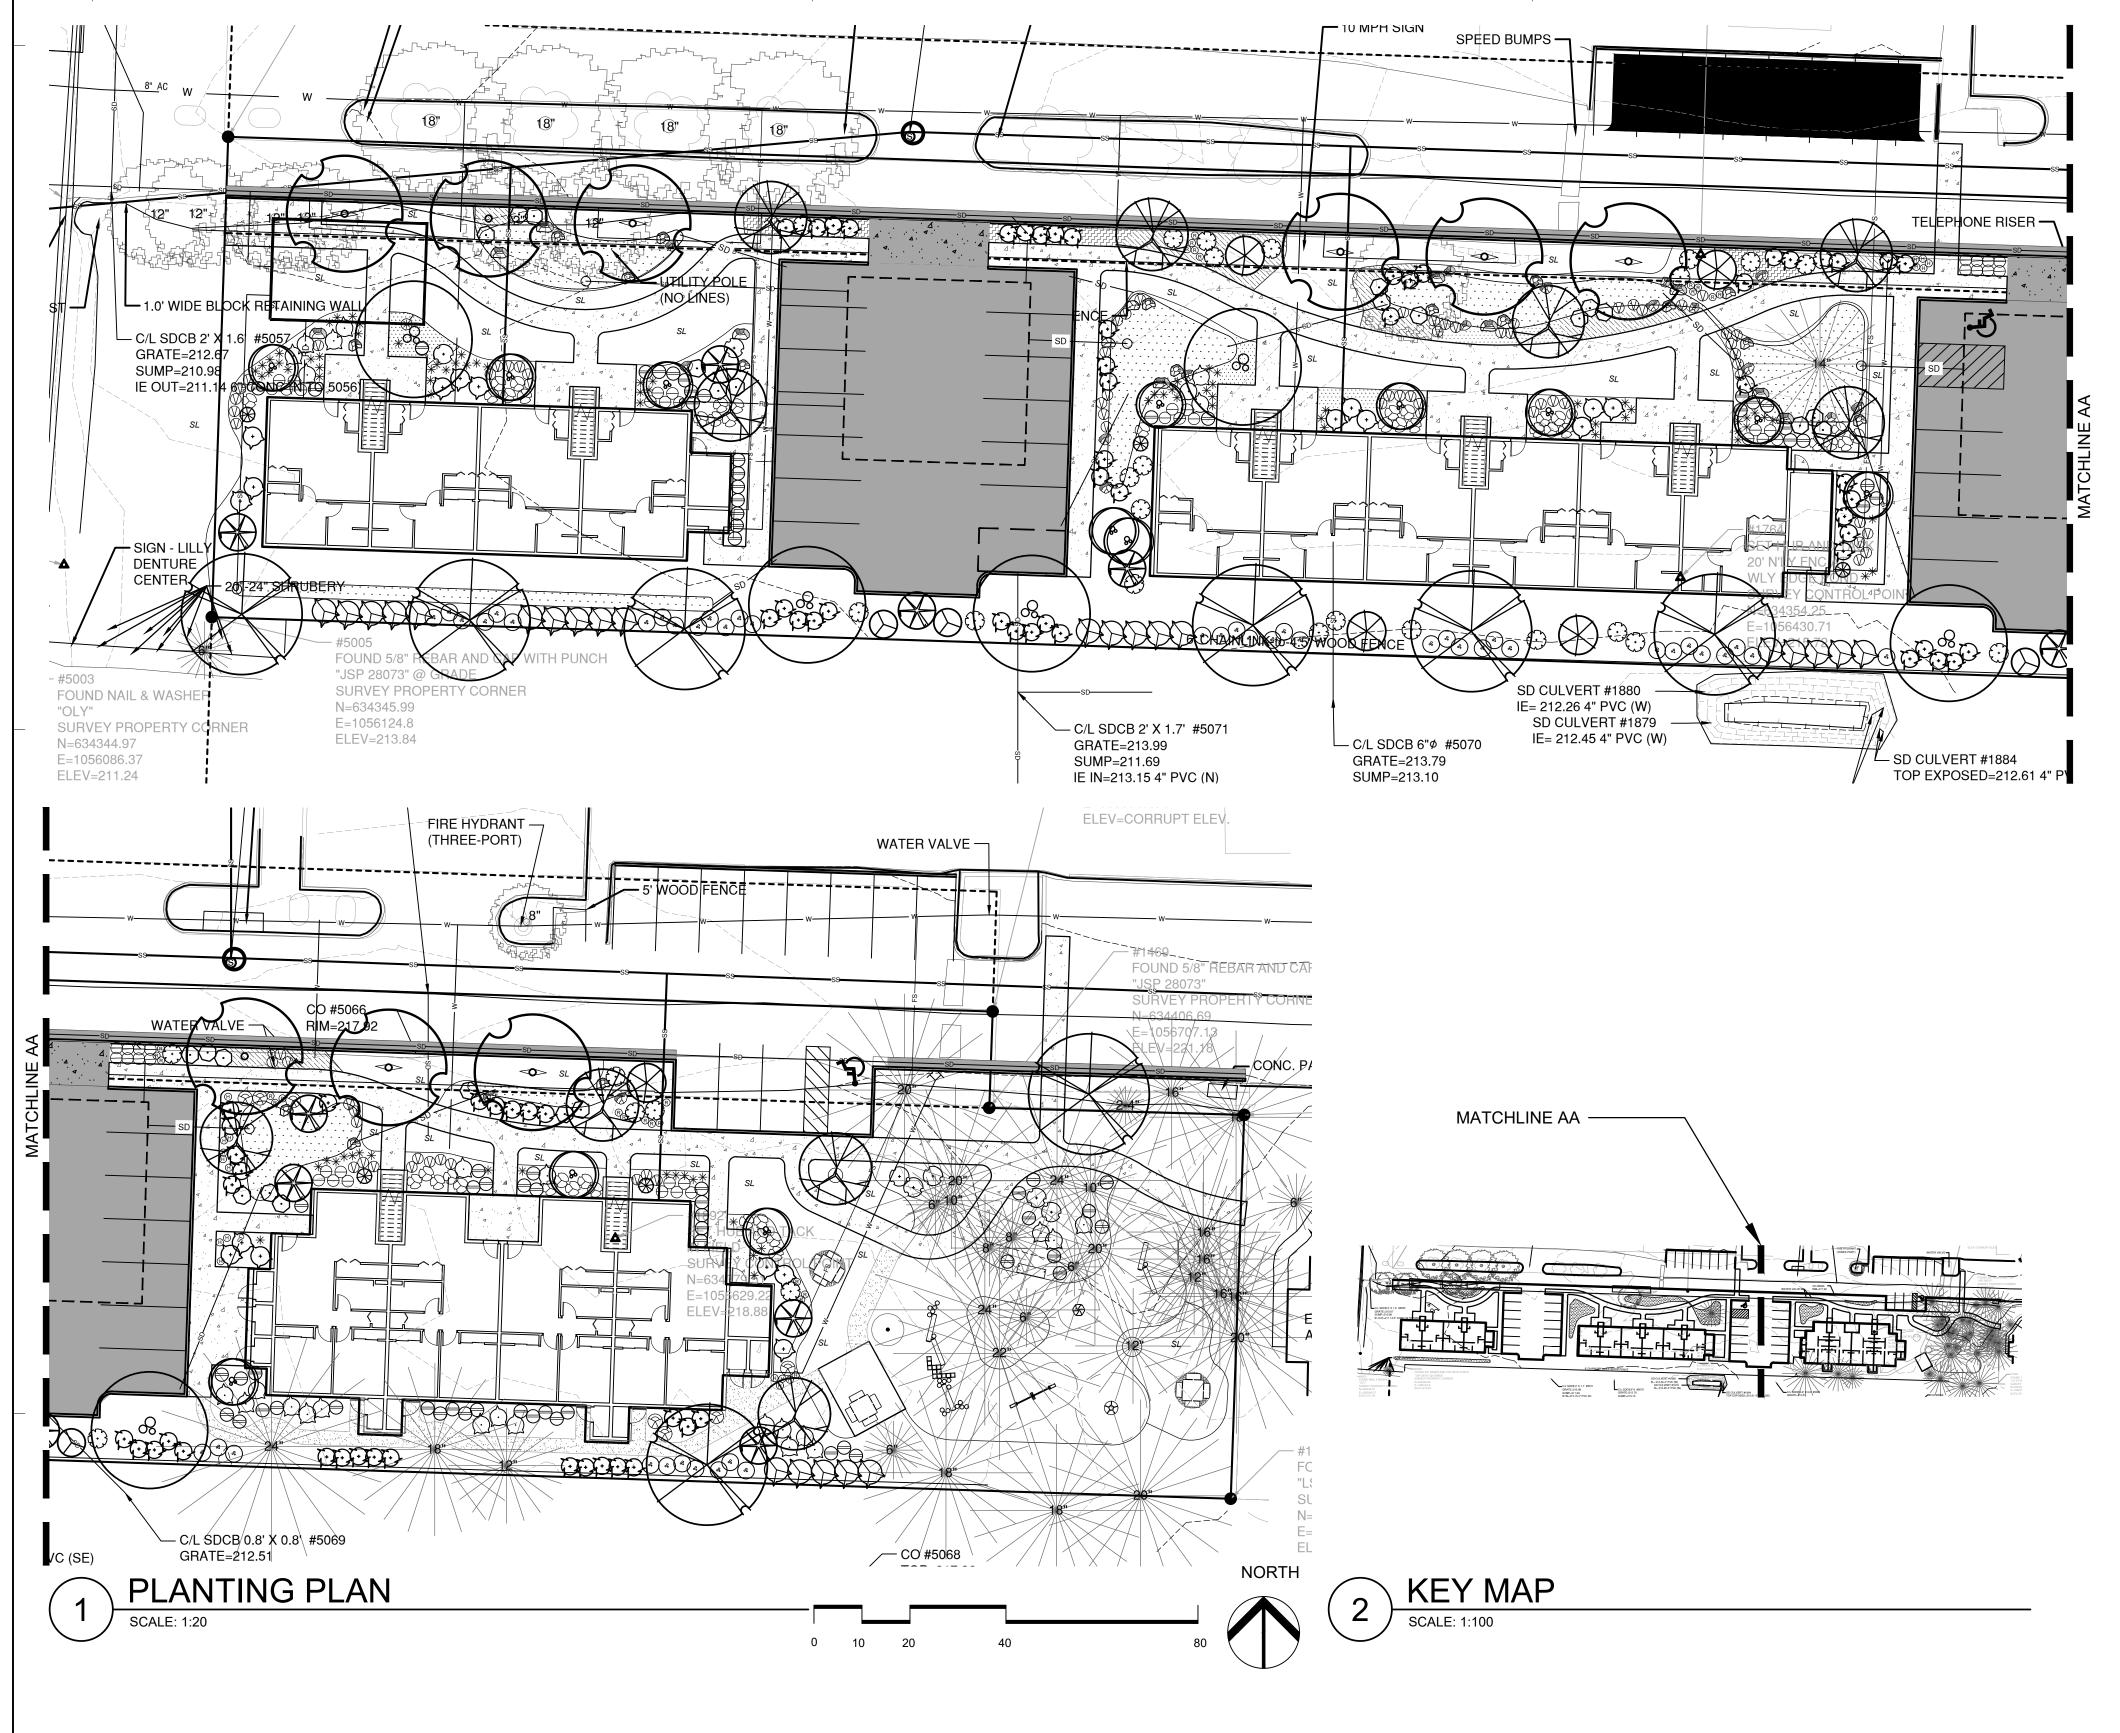

PLANT LEGEND

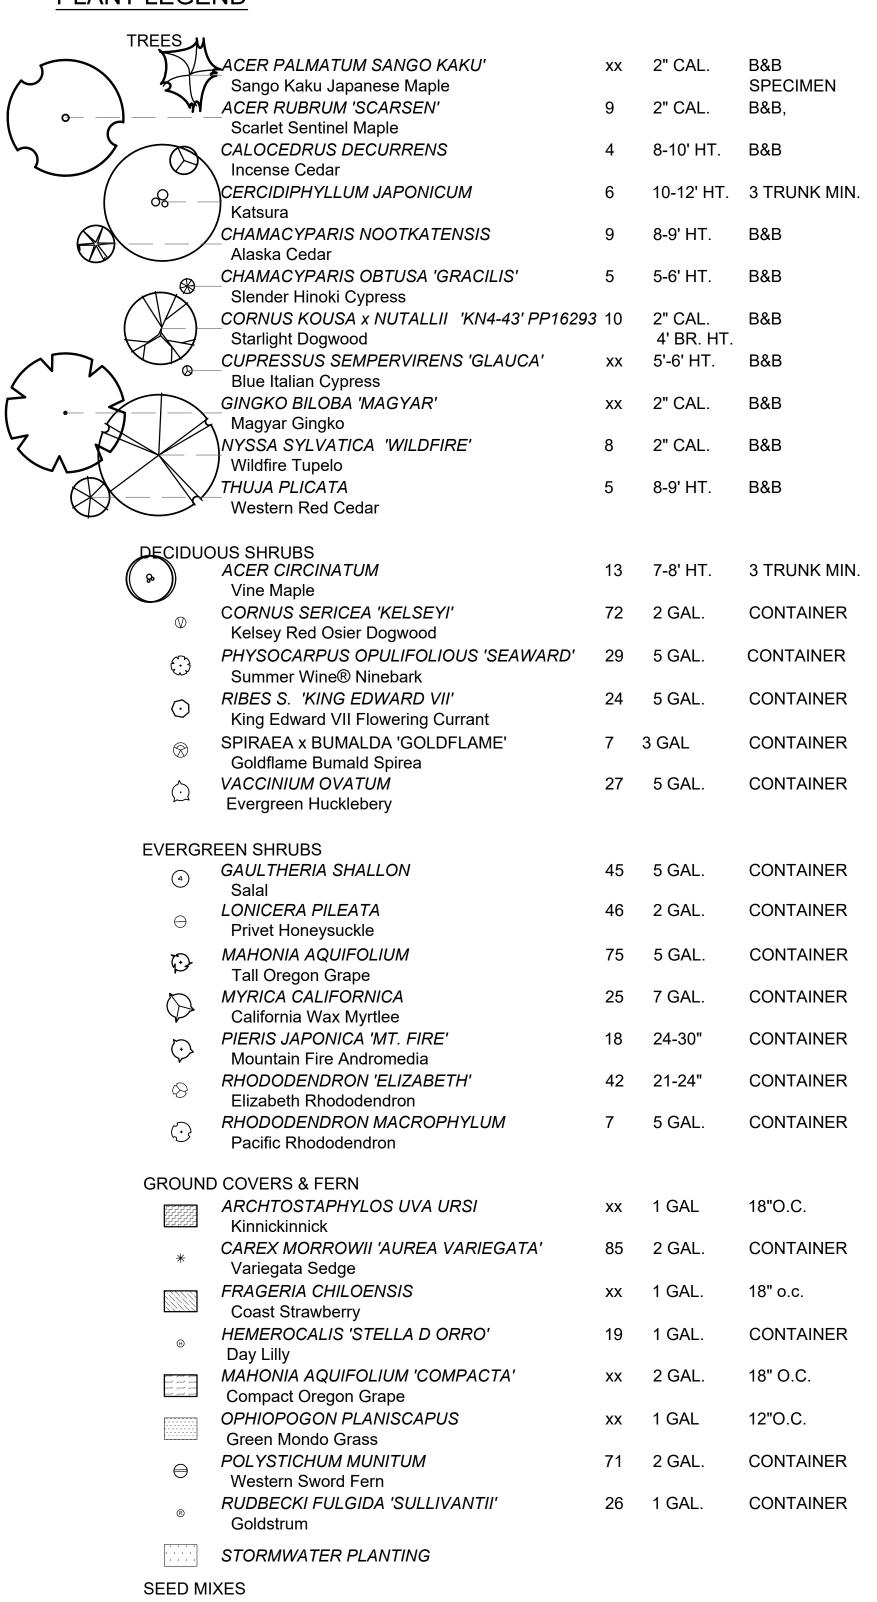

NOTES


SOUTHERN PROPERTY LINE STILL NEEDS TO 3. BE PLANTED.

SL Rough and Ready seeded lawn

- 2. ALL GROUND-COVERS HAVE NOT BEEN INCLUDED IN THIS PLAN AND STILL NEED TO BE ADDED.
- BOULDERS HAVE BEEN ADDED TO PLAN BUT HAVE NOT BEEN SCALED TO DESIRED SIZE EXPECT LARGER BOULDERS THEN DEPICTED AND POSSIBLE INCREASES IN QUANTITY.
- NATURE PLAYGROUND ELEMENTS SHALL BE BY TIMBERFORM AND WHAT IS SHOWN ARE PLACEHOLDERS

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OC-III **APARTMENTS**

206 LILLY RD NE OLYMPIA, WA 95806

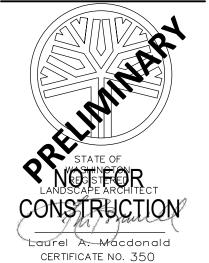ISSUANCE SCHEMATIC DESIGN 10/14/2020 SCALE 1:20 PROJECT NUMBER 202010.00 **DRAWN BY**

DRAWING TITLE

PLANTING PLAN

SHEET NUMBER

L3.01







PICNIC TABLE WITH SEATS (WOOD SLATS) - TIMBERFORM



PARKWAY PICNIC TABLE (WOOD SLATS) - TIMBERFORM



ARBOR PICNIC TABLE (WOOD SLATS) - TIMBERFORM

SITE FEATURES CHARACTER IMAGES



CHARACTER IMAGE OF SHADE STRUCTURE



CHARACTER IMAGE OF SHADE STRUCTURE





NATURE PLAY CHARACTER IMAGES





CHOSEN ALTERNATIVE FULL ROUND STEPPERS- TIMBERFORM



CHARACTER IMAGE



CHARACTER IMAGE











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REVISION NO

OC-III APARTMENTS

206 LILLY RD NE OLYMPIA, WA 95806

ISSUANCE SCHEMATIC DESIGN DATE 10/14/2020

SCALE

PROJECT NUMBER 202010.00 DRAWN BY

DRAWING TITLE

FURNITURE AND NATURE PLAY

SHEET NUMBER

L4.01

























WSTERN RED CEDAR



mwa architects 70 NW COUCH STREET SUITE 401 PORTLAND, OR 97209

P 503 973 5151 F 503 973 5060 MWAARCHITECTS.COM



REVISION NO

OC-III APARTMENTS

206 LILLY RD NE OLYMPIA, WA 95806

ISSUANCE SCHEMATIC DESIGN

DATE 10/14/2020

SCALE

PROJECT NUMBER 202010.00

DRAWN BY

DRAWING TITLE


PLANT PALETTE

SHEET NUMBER

L4.02

STARLIGHT DOGWOOD

1) DECIDUOUS SHRUBS

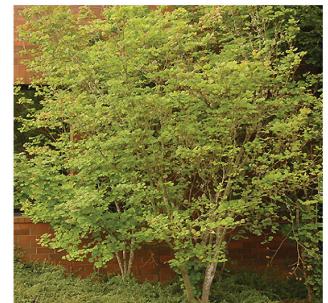












EVERGREEN HUCKLEBERRY


EVERGREEN SHRUBS

VINE MAPLE






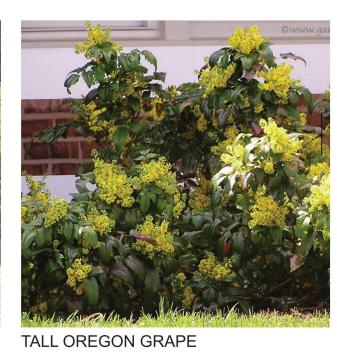

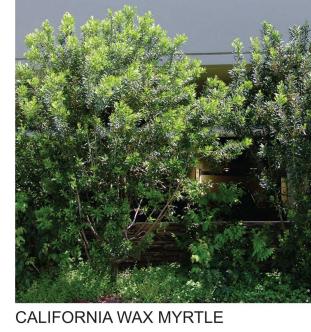




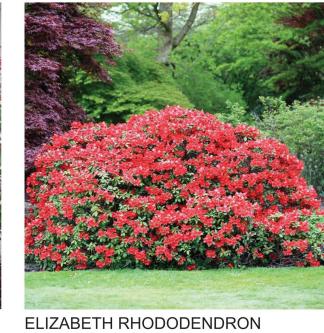




3 GROUND COVERS AND PERENNIALS

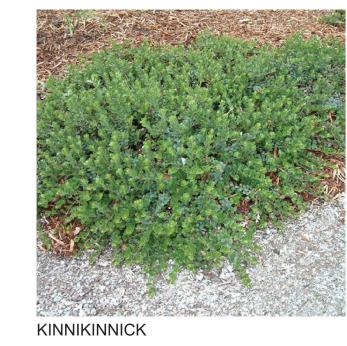







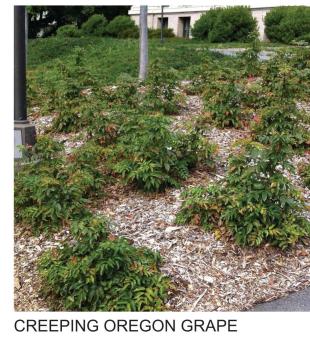







(4)SEEDED LAWN



ROUGH AND READY SEEDED TURF

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206 LILLY RD NE OLYMPAI, WA 95806 10/14/2020

PLANT PALETTE
OLYMPIA CREST III

SHEET NUMBER L4.03

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REVISION NO

OC-III

95806

DATE 10/14/2020

DRAWN BY SF

PLANT

PALETTE

SCALE

APARTMENTS


206 LILLY RD NE


ISSUANCE SCHEMATIC DESIGN

PROJECT NUMBER 202010.00

DRAWING TITLE

OLYMPIA, WA

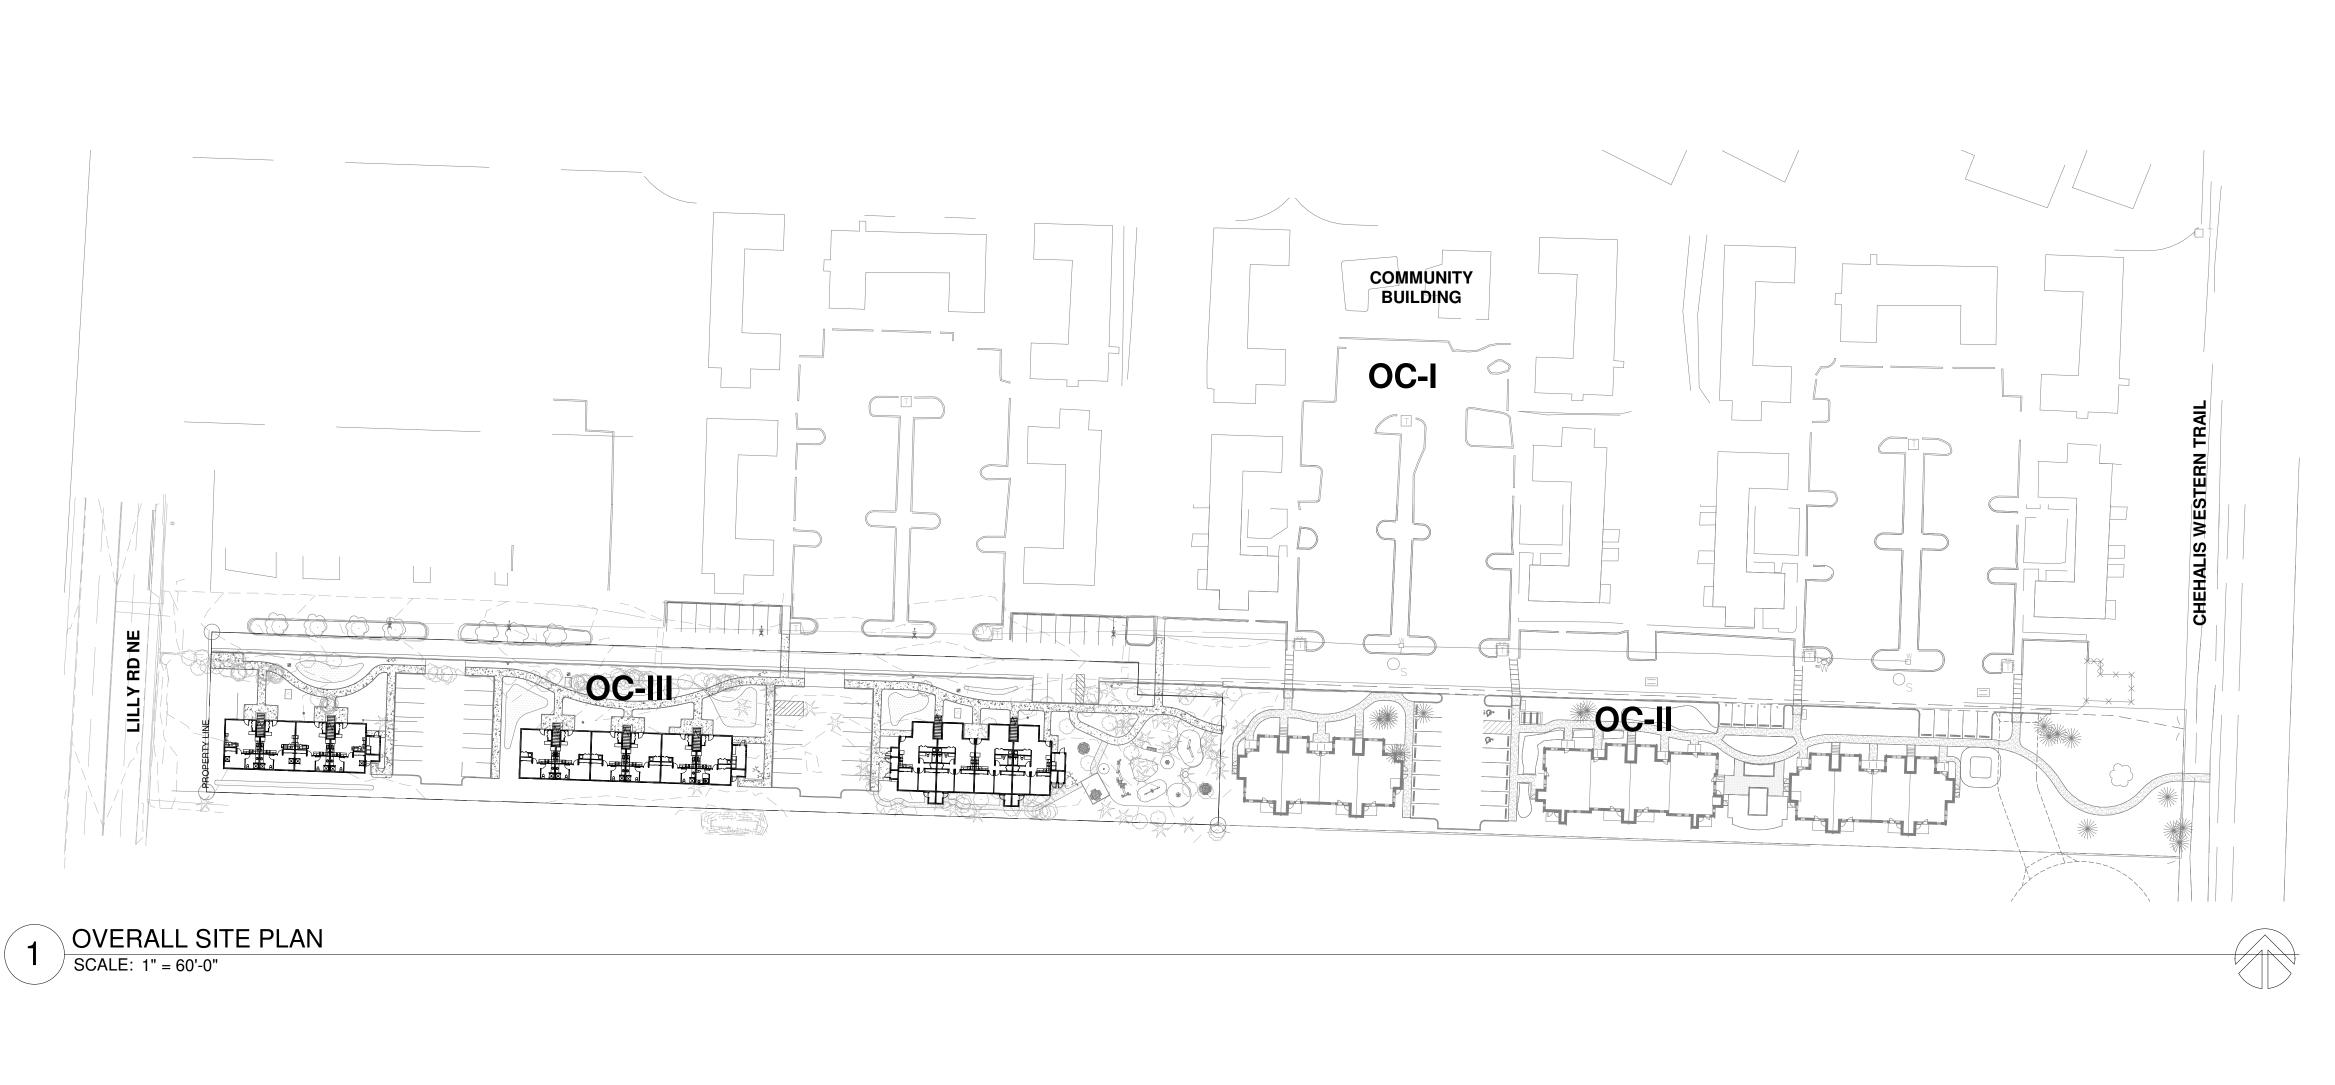

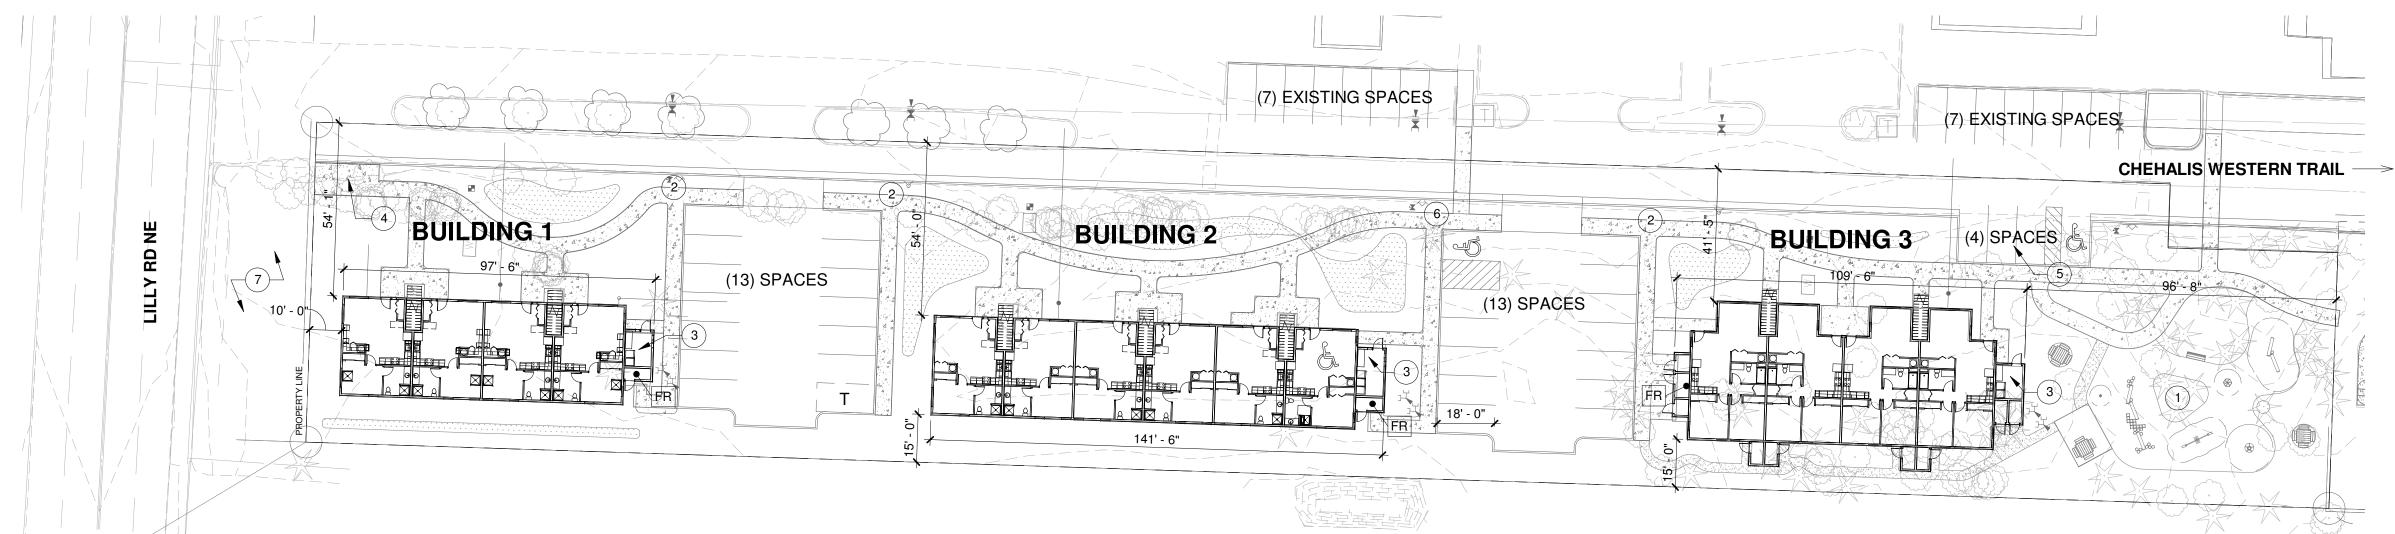

SITE PLAN SCALE: 1" = 30'-0"

SHEET GENERAL NOTES

- PROPERTY LINE BASED ON SURVEY PROVIDED BY OWNER.
- SEE CIVIL DRAWINGS FOR UTILITY EASEMENT, SITE DIMENSIONS AT PARKING, SITE UTILITIES, GRADING, EROSION CONTROL, BUILDING PAD ELEVATIONS, AND RELATED DETAILS.
- SEE LANDSCAPE DRAWINGS FOR HARDSCAPE DIMENSIONS, PLANTING, AND IRRIGATION INFORMATION.
- SEE CIVIL DRAWINGS FOR ACCESSIBILITY SITE RELATED DETAILS.
- SITE LIGHTING AND SERVICE DISTRIBUTION TO BE BIDDER DESIGNED.
- SEE CIVIL DRAWINGS FOR FIRE HYDRANT AND FDC LOCATIONS.
- DIMENSIONS AT BUILDINGS ARE TO FACE OF STUD.

KEYNOTES

- NATURE PLAY AREA, SEE LANDSCAPE
- MAILBOXES AND RECYCLING SHARED LAUNDRY
- SCHOOL BUS WAITING ZONE
- PROVIDE ELECTRIC VEHICLE CHARGING INFRASTRUCTURE
- PROVIDE COVERED AREA FOR SHORT-TERM BIKE PARKING GRASS PLANTING AND GRADING WORK TO BE PROVIDED IN THIS AREA SEE LANDSCAPE

LEGEND

— − − PROPERTY LINE

KEYNOTE

LOCATION OF ACCESIBLE PARKING SPACE/UNIT

MAIN BUILDING ENTRY

FIRE RISER ROOM

TRASH LOCATION



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APARTMENTS

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DATE 10/14/2020


SCALE As indicated PROJECT NUMBER


202010.00 DRAWN BY

DRAWING TITLE

SITE PLAN

SHEET NUMBER

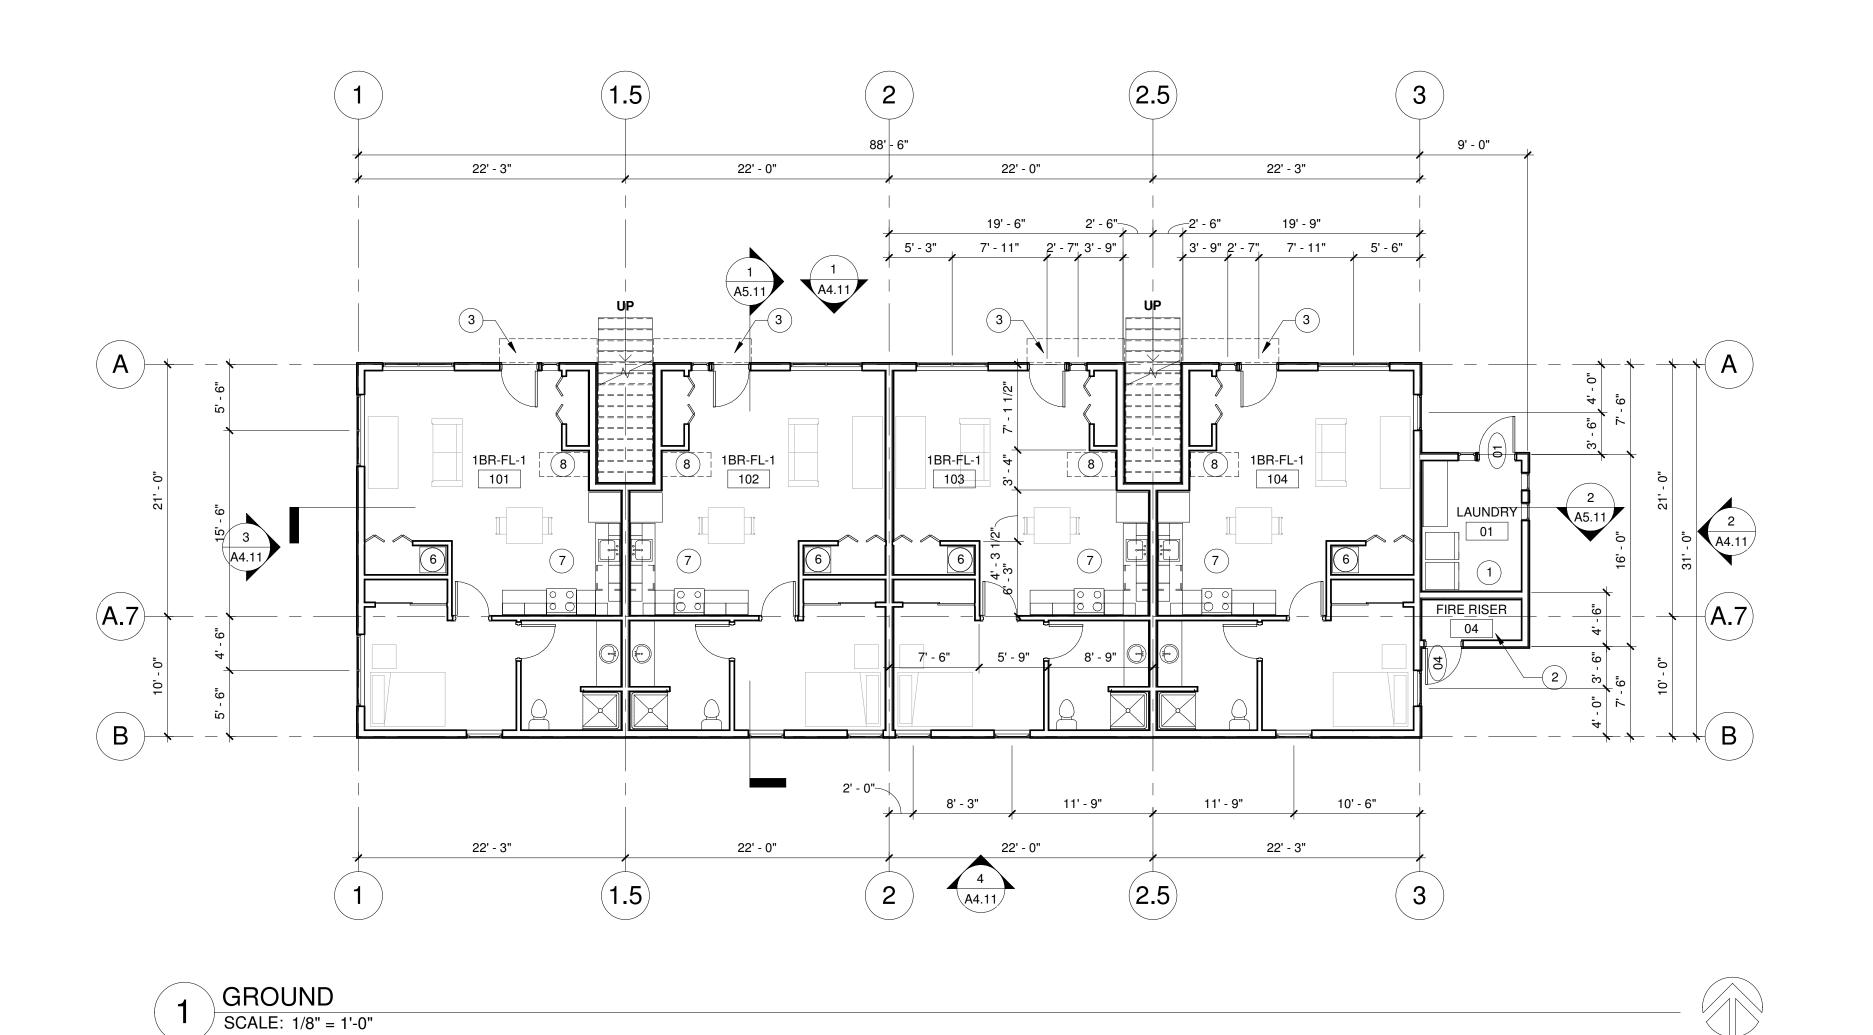

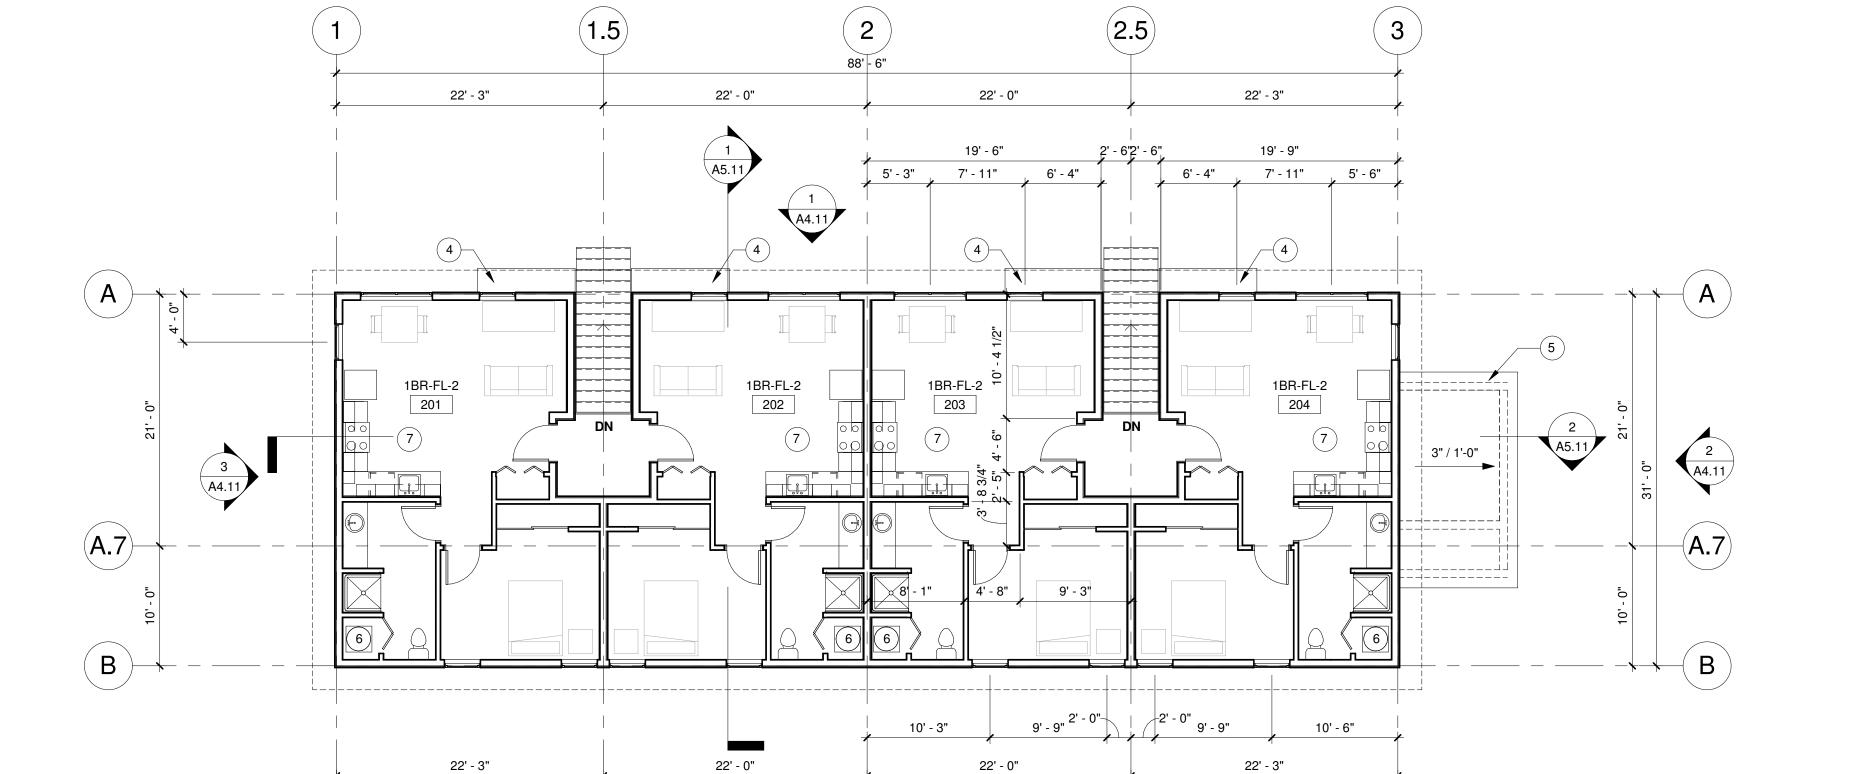

2.5

1.5

SECOND SCALE: 1/8" = 1'-0"

SHEET GENERAL NOTES

- DIMENSIONS ARE TO GRID, FACE OF STUD, CONCRETE, CMU, AND CENTERLINE OF PARTY WALLS, COLUMNS, DOORS, AND WINDOWS, U.N.O.
- SEE UNIT PLANS FOR ADDITIONAL WALL TYPE AND DIMENSION INFORMATION.
- SEE ELEVATION SHEETS FOR SIDING PATTERNS AND MATERIALS.
- MECHANICAL, ELECTRICAL, AND PLUMBING SUBCONTRACTORS TO COMPLY W/ FIRE BLOCKING AND FIRE STOPPING REQUIREMENTS AT ALL PENETRATIONS OR RATED WALL AND FLOOR/CEILING ASSEMBLIES.
- SEE CODE PLANS FOR LOCATION OF FIRE RATED WALLS.
- NOT ALL KEYNOTES OR LEGEND SYMBOLS USED ON EVERY

KEYNOTES

- SHARED LAUNDRY ROOM
- FIRE RISER ROOM
- LINE OF CANOPY ABOVE STEEL CANOPY BELOW
- LINE OF WALL BELOW
- WATER HEATER
- OWNER PROVIDED REFRIGERATOR, STOVE, AND DISHWASHER

BIKE STORAGE

LEGEND

KEYNOTE

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OC-III

BUILDING 1

REVISION NO

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ISSUANCE SCHEMATIC DESIGN

DATE 10/14/2020

SCALE As indicated


PROJECT NUMBER 202010.00

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DRAWING TITLE

BUILDING 1 GROUND/SECOND FLOOR PLANS

SHEET NUMBER

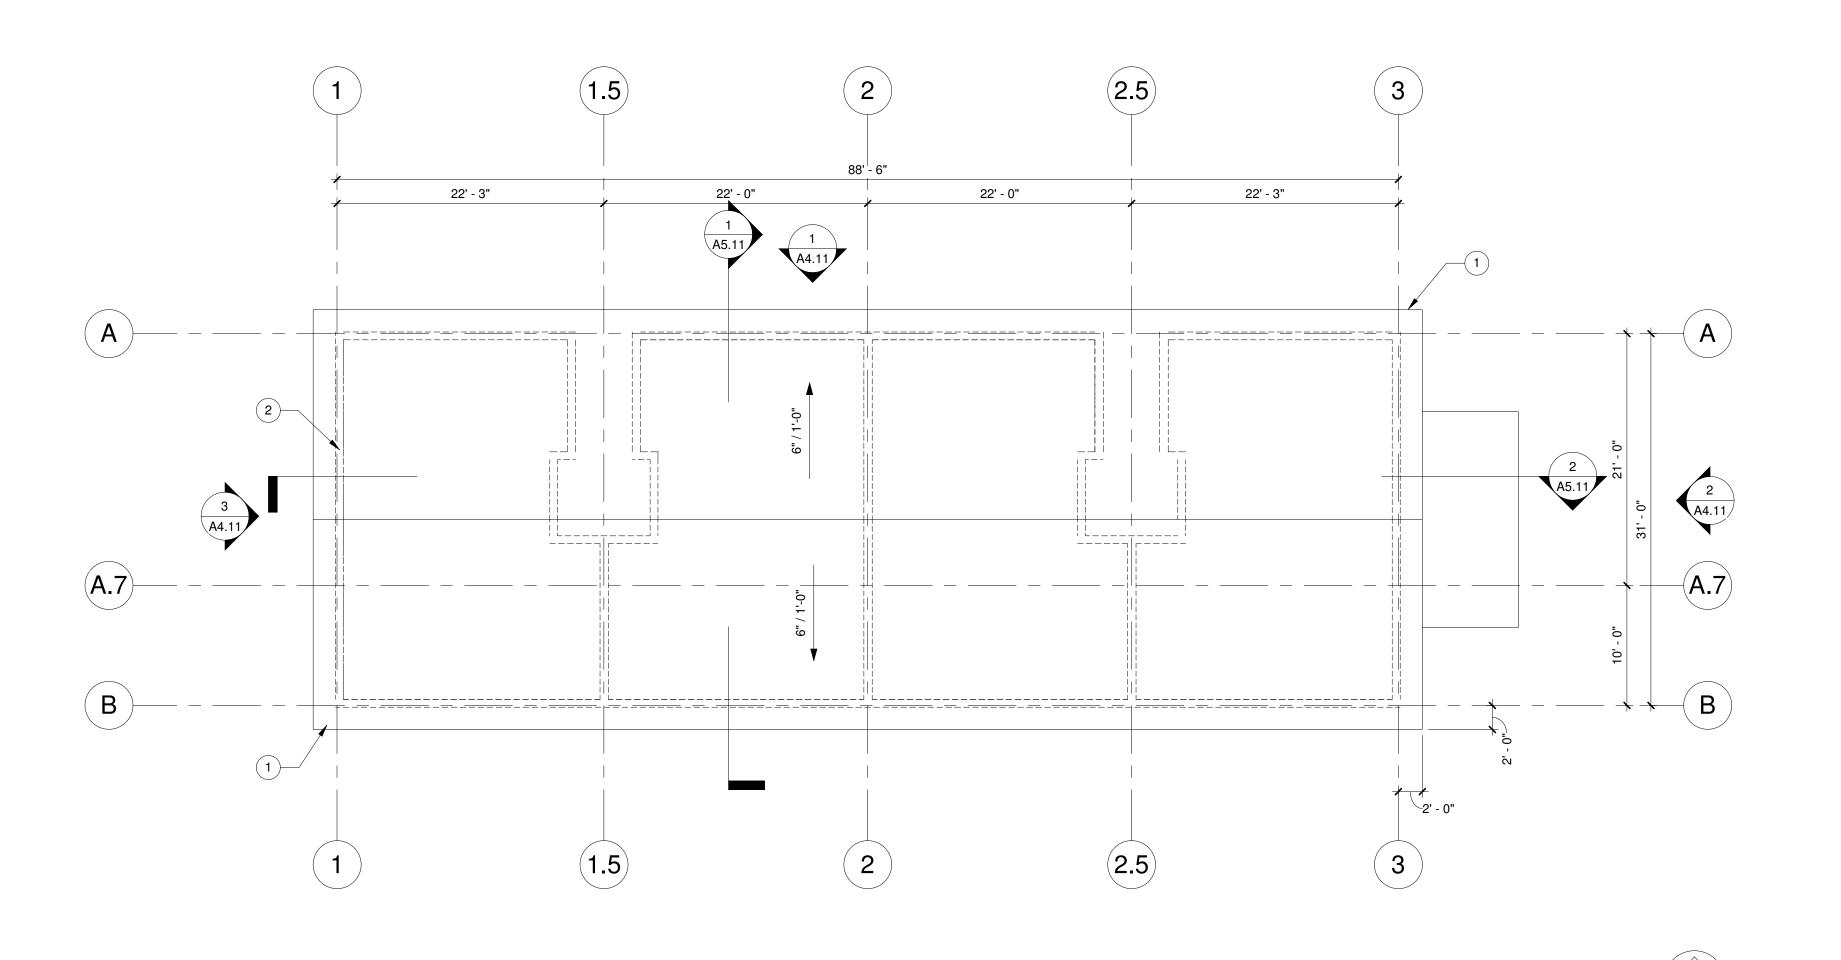

SCALE: 1/8" = 1'-0"

SHEET GENERAL NOTES

- 1. DIMENSIONS ARE TO GRID, FACE OF STUD, CONCRETE, CMU, AND CENTERLINE OF PARTY WALLS, COLUMNS, DOORS, AND WINDOWS, U.N.O.
- 2. SEE UNIT PLANS FOR ADDITIONAL WALL TYPE AND DIMENSION INFORMATION
- 3. SEE ELEVATION SHEETS FOR SIDING PATTERNS AND MATERIALS.
- 4. MECHANICAL, ELECTRICAL, AND PLUMBING SUBCONTRACTORS TO COMPLY W/ FIRE BLOCKING AND FIRE STOPPING REQUIREMENTS AT ALL PENETRATIONS OR RATED WALL AND FLOOR/CEILING ASSEMBLIES.
- 5. SEE CODE PLANS FOR LOCATION OF FIRE RATED WALLS.
- 6. NOT ALL KEYNOTES OR LEGEND SYMBOLS ARE USED ON EVERY SHEET.

KEYNOTES

1 GUTTER AND DOWNSPOUT 2 LINE OF WALL BELOW

LEGEND

KEYNOTE

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ISSUANCE SCHEMATIC DESIGN DATE 10/14/2020

SCALE As indicated

PROJECT NUMBER 202010.00


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DRAWING TITLE

BUILDING 1 ROOF PLAN


SHEET NUMBER

A2.12

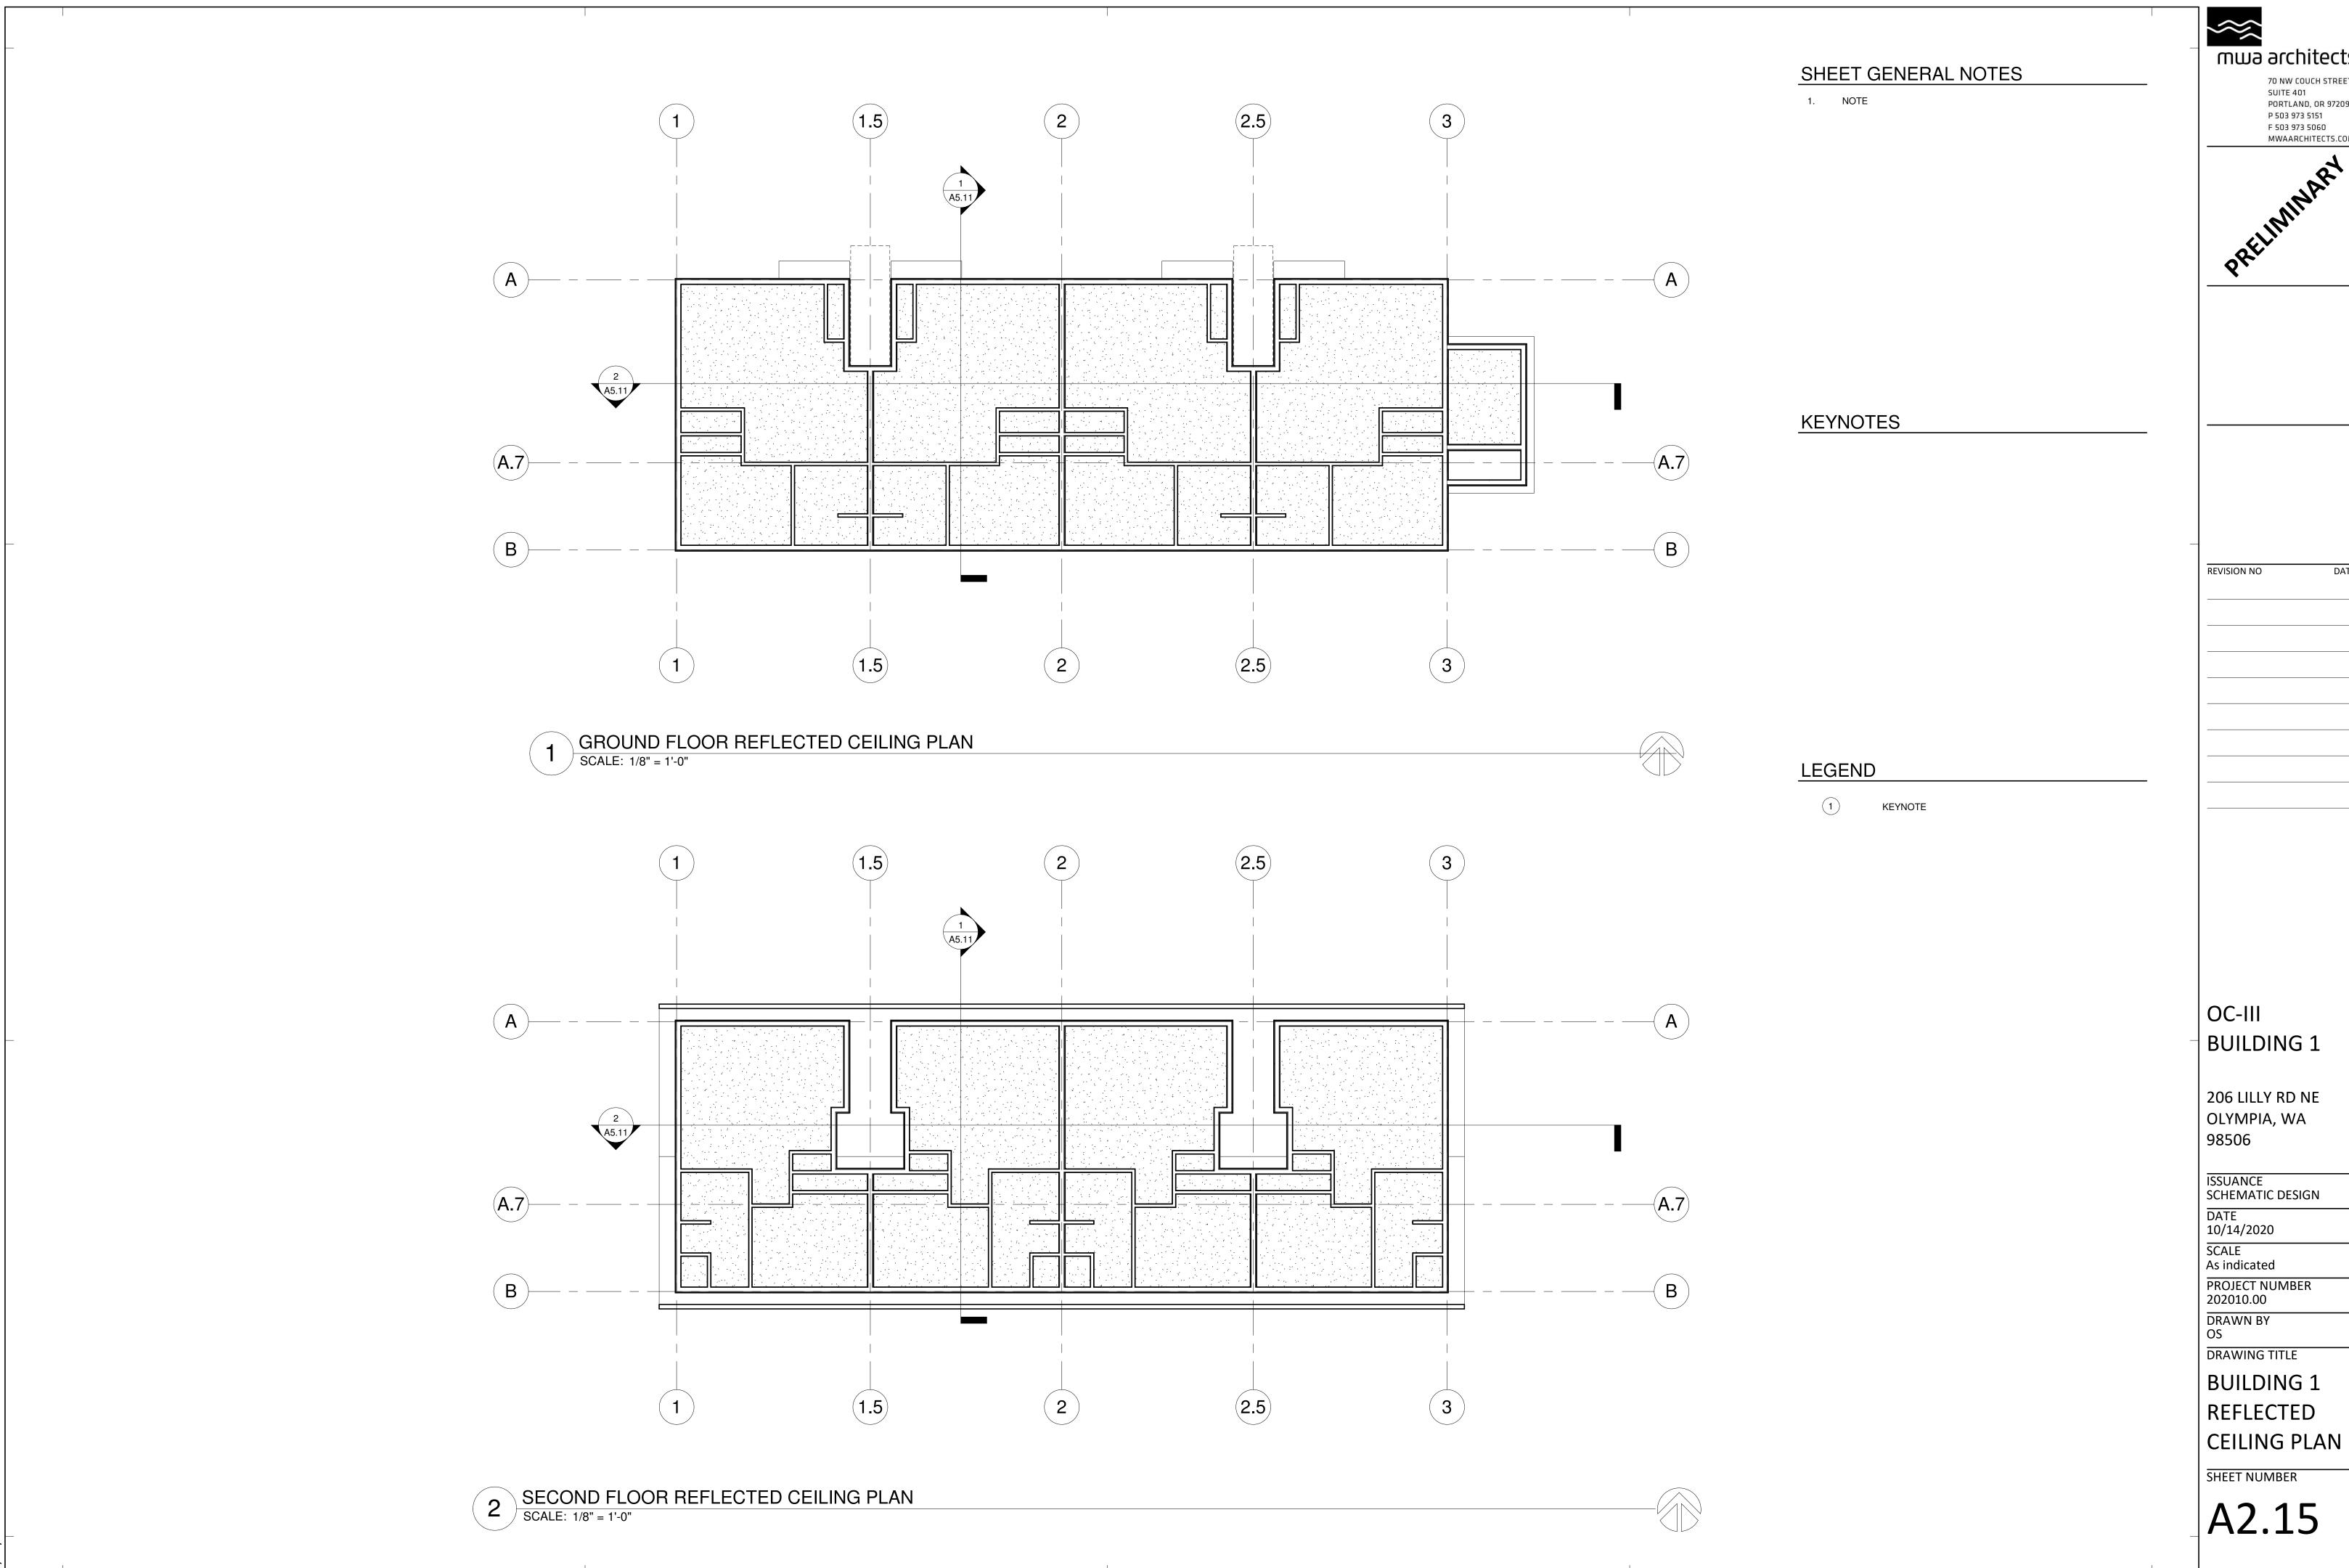

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- DIMENSIONS ARE TO GRID, FACE OF STUD, CONCRETE, CMU, AND CENTERLINE OF PARTY WALLS, COLUMNS, DOORS, AND WINDOWS, U.N.O.
- 2. SEE UNIT PLANS FOR ADDITIONAL WALL TYPE AND DIMENSION INFORMATION.
- 3. SEE ELEVATION SHEETS FOR SIDING PATTERNS AND MATERIALS.
- 4. MECHANICAL, ELECTRICAL, AND PLUMBING SUBCONTRACTORS TO COMPLY W/ FIRE BLOCKING AND FIRE STOPPING REQUIREMENTS AT ALL PENETRATIONS OR RATED WALL AND FLOOR/CEILING ASSEMBLIES.
- 5. SEE CODE PLANS FOR LOCATION OF FIRE RATED WALLS.
- 6. NOT ALL KEYNOTES OR LEGEND SYMBOLS USED ON EVERY SHEET

KEYNOTES

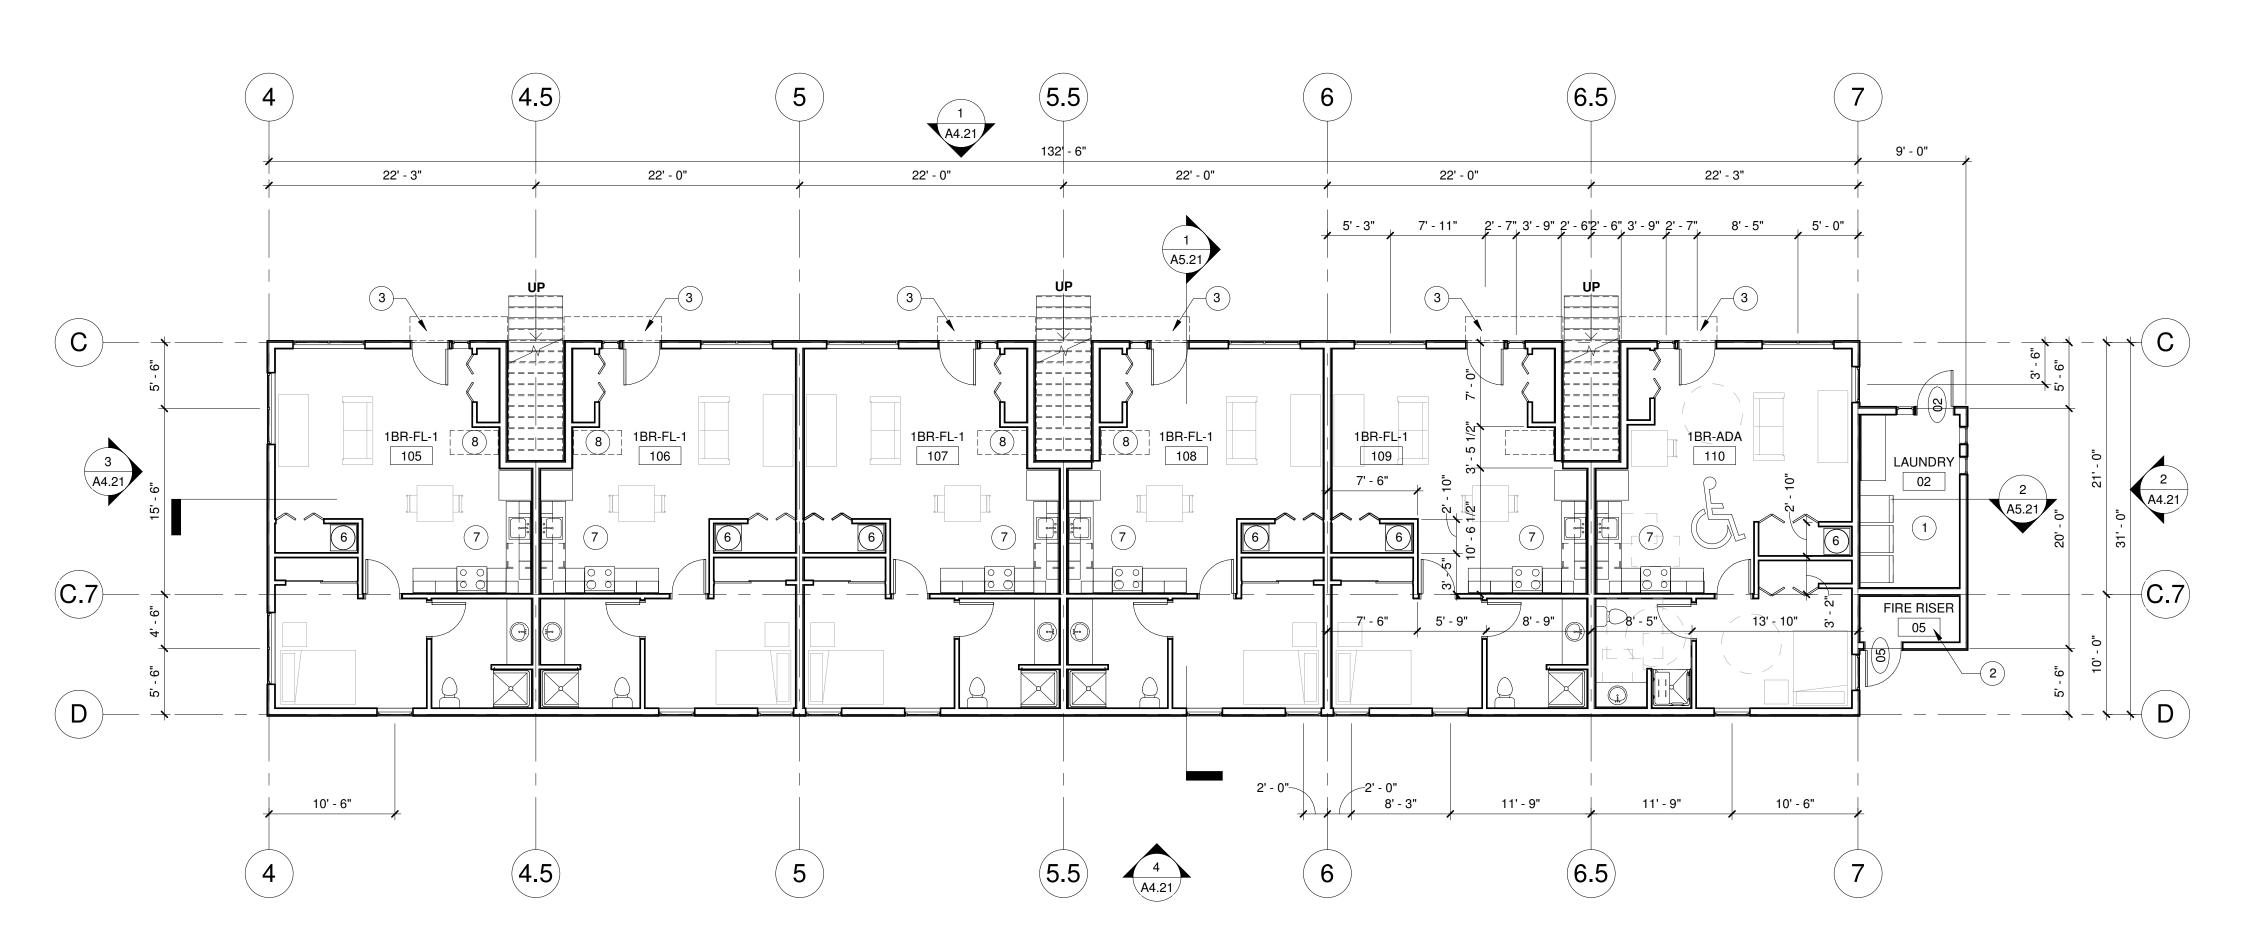- 1 SHARED LAUNDRY ROOM
- FIRE RISER ROOM
 LINE OF CANOPY ABOVE
- STEEL CANOPY BELOW LINE OF WALL BELOW
- WATER HEATER
- OWNER PROVIDED REFRIGERATOR, STOVE, AND DISHWASHER
- BIKE STORAGE

REVISION NO

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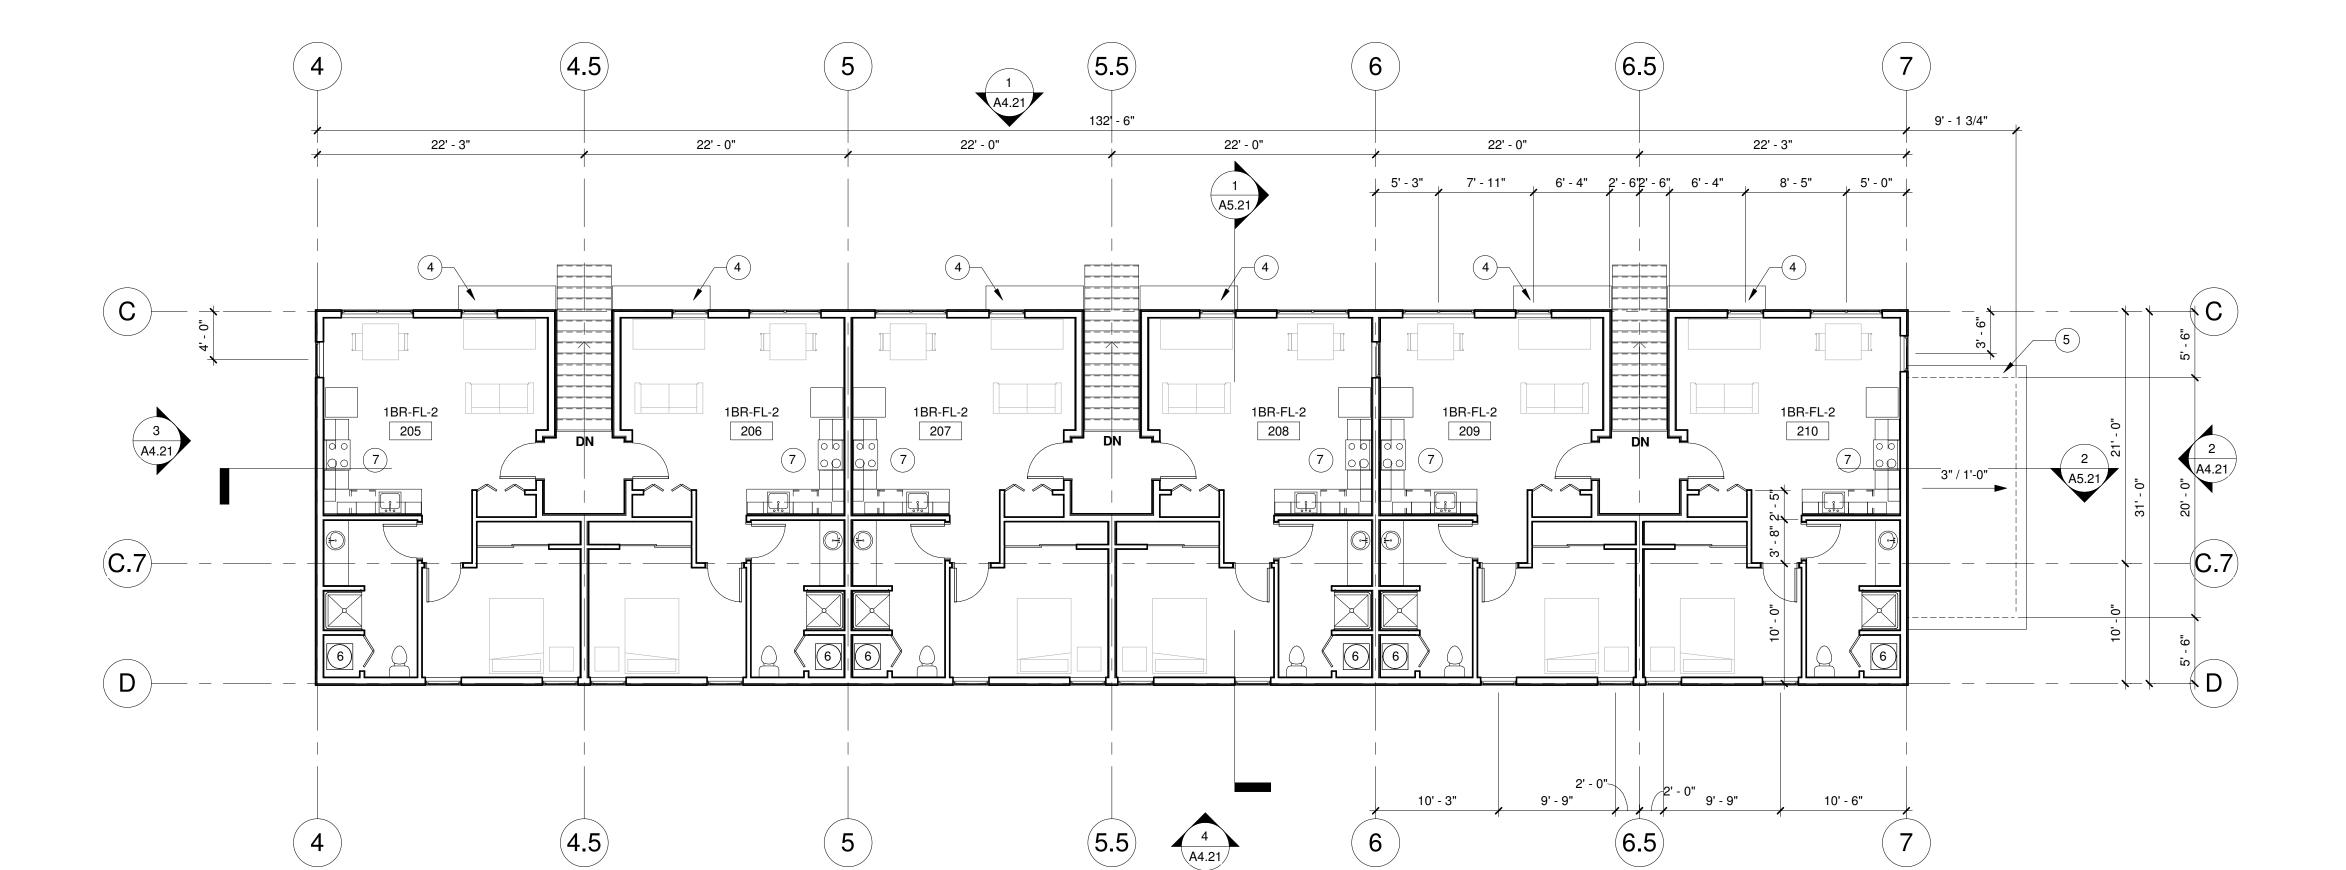
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LEGEND

1 KEYNOTE



OC-III BUILDING 2

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ISSUANCE SCHEMATIC DESIGN

DATE 10/12/2020

SCALE As indicated

PROJECT NUMBER

202010.00 DRAWN BY

OS BY

DRAWING TITLE

BUILDING 2
GROUND/SECOND
FLOOR PLANS

SHEET NUMBER

A2.21

-/ 2020 3:20:14 FIVI

GROUND

2 SECOND SCALE: 1/8" = 1'-0"

SCALE: 1/8" = 1'-0"

22' - 3" 22' - 0" 22' - 0" 22' - 0" 22' - 0" 22' - 3" 2 3 A4.21 D 1 4.5 6.5 6 4

1 ROOF
SCALE: 1/8" = 1'-0"

SHEET GENERAL NOTES

- DIMENSIONS ARE TO GRID, FACE OF STUD, CONCRETE, CMU, AND CENTERLINE OF PARTY WALLS, COLUMNS, DOORS, AND WINDOWS, U.N.O.
- 2. SEE UNIT PLANS FOR ADDITIONAL WALL TYPE AND DIMENSION
- SEE ELEVATION SHEETS FOR SIDING PATTERNS AND MATERIALS.
- 4. MECHANICAL, ELECTRICAL, AND PLUMBING SUBCONTRACTORS TO COMPLY W/ FIRE BLOCKING AND FIRE STOPPING REQUIREMENTS AT ALL PENETRATIONS OR RATED WALL AND FLOOR/CEILING ASSEMBLIES.
- 5. SEE CODE PLANS FOR LOCATION OF FIRE RATED WALLS.
- 6. NOT ALL KEYNOTES OR LEGEND SYMBOLS ARE USED ON EVERY SHEET.

KEYNOTES

1 GUTTER AND DOWNSPOUT

2 LINE OF WALL BELOW

LEGEND

1 KEYNOTE

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DATE 10/12/2020 SCALE As indicated

As indicated
PROJECT NUMBER
202010.00


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DRAWING TITLE

BUILDING 2 ROOF PLAN


SHEET NUMBER

A2.22

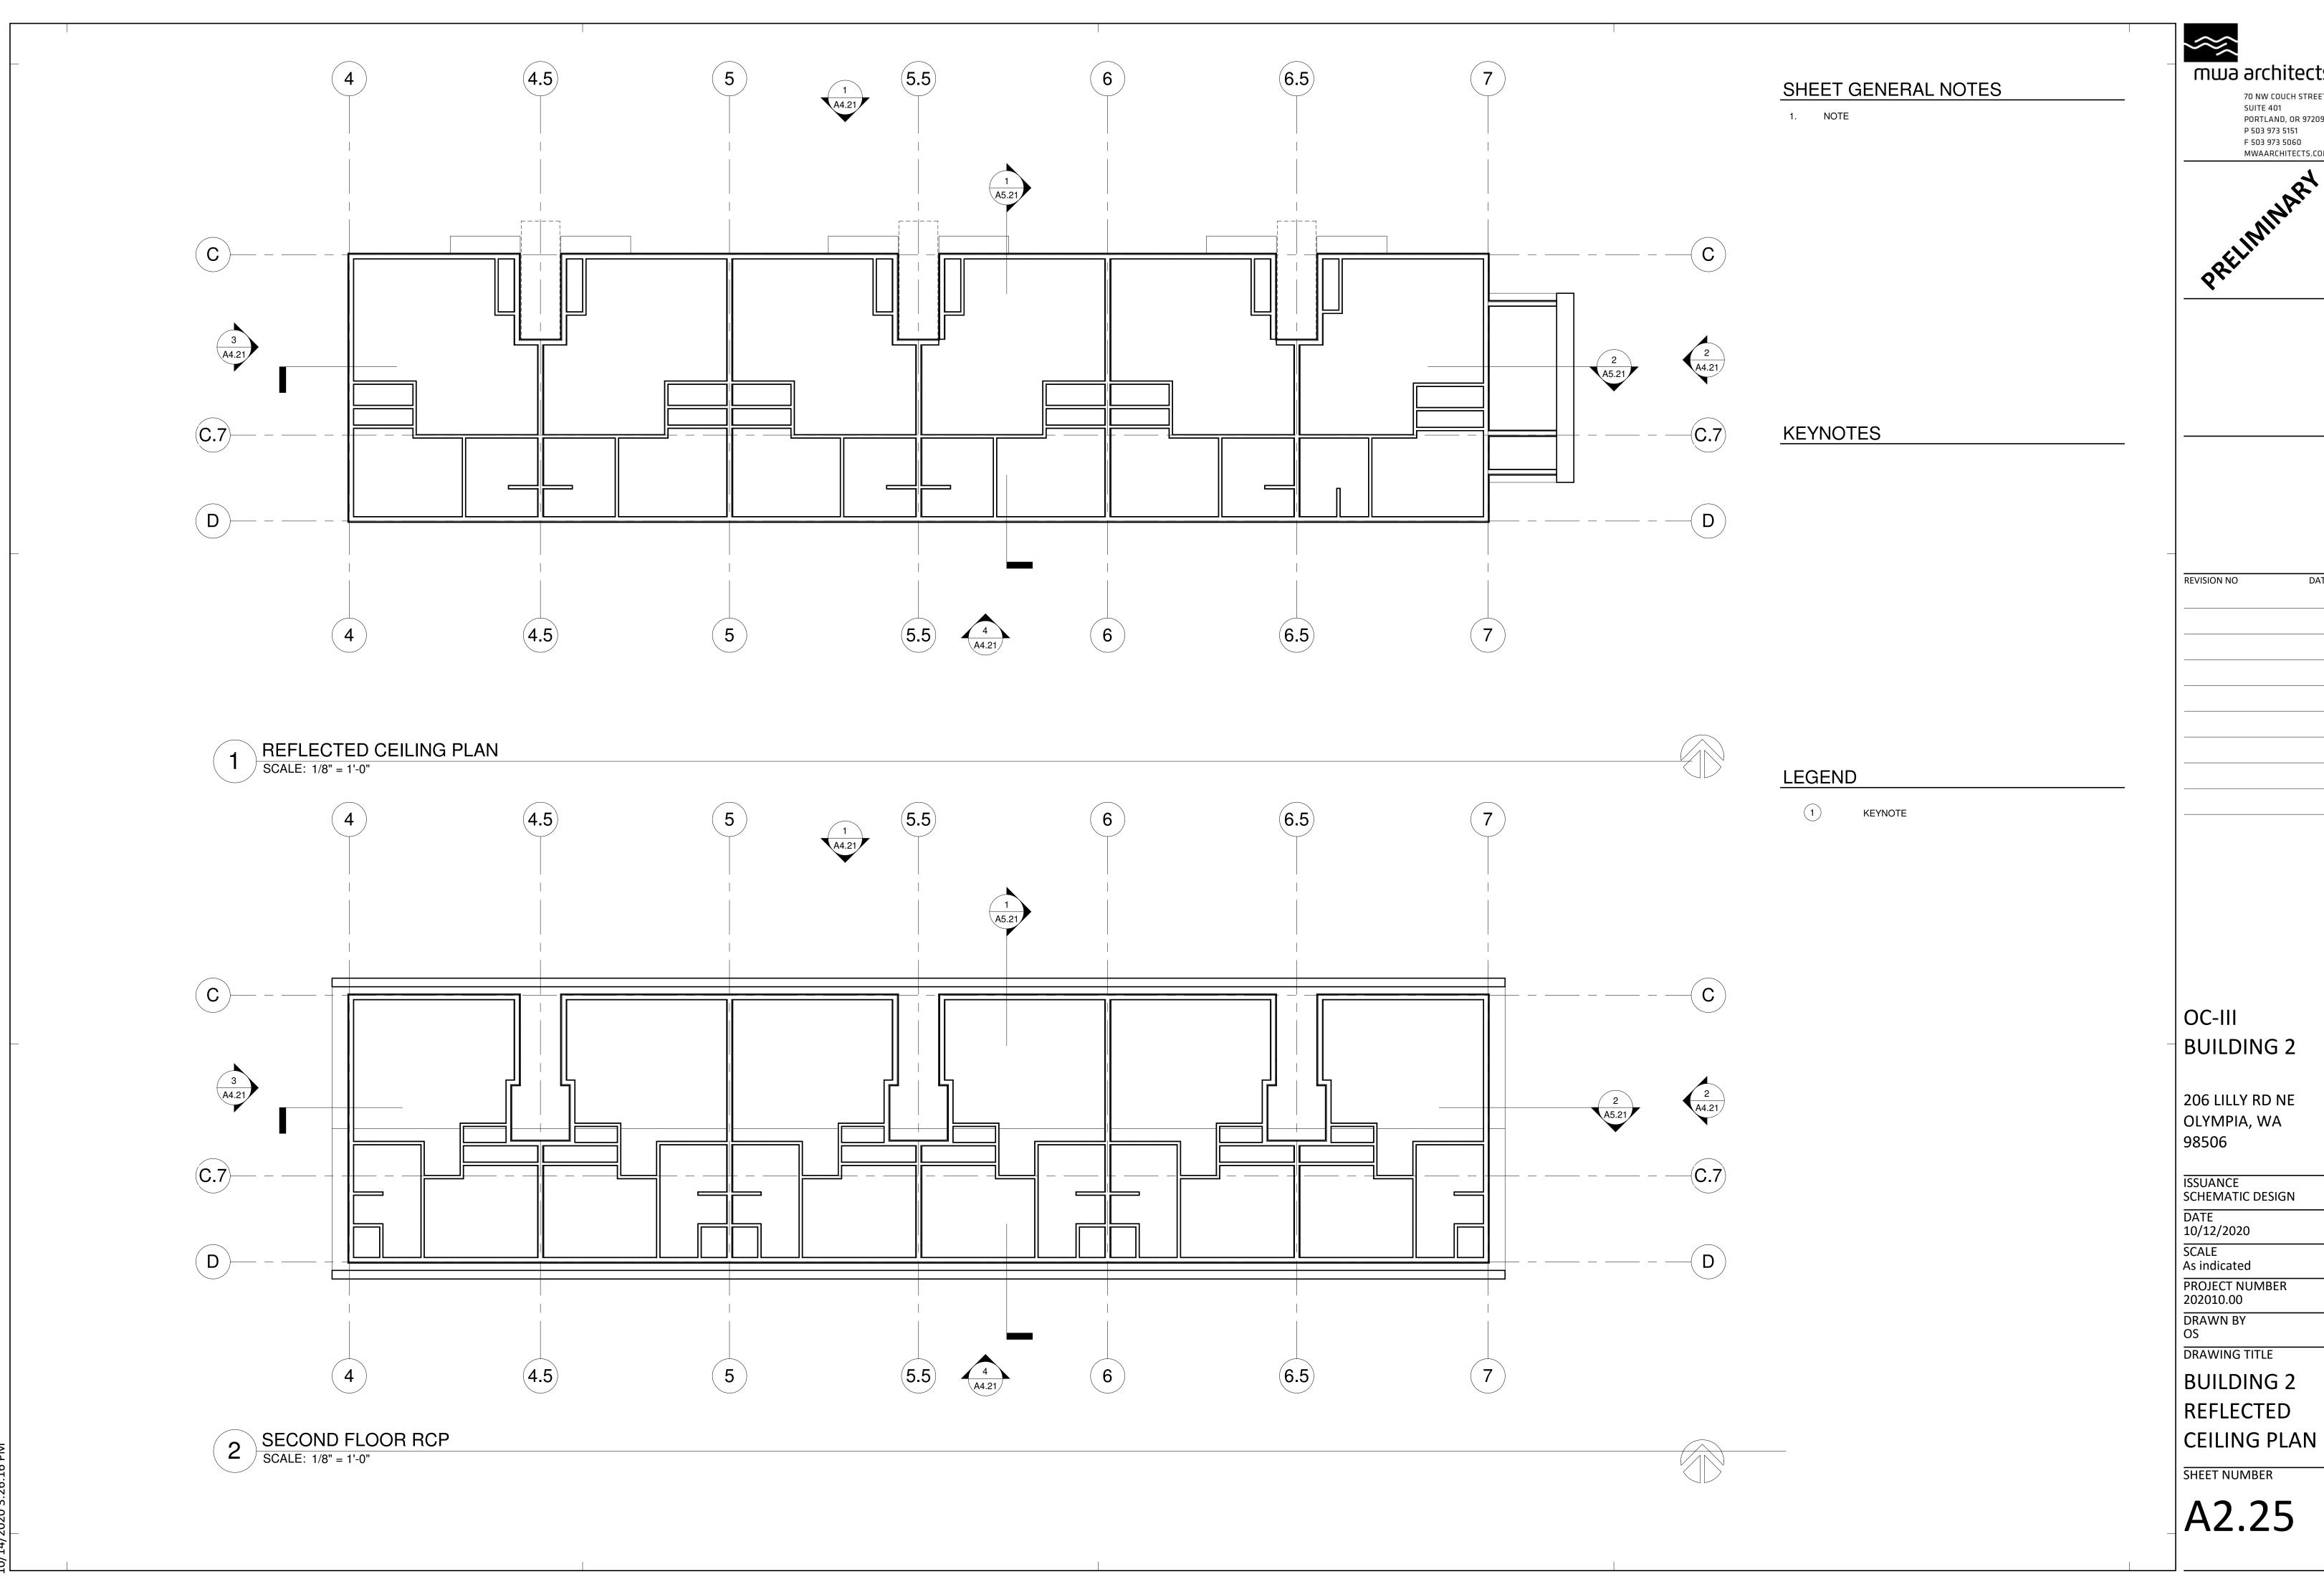

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206 LILLY RD NE

ISSUANCE SCHEMATIC DESIGN
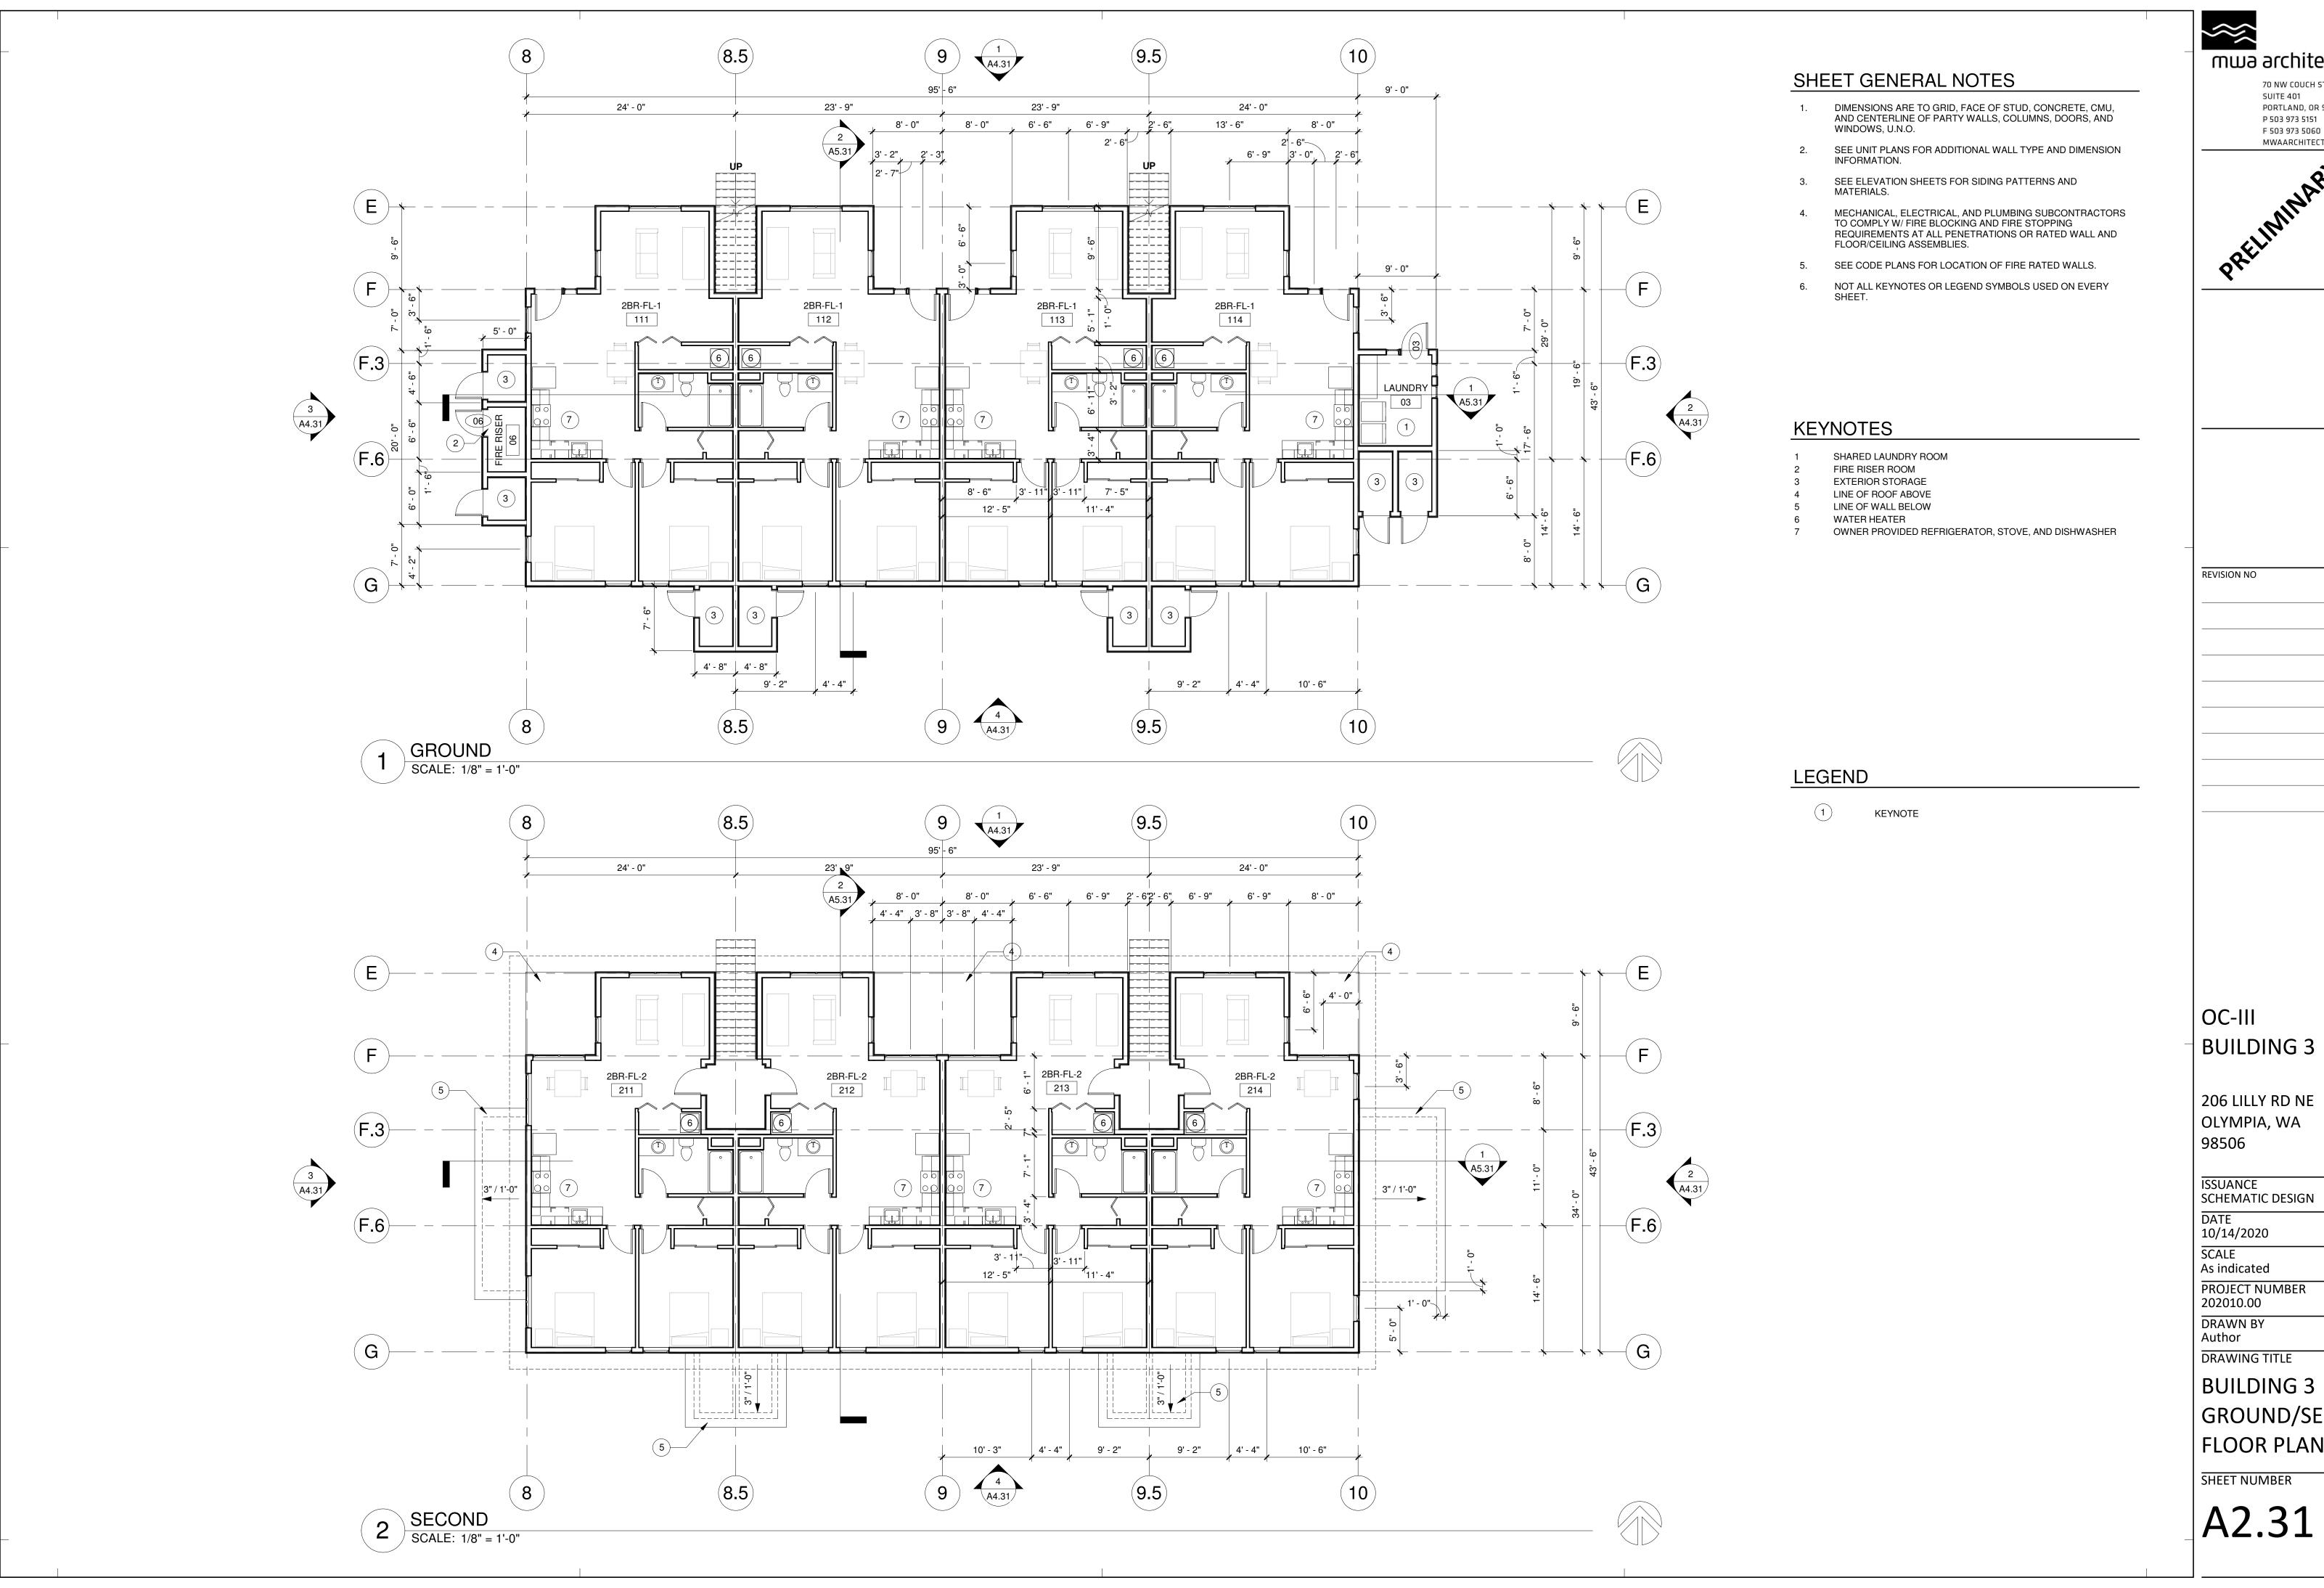
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As indicated


PROJECT NUMBER 202010.00 DRAWN BY

DRAWING TITLE

BUILDING 3 GROUND/SECOND FLOOR PLANS

SHEET NUMBER

A2.31

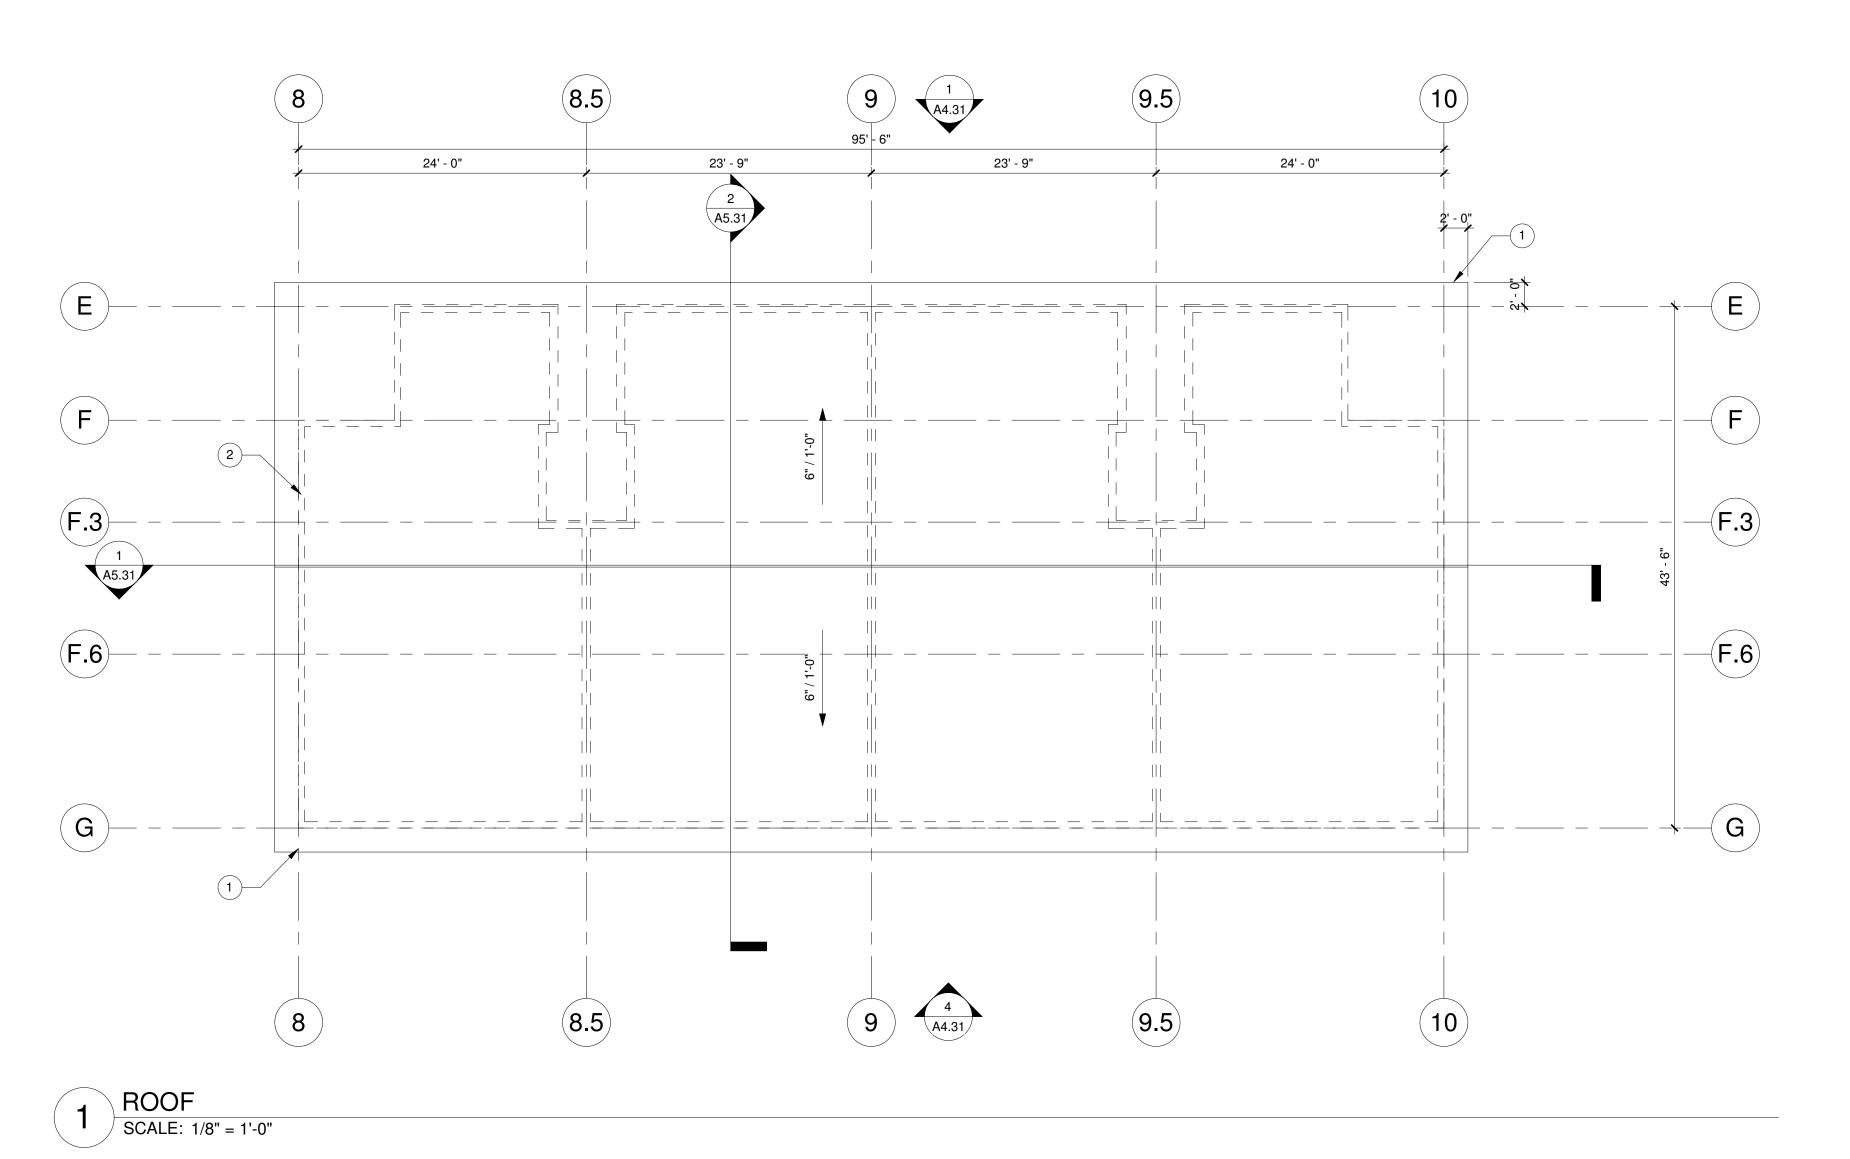

 DIMENSIONS ARE TO GRID, FACE OF STUD, CONCRETE, CMU, AND CENTERLINE OF PARTY WALLS, COLUMNS, DOORS, AND WINDOWS, U.N.O.

2. SEE UNIT PLANS FOR ADDITIONAL WALL TYPE AND DIMENSION

SEE ELEVATION SHEETS FOR SIDING PATTERNS AND MATERIALS.

4. MECHANICAL, ELECTRICAL, AND PLUMBING SUBCONTRACTORS TO COMPLY W/ FIRE BLOCKING AND FIRE STOPPING REQUIREMENTS AT ALL PENETRATIONS OR RATED WALL AND FLOOR/CEILING ASSEMBLIES.

5. SEE CODE PLANS FOR LOCATION OF FIRE RATED WALLS.

6. NOT ALL KEYNOTES OR LEGEND SYMBOLS USED ON EVERY SHEFT

KEYNOTES

1 GUTTER AND DOWNSPOUT 2 LINE OF WALL BELOW

LEGEND

1 KEYNOTE

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OC-III BUILDING 3

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ISSUANCE SCHEMATIC DESIGN

DATE 10/14/2020 SCALE As indicated

As indicated
PROJECT NUMBER
202010.00


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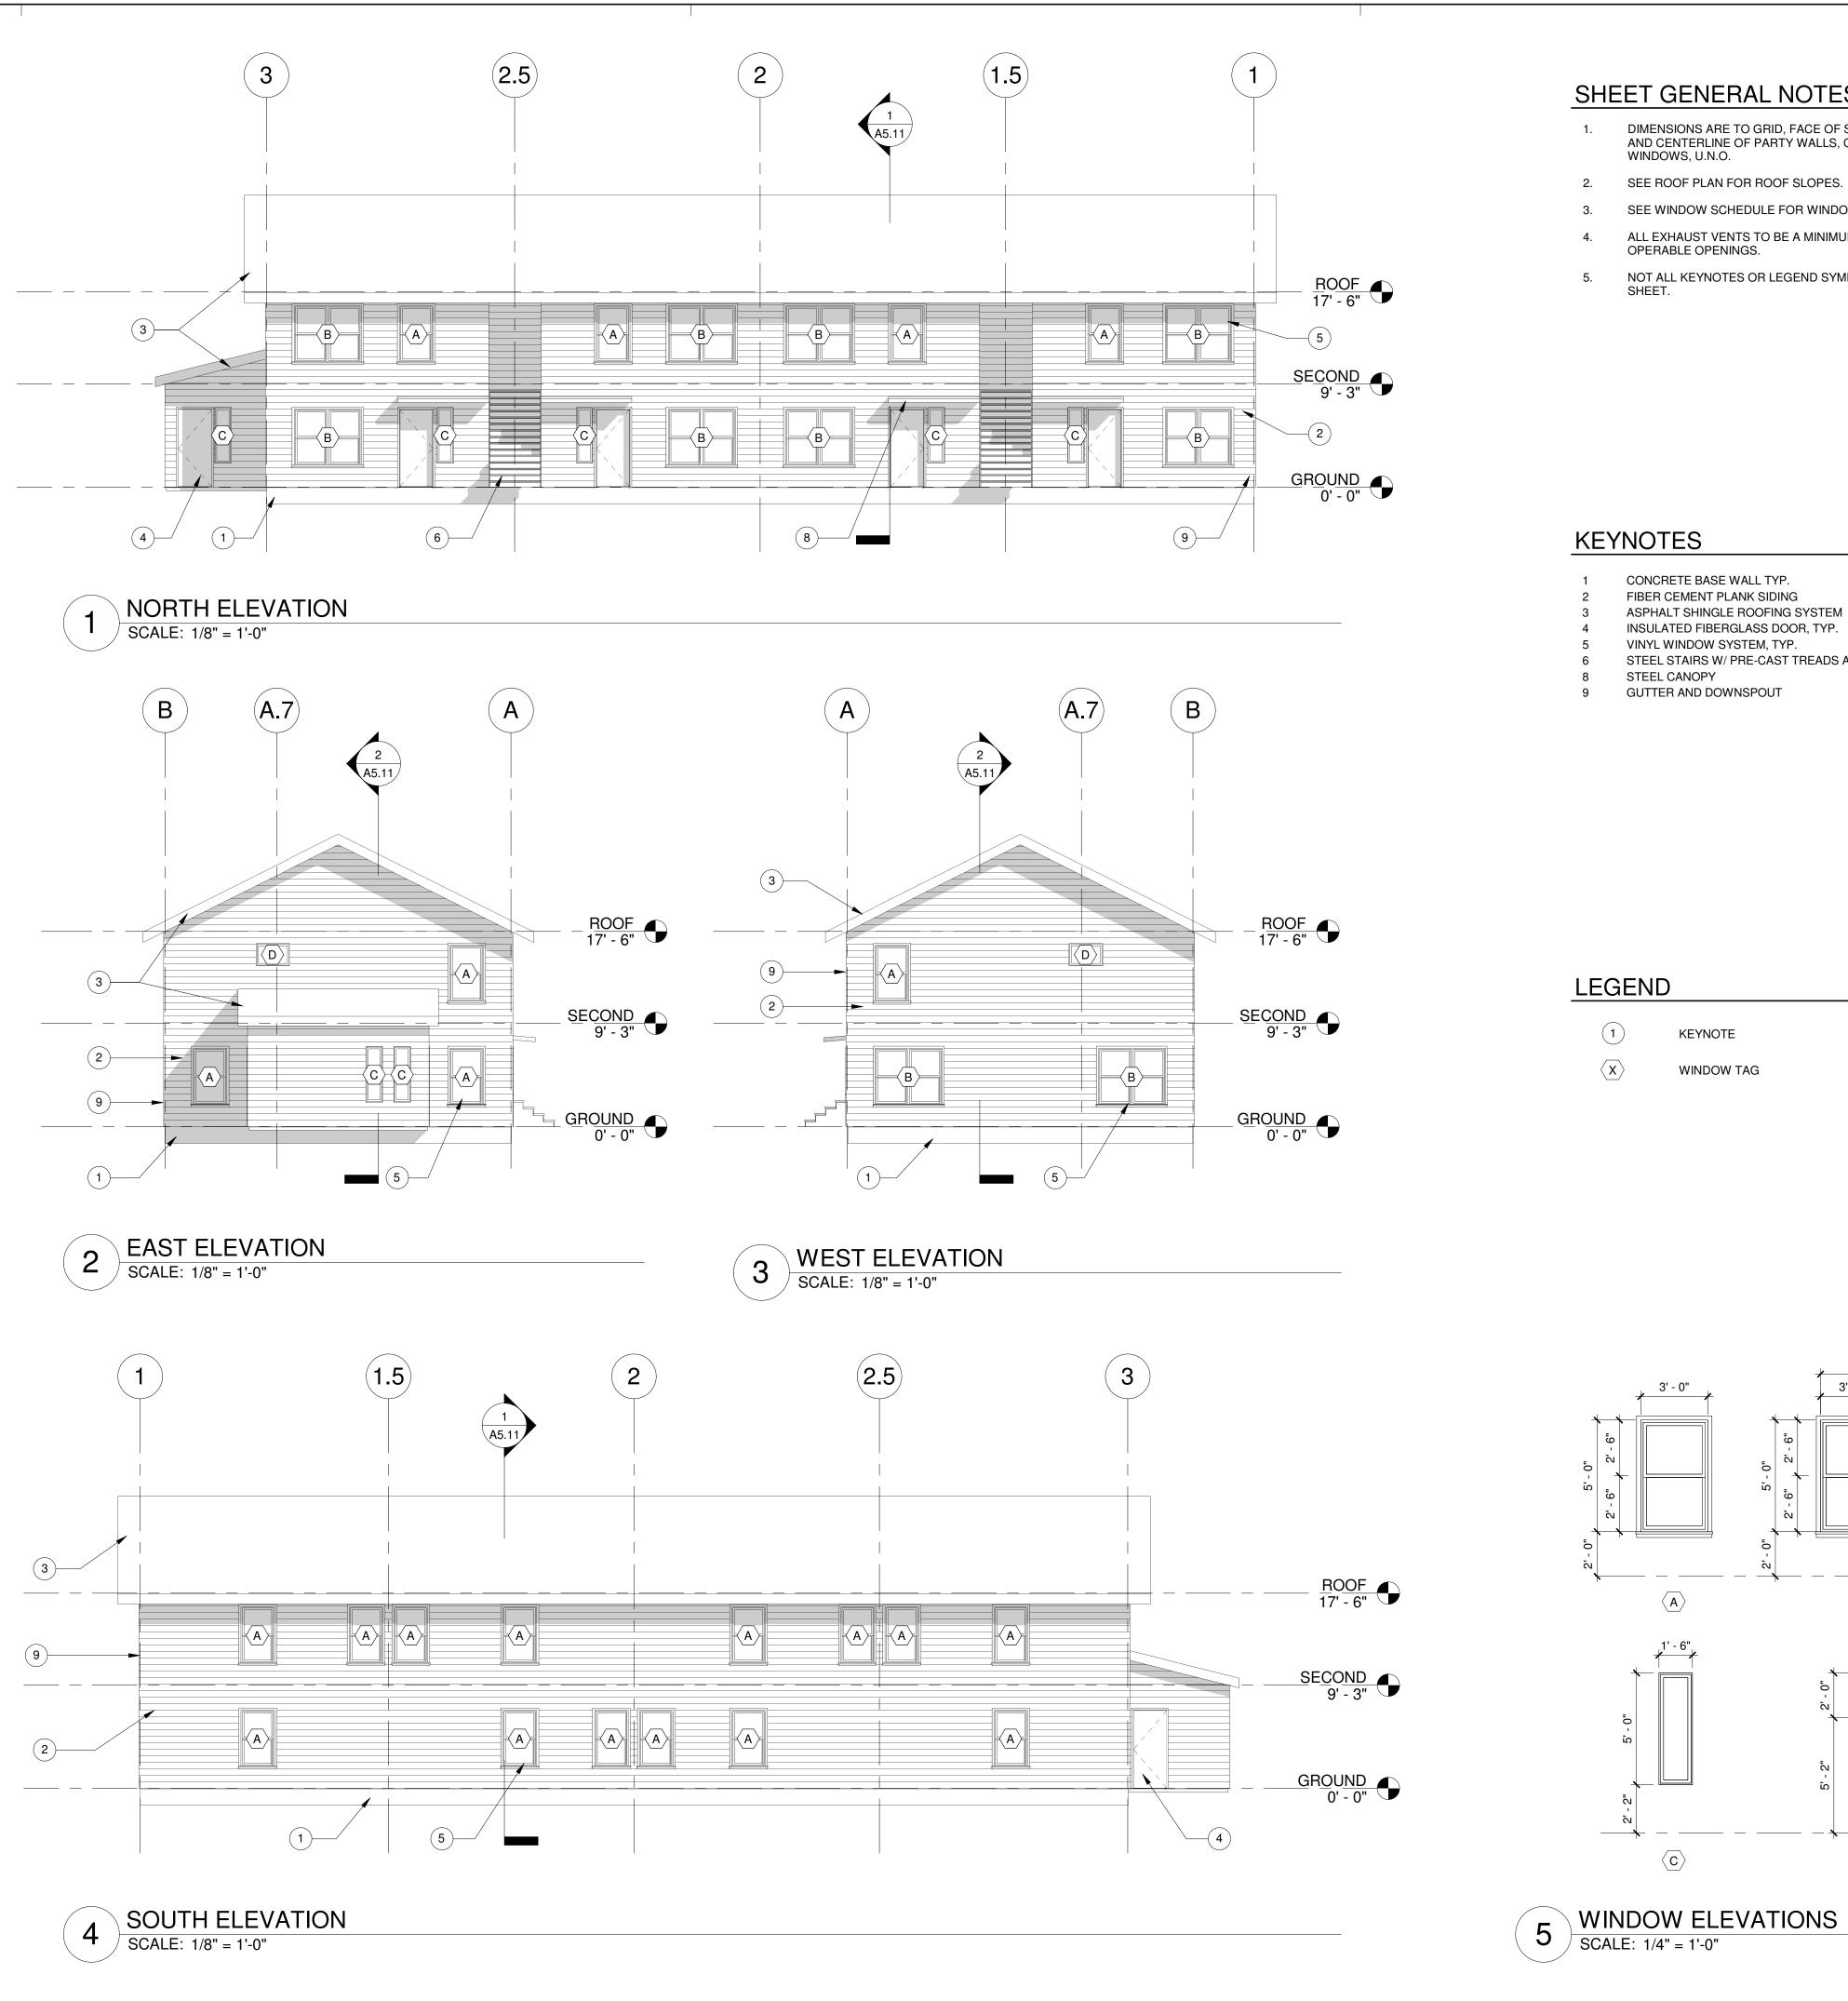
DRAWING TITLE

BUILDING 3 ROOF PLAN

SHEET NUMBER

A2.32



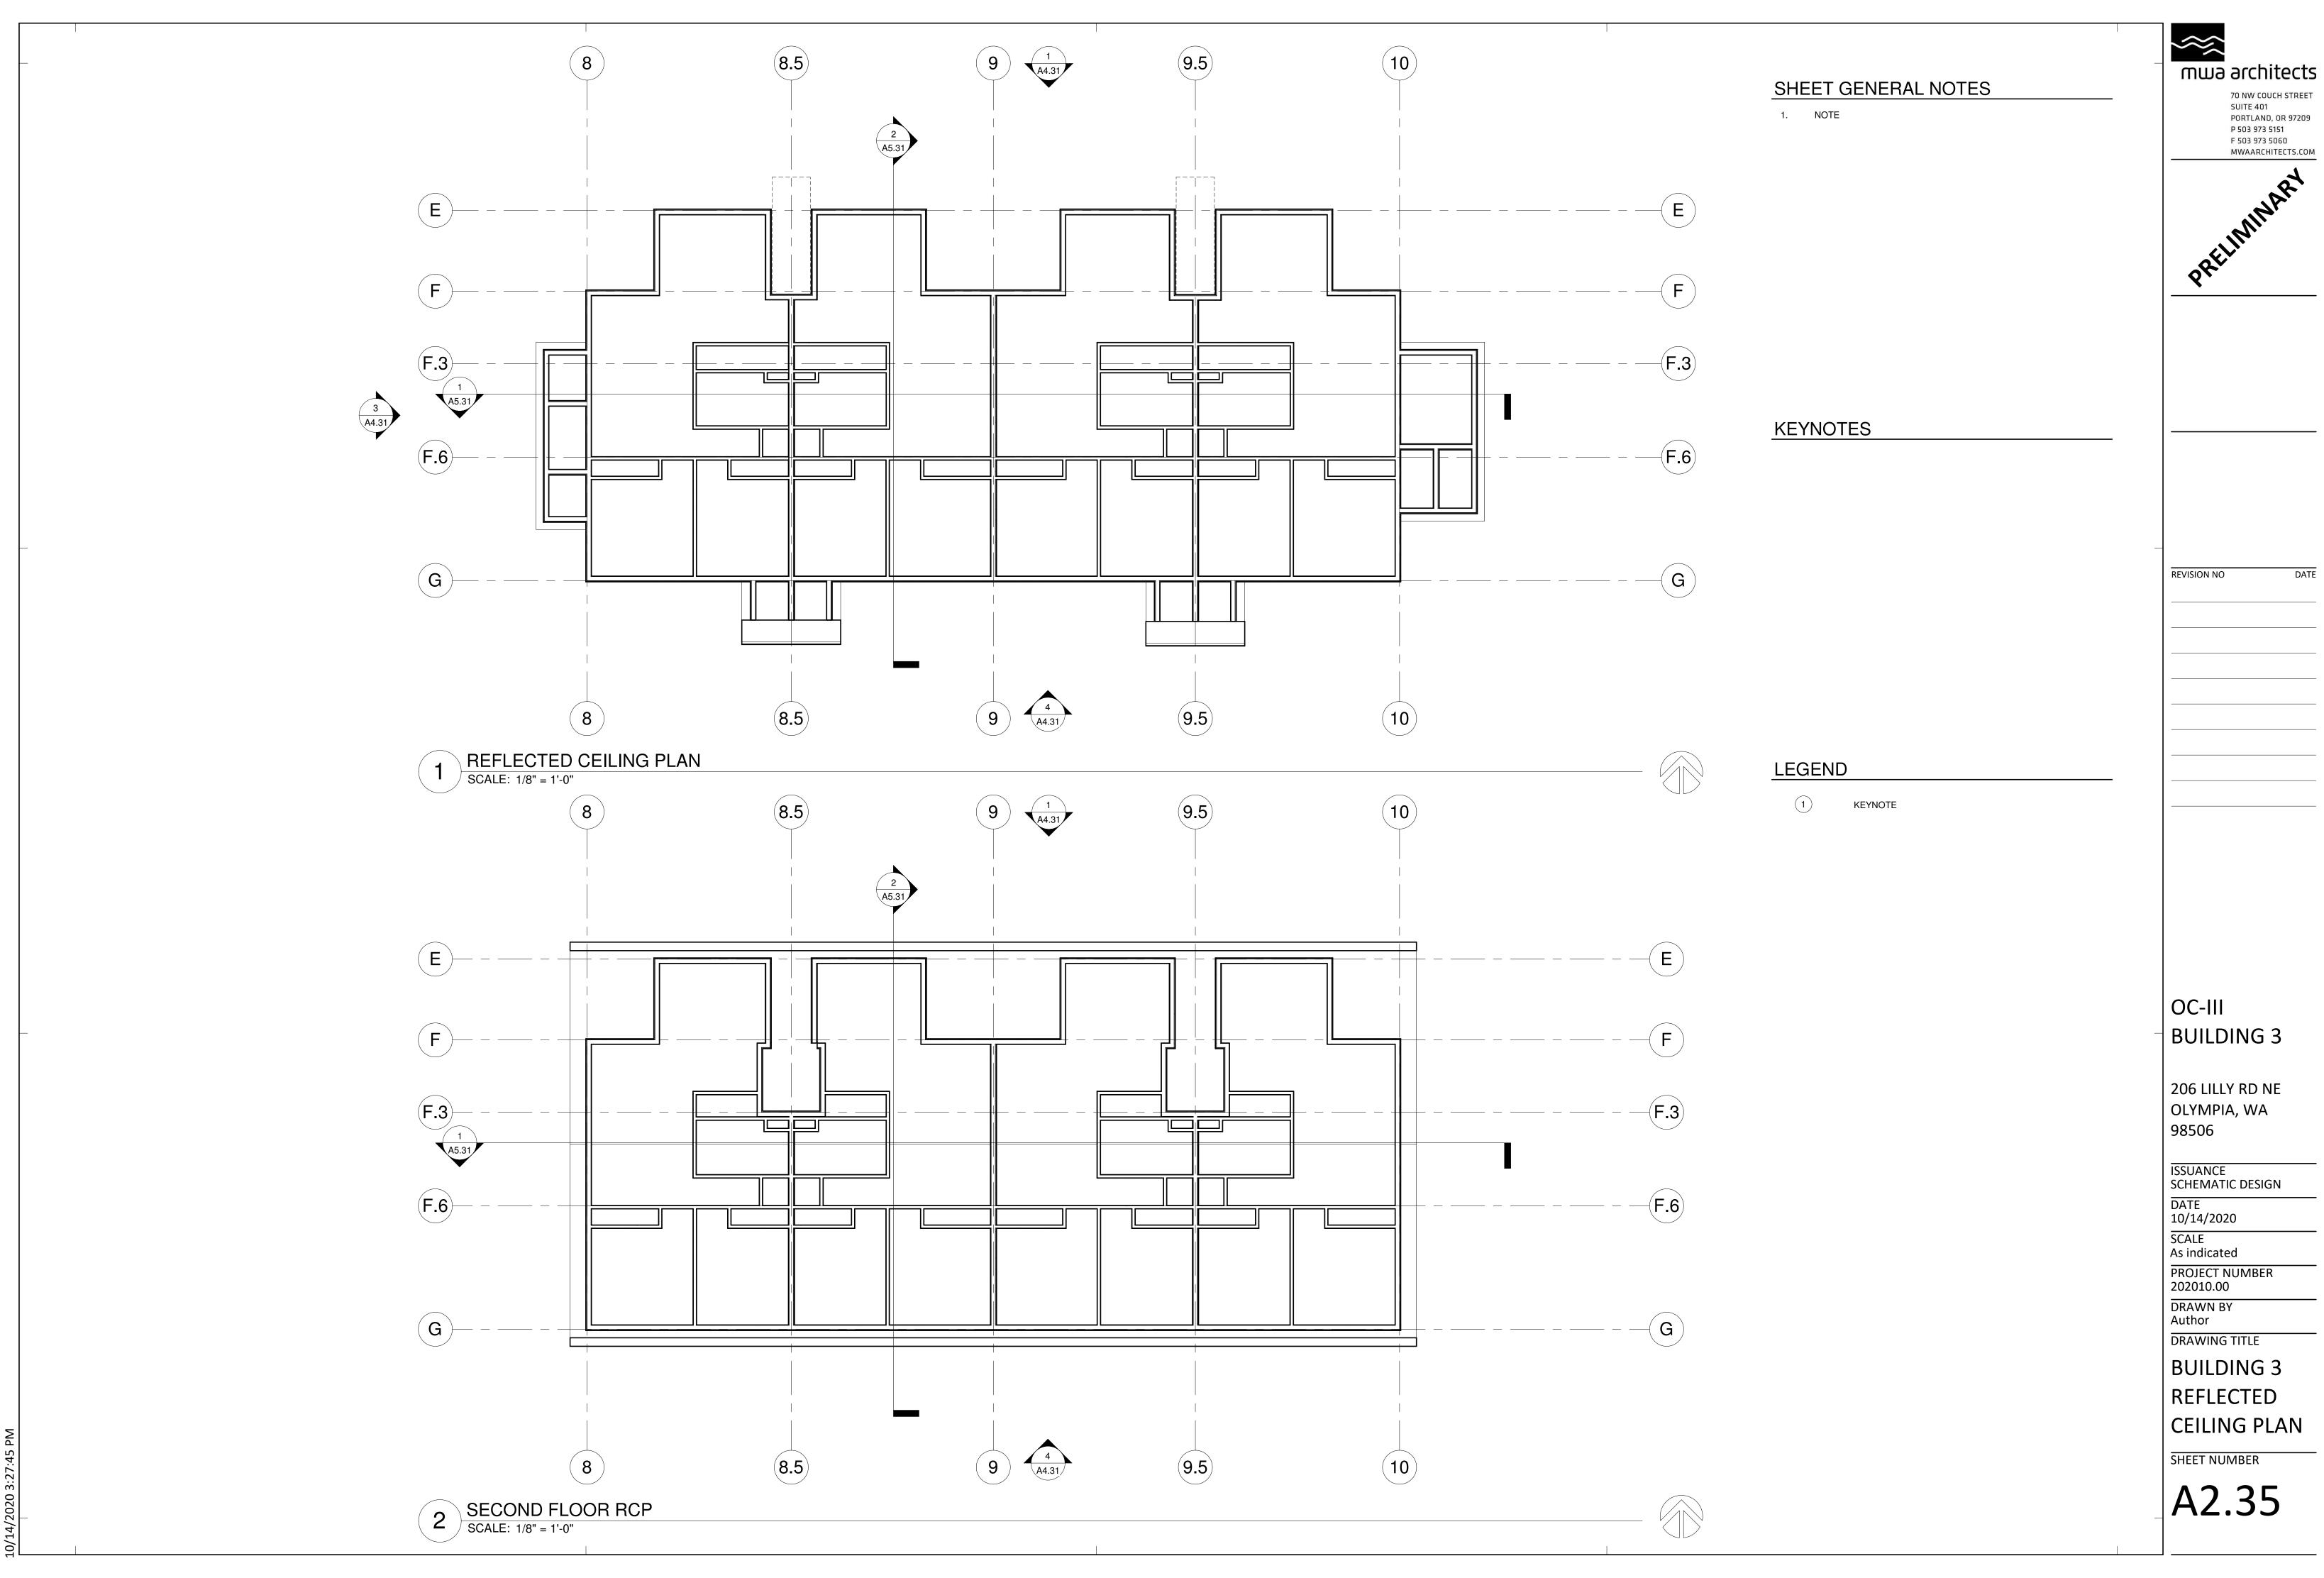

DIMENSIONS ARE TO GRID, FACE OF STUD, CONCRETE, CMU, AND CENTERLINE OF PARTY WALLS, COLUMNS, DOORS, AND WINDOWS, U.N.O.

2. SEE ROOF PLAN FOR ROOF SLOPES.

SEE WINDOW SCHEDULE FOR WINDOW TYPES.

ALL EXHAUST VENTS TO BE A MINIMUM OF 3'-0" AWAY FROM OPERABLE OPENINGS.

NOT ALL KEYNOTES OR LEGEND SYMBOLS USED ON EVERY

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KEYNOTES

CONCRETE BASE WALL TYP.

FIBER CEMENT PLANK SIDING

ASPHALT SHINGLE ROOFING SYSTEM INSULATED FIBERGLASS DOOR, TYP.

VINYL WINDOW SYSTEM, TYP.

STEEL STAIRS W/ PRE-CAST TREADS AND METAL RAILINGS STEEL CANOPY

GUTTER AND DOWNSPOUT

KEYNOTE

WINDOW TAG

 $\langle c \rangle$

BUILDING 1 3'-0" 3'-0" 206 LILLY RD NE OLYMPIA, WA 98506

FFE

 $\langle D \rangle$

ISSUANCE SCHEMATIC DESIGN DATE 10/14/2020

OC-III

SCALE As indicated PROJECT NUMBER 202010.00

DRAWN BY DRAWING TITLE

BUILDING 1

ELEVATIONS

SHEET NUMBER

A4.11



DIMENSIONS ARE TO GRID, FACE OF STUD, CONCRETE, CMU, AND CENTERLINE OF PARTY WALLS, COLUMNS, DOORS, AND WINDOWS, U.N.O.

SEE WINDOW SCHEDULE FOR WINDOW TYPES.

ALL EXHAUST VENTS TO BE A MINIMUM OF 3'-0" AWAY FROM

NOT ALL KEYNOTES OR LEGEND SYMBOLS USED ON EVERY

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ASPHALT SHINGLE ROOFING SYSTEM INSULATED FIBERGLASS DOOR, TYP.

STEEL STAIRS W/ PRECAST TREADS AND METAL RAILINGS

OC-III BUILDING 2

REVISION NO

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ISSUANCE SCHEMATIC DESIGN DATE 10/12/2020

SCALE As indicated PROJECT NUMBER

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DRAWING TITLE BUILDING 2

ELEVATIONS

SHEET NUMBER

 $\langle D \rangle$

A4.21



- DIMENSIONS ARE TO GRID, FACE OF STUD, CONCRETE, CMU, AND CENTERLINE OF PARTY WALLS, COLUMNS, DOORS, AND WINDOWS, U.N.O.
- 2. SEE ROOF PLAN FOR ROOF SLOPES.
 - . SEE WINDOW SCHEDULE FOR WINDOW TYPES.
 - ALL EXHAUST VENTS TO BE A MINIMUM OF 3'-0" AWAY FROM OPERABLE OPENINGS.
- 5. NOT ALL KEYNOTES OR LEGEND SYMBOLS USED ON EVERY



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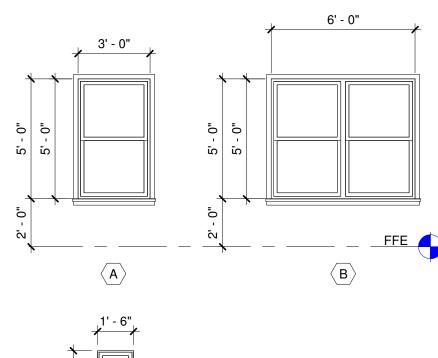
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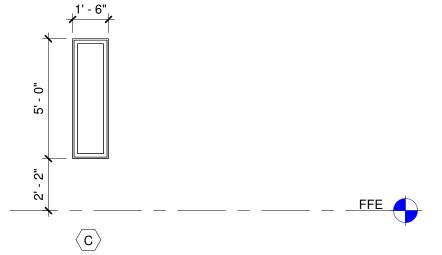
KEYNOTES

- CONCRETE BASE WALL TYP.
 FIBER CEMENT PLANK SIDING
 ASPHALT SHINGLE ROOFING SYSTEM
- ASPHALT SHINGLE ROOFING SYSTEM INSULATED FIBERGLASS DOOR, TYP. VINYL WINDOW SYSTEM, TYP.
- 6 STEEL STAIRS W/ PRECAST TREADS AND METAL RAILINGS 7 GUTTER AND DOWNSPOUT

LEGEND

- 1 KEYNOTE
- X WINDOW TAG





5 WINDOW ELEVATIONS
SCALE: 1/4" = 1'-0"

202010.00

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Author

DRAWING TITLE

PROJECT NUMBER

OC-III

BUILDING 3

206 LILLY RD NE

ISSUANCE SCHEMATIC DESIGN

OLYMPIA, WA

98506

DATE


10/14/2020


SCALE As indicated

BUILDING 3
ELEVATIONS

SHEET NUMBER

A4.31

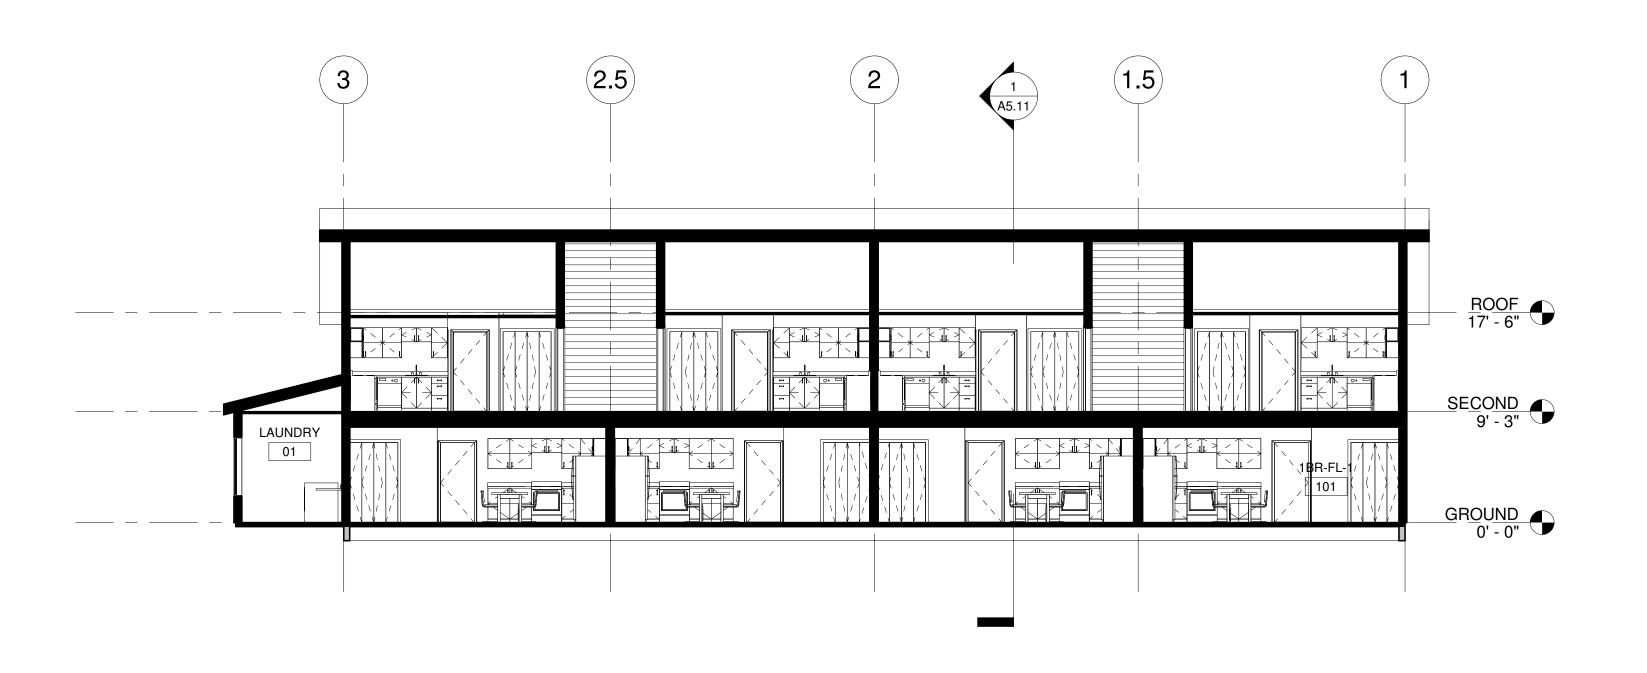

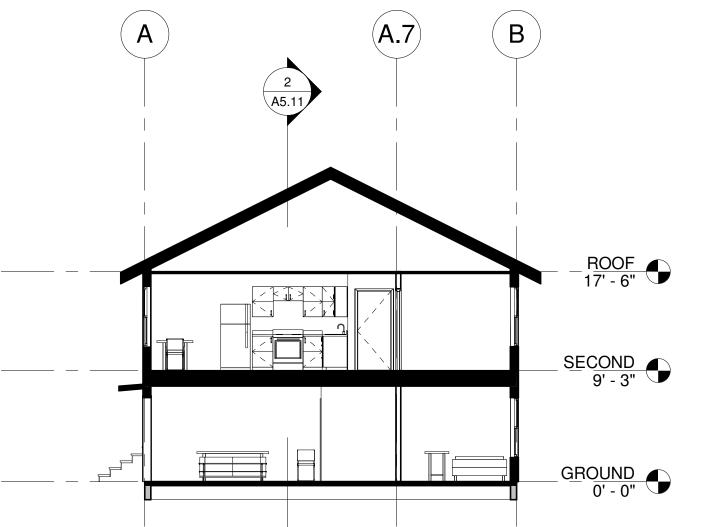

1. NOTE

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KEYNOTES

2 EAST WEST SECTION

SCALE: 1/8" = 1'-0"

NORTH SOUTH SECTION
SCALE: 1/8" = 1'-0"

LEGEND

KEYNOTE

OC-III BUILDING 1

206 LILLY RD NE OLYMPIA, WA 98506

ISSUANCE SCHEMATIC DESIGN

DATE 10/14/2020

SCALE As indicated

PROJECT NUMBER 202010.00


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DRAWING TITLE

BUILDING 1 SECTIONS

SHEET NUMBER

A5.11

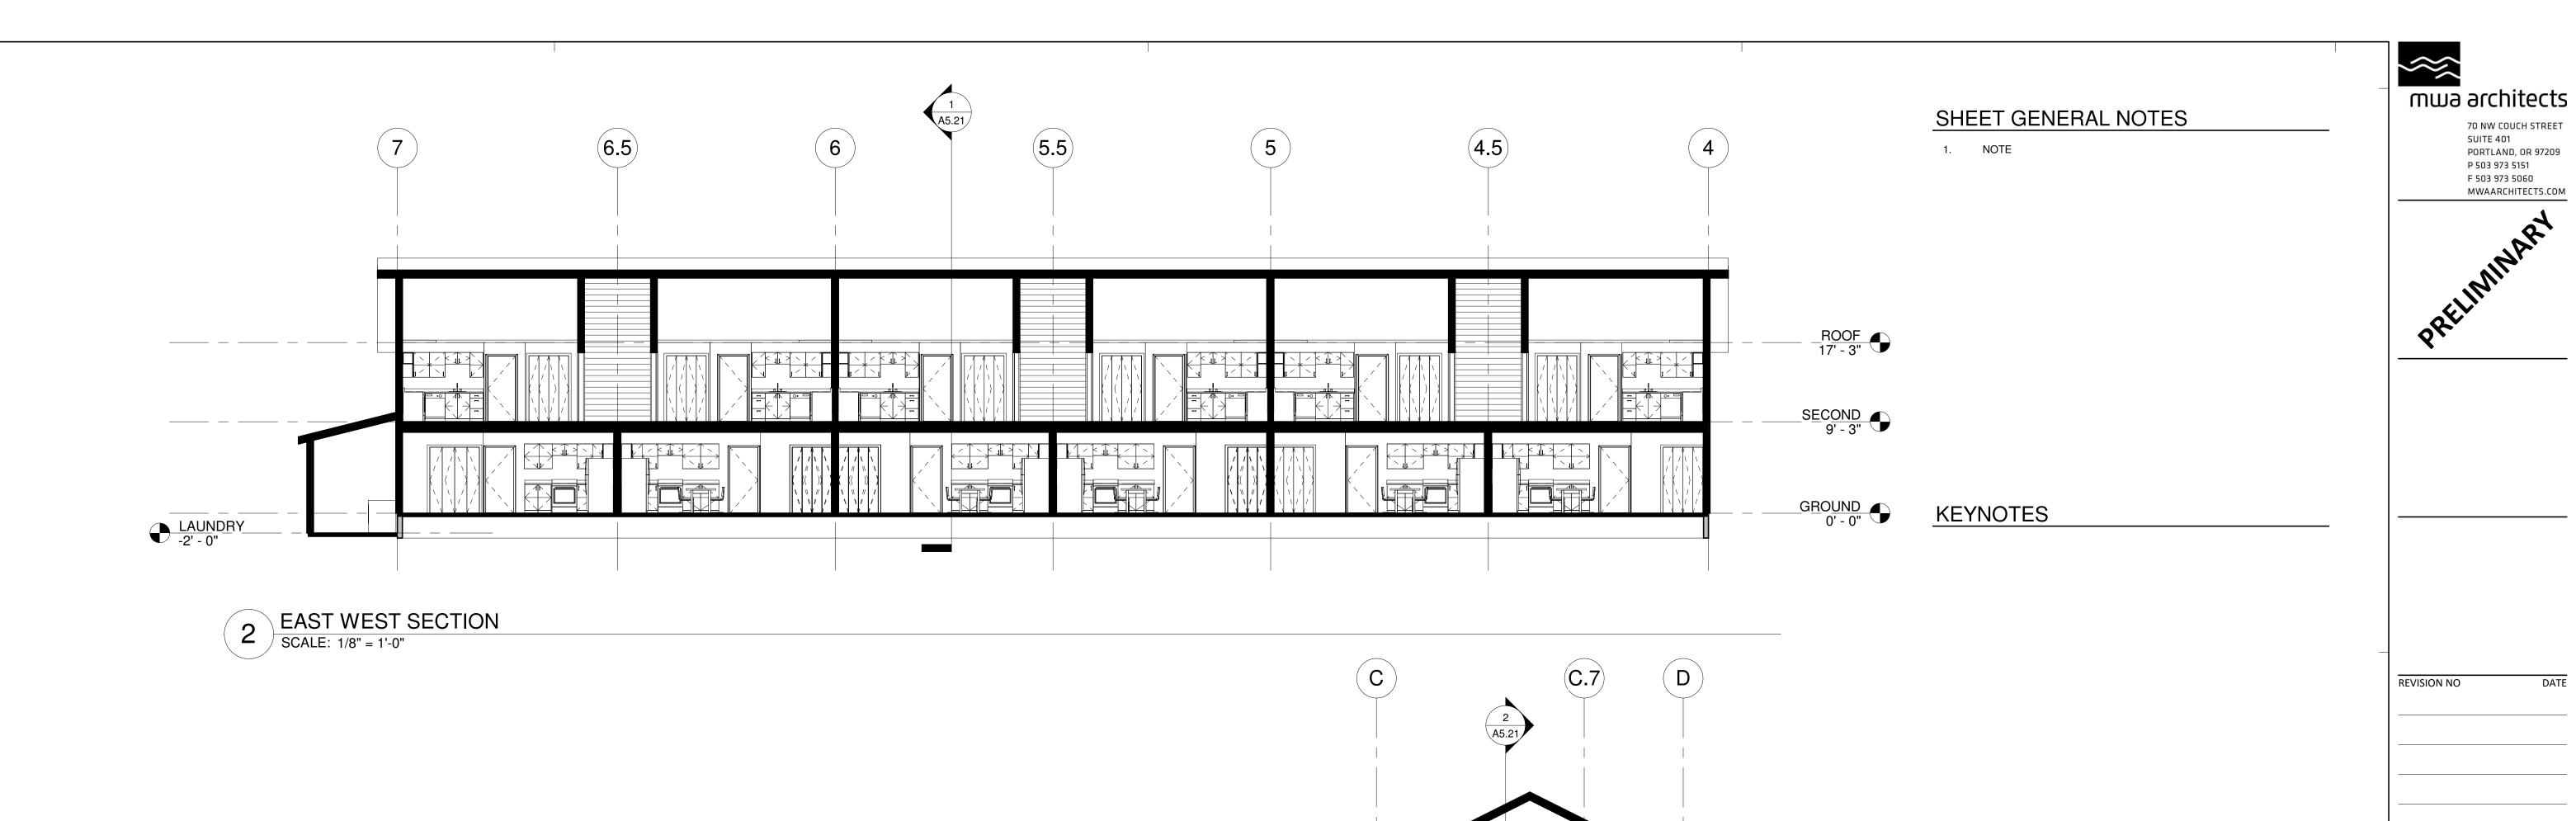

1 NORTH SOUTH SECTION
SCALE: 1/8" = 1'-0"

ROOF 17' - 3"

SECOND 9' - 3"

GROUND 0' - 0" LEGEND

KEYNOTE

OC-III BUILDING 2

206 LILLY RD NE OLYMPIA, WA 98506

ISSUANCE SCHEMATIC DESIGN DATE 10/12/2020

SCALE As indicated

PROJECT NUMBER 202010.00


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BUILDING 2 SECTIONS

SHEET NUMBER

A5.21



1. NOTE

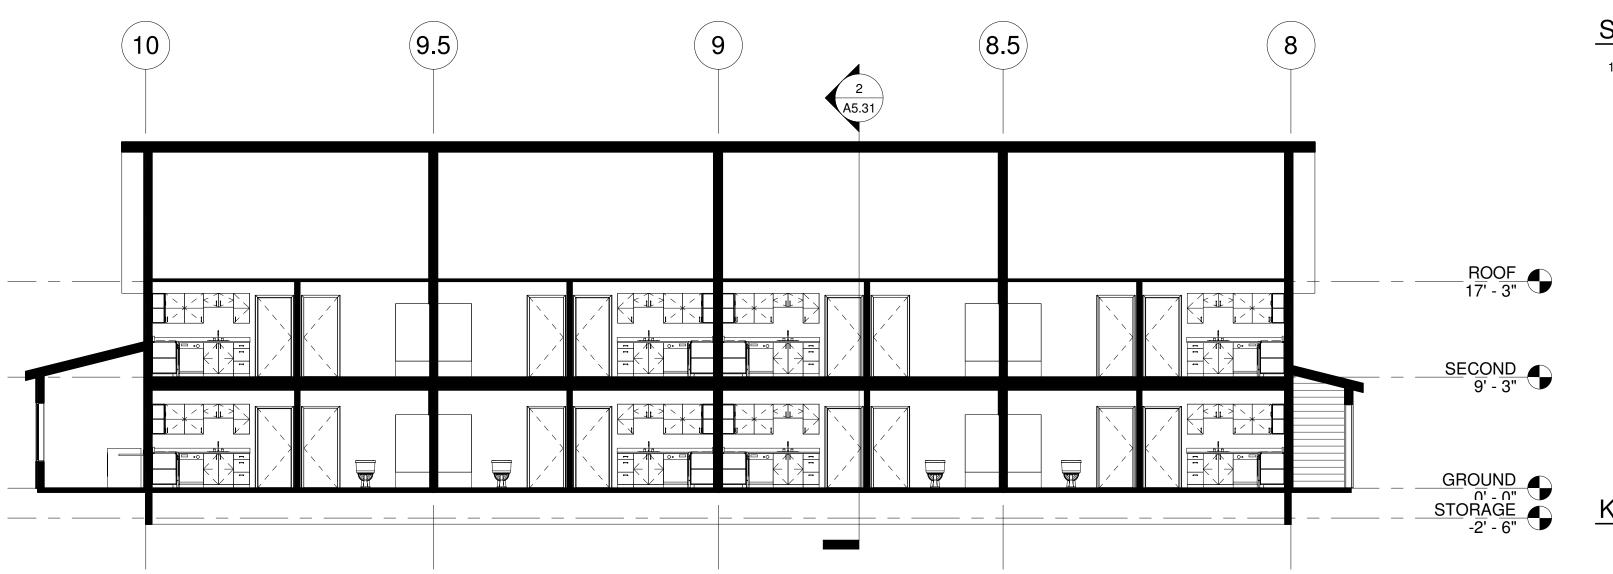PRELIMINARY


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KEYNOTES

1 EAST WEST SECTION
SCALE: 1/8" = 1'-0"



LEGEND

1 KEYNOTE

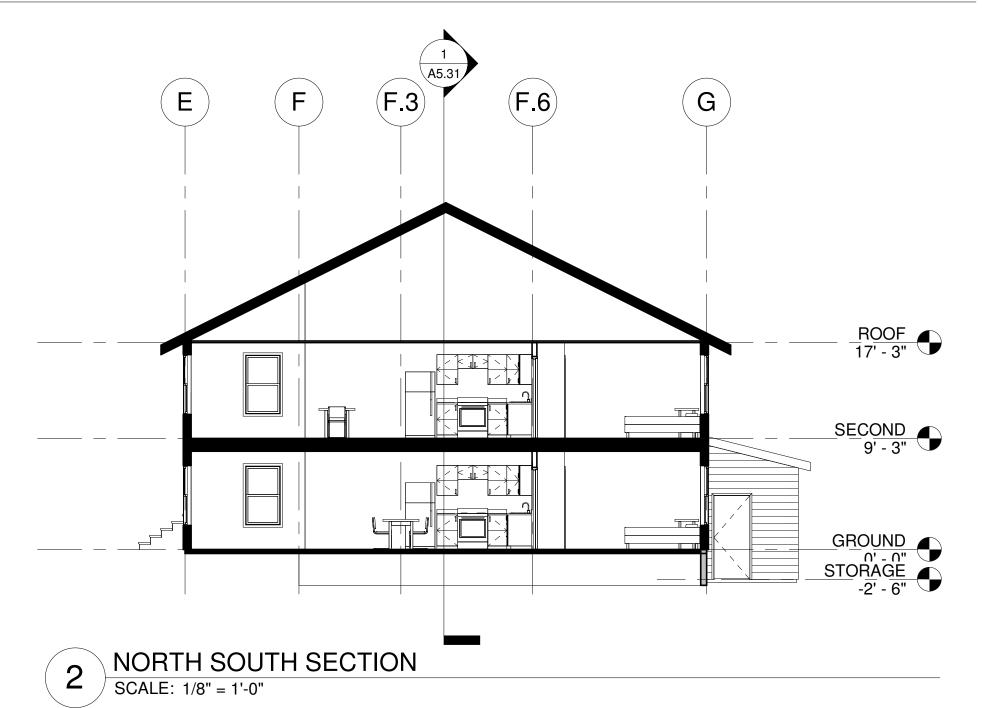OC-III BUILDING 3

REVISION NO

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ISSUANCE SCHEMATIC DESIGN

DATE 10/14/2020

SCALE As indicated

PROJECT NUMBER 202010.00

DRAWN BY Author

DRAWING TITLE

BUILDING 3
SECTIONS

SHEET NUMBER

A5.31

- SEE GSN's FOR ABBREVIATIONS AND SYMBOLS, AND MATERIAL GRADE REQUIREMENTS.
- REFER TO ARCH DRAWINGS FOR ALL DIMENSIONS AND ALL ITEMS REQUIRED TO BE COORDINATED WITH THIS WORK, BUT NOT SHOWN ON THESE DRAWINGS.
- 3. REFER TO CIVIL AND MECH ENGINEERING DRAWINGS FOR EXTENT OF ALL STORM, WATER, SEWER PIPES, AND FOR PLACEMENT AND LOCATION OF ALL UNDER SLAB DRAINS AND DUCT PENETRATIONS.
- 4. SEE ARCH DWGS FOR DIMENSIONS FOR DRAINS AND SLOPED SLAB

KEYED NOTES

1. INDICATES 6" SLAB ON GRADE W/ #4 AT 18" OC CENTERED VERT IN SLAB

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PERMIT SET REVISIONS:

DATE DESC.

NOTE: BUILDING 2 TO HAVE SIMILAR CONFIGURATION.


DIAPHRAGM SHEATHING SCHEDULE						
MARK	THICKNESS	PANEL EDGE ATTACHMENT	FIELD ATTACHMENT	BLOCKING REQUIREMENT	FASTENER ROWS	REFERENCE/ NOTES
S1	7/16"	8d AT 6" OC	8d AT 12" OC	UNBLOCKED	(1)	-
S2	23/32"	10d AT 6" OC	10d AT 12" OC	UNBLOCKED	(1)	-


1						
S2	23/32"	10d AT 6" OC	10d AT 12" OC	UNBLOCKED	(1)	-
	JOIST SCHEDULE					
MARK	MARK SIZE SPACING		SPACING	RE	FERENCE/ NOT	ES
J1	PMT		24" OC		-	
J2	11 7/8" TJI 110		16" OC	HA	NGER PER MA	NUF
12	44 7/0" T II 200		40".00	ш/	NICED DED MA	NILIE

	J3 11 7/8" TJI 360 16" OC HANGER PER MANUF						
			BEAM SCHEDUL	E			
N	MARK SIZE REFERENCE/ NOTES						
	B1	5 1/2x11 7/8 GLE	(S) HU OR	(S) HU OR HB HANGER, UNO			

БІ	5 1/2X11 1/0 GLB		3 1/2X11 1/6 GLB (3) HO OK I		(3) NO OK NB	HANGER, UNO	
COLUMN SCHEDULE							
MARK	SIZE	CAP/BUCKET	BASE/PLATE	REFERENCE/ NOTES			
C1	4x6	PC4Z	(S) ABU44	-			
C2	6x6	PC6Z	(S) ABU66	-			

		FOOTING SC	HEDULE	
MARK	TRANSVERSE SIZE (WIDTH) AND REINFORCEMENT	LONGITUDINAL SIZE (LENGTH) AND REINFORCEMENT	THICKNESS	REFERENCE/ NOTES
F1	2'-0" W/ (2) #4 BOT	CONT.	12"	-

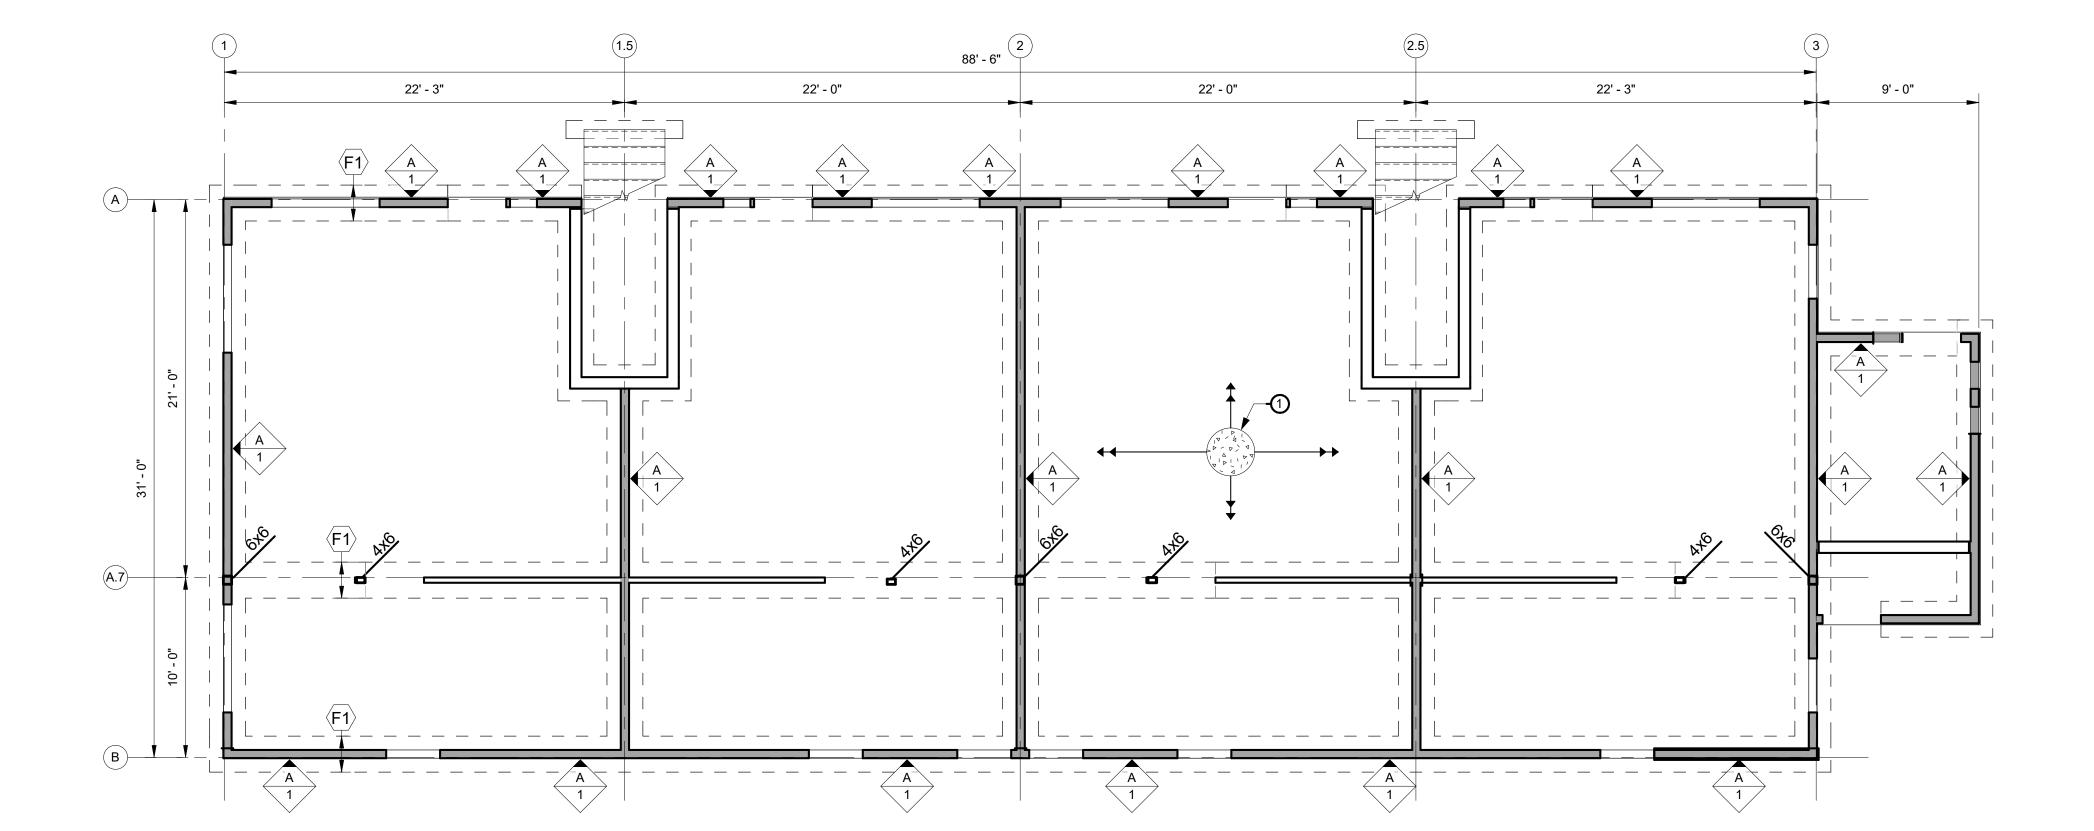

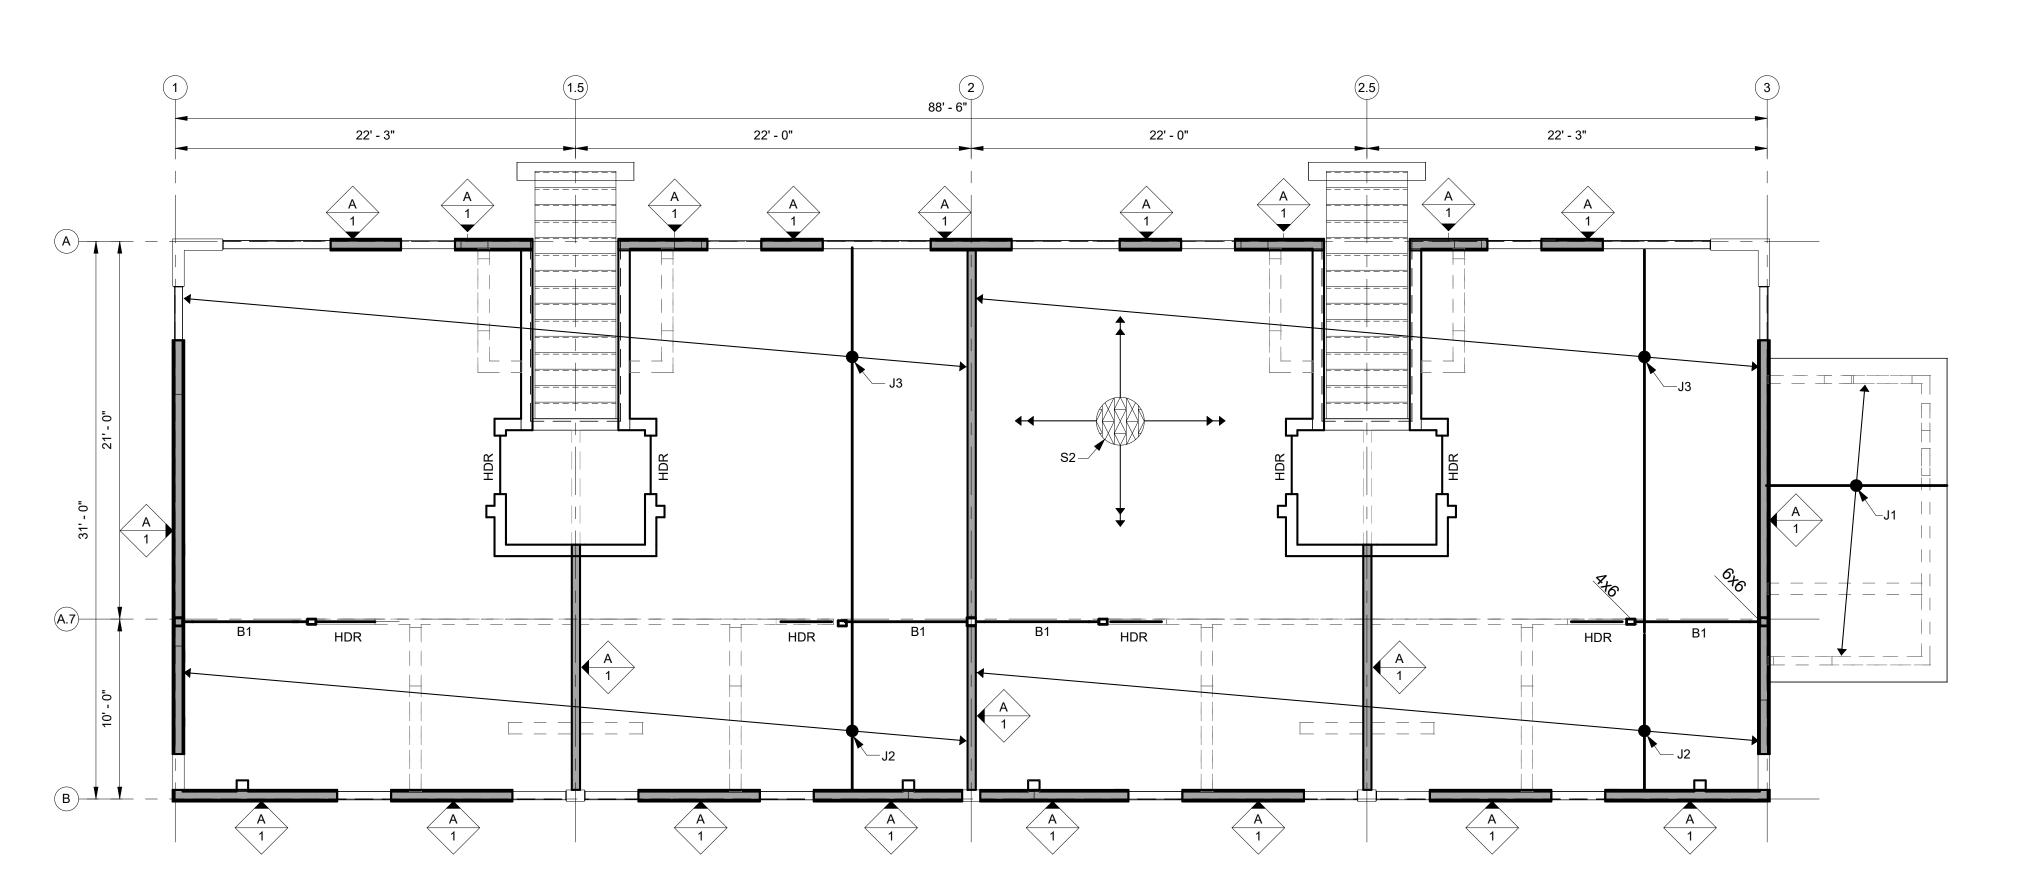

2 SECOND FLOOR FRAMING PLAN 3/16" = 1'-0"

1 FOUNDATION PLAN 3/16" = 1'-0"

SHEET TITLE:

BUILDING 1 -FOUNDATION / SECOND FLOOR FRAMING PLAN

PROJECT # 20162 ISSUE DATE: 10/14/2020

AUTHOR:

- 1. SEE GSN's FOR ABBREVIATIONS AND SYMBOLS, AND MATERIAL GRADE REQUIREMENTS.
- 2. REFER TO ARCH DRAWINGS FOR ALL DIMENSIONS AND ALL ITEMS REQUIRED TO BE COORDINATED WITH THIS WORK, BUT NOT SHOWN ON THESE DRAWINGS.
- REFER TO CIVIL AND MECH ENGINEERING DRAWINGS FOR EXTENT OF ALL STORM, WATER, SEWER PIPES, AND FOR PLACEMENT AND LOCATION OF ALL UNDER SLAB DRAINS AND DUCT
- 4. ALL FRAMING TO BE CENTERED ON WALLS, COLUMN, GRIDLINES,OR LOCATED AT EQUAL SPACES BETWEEN GRIDLINES, UNO.

NOTI	E: BUILDING	2 TO HAVE S	IMILAR CONF	FIGURATION.		
		DIAPHRAC	GM SHEATHI	NG SCHEDUL	_E	
MARK	THICKNESS	PANEL EDGE ATTACHMENT	FIELD ATTACHMENT	BLOCKING REQUIREMENT	FASTENER ROWS	REFERENCE NOTES
	7/400	0.1.4.7.011.0.0	0 1 4 7 40 1 0 0	LINIBI GOL(ED	(4)	

S1	7/16" 8d AT 6" C		6" OC 8d AT 12" OC UNBLOCKED		(1)	-						
	JOIST SCHEDULE											
MARK	SIZE		SPACING	REF	ERENCE/ NOT	ES						
J1	PMT		24" OC		-							

SE REVISIONS: # DATE DESC.

BUILDING

PERMIT SET

SHEET TITLE:

BUILDING 1 - ROOF FRAMING PLAN

PROJECT # 20162 ISSUE DATE: 10/14/2020

AUTHOR:

88' - 6"

RIDGE

22' - 0"

22' - 3"

22' - 0"

22' - 3"

1 ROOF FRAMING PLAN 3/16" = 1'-0"

PLAN NOTES

mwa architects

SUITE 401

70 NW COUCH STREET


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KEYED NOTES

	HOLDOWN SCHEDULE											
MARK	HOLDOWN	WOOD MEMBER	WOOD FASTENER	ANCHOR BOLT	ANCHOR BOLT EMBEDMENT (IN)	COMMENTS						
	(S) HDU4-SDS2.5	(2) 2x	(10) 1/4" DIA x 2 1/2" SDS SCREWS	(S) PAB 5	de = 8"	N/A						
2	(S) HDU14-SDS2.5	(1) 6x	(36) (S) SDS SCREWS	(S) PAB 8	de = 11"	N/A						

- DOUBLE STUDS ARE REQUIRED AT HOLDOWNS UNLESS NOTED OTHERWISE. DOUBLE STUDS SHALL BE LAMINATED TOGETHER WITH 16d NAILS AT 6" OC FULL HEIGHT, TYP.
- 2. PROVIDE HOLDOWN NOTED WITHIN 6" FROM EACH END OF EACH SHEAR WALL SHOWN ON PLANS.
- PROVIDE (2) ADDL VERT DOWELS WITH STD HK IN FTG AT EA ANCHOR BOLT LOCATION.
- 4. INSTALL ANCHORS PER MANUFACTURER'S RECOMMENDATIONS.
- 5. ADJUST FOOTING AND STEM WALL HEIGHT TO ACCOMMODATE ANCHOR BOLT EMBEDMENT REQUIREMENTS PER MANUFACTURER'S RECOMMENDATIONS.
- ALL HOLDOWN ANCHORS AND BOLTS SHALL BE INSTALLED IN THE CORRECT LOCATION IN THE TOP OF THE CONCRETE WALL AND SECURED TO THE FORMS PRIOR TO CONCRETE INSTALLATION. THERE IS NO PRACTICAL SOLUTION TO POST-INSTALLED HOLDOWN ANCHORS IN THE TOP OF THE CONCRETE STEM WALL. NO EPOXY OR MECHANICAL ANCHOR BOLT ALTERNATIVES WILL BE OFFERED FOR MISSING OR MISPLACED EMBEDDED ANCHORS. CONCRETE FOOTINGS AND STEM WALLS MAY HAVE TO BE REMOVED AND REPLACED AT CONTRACTOR'S EXPENSE TO MITIGATE MISPLACED, MISALIGNED, OR MISSING HOLDOWN ANCHORS OR BOLTS.
- 7. DO NOT NAIL BOTTOM HALF OF STRAP TO BUILT UP STUD UNTIL ALL FLOOR AND ROOF FRAMING HAS BEEN INSTALLED.
- 8. IT IS ACCEPTABLE TO SUBSTITUTE ASTM F1554, GRADE 36 OR ASTM A36 THREADED ROD WITH DOUBLE HEAVY HEX NUT AND PLATE WASHER FOR (S) PAB ANCHOR. THE DIAMETER OF THE THREADED ROD SHALL BE EQUIVALENT TO THE DIAMETER OF THE SIMPSON ANCHOR SPECIFIED. SEE SIMPSON CATALOG FOR LOCATION OF PLATE WASHER AND DOUBLE NUT.



	SHEAR WALL SCHEDULE													
MARK	MARK SHEATHING	SIDE -		PANEL NAILIN	lG	PANEL	SILL	ANCHOR BOLTS	SILL NAILING	VALUE				
WALKIX		SIDE	SIZE	EDGE	FIELD	BLOCKING	PLATE	ANGITON BOLTS	OILL WAILING	(PLF)				
Â	15/32" APA RATED SHEATHING WITH STUDS AT 16" OC	ONE	10d	6" OC	12" OC	2x	2x	5/8" x 10" AT 40" OC	16d AT 4" OC	340				
B	15/32" APA RATED SHEATHING WITH	ONE	104	2" 00	12" 00	3x	3x	5/8" x 12" AT 18" OC	404 474 4/01/00 50					
	STUDS AT 16" OC	ONE	10d 2" OC 12" OC	3%	(2) 2x	5/6 X 12 AT 16 OC	16d AT 1 1/2" OC ES	-						
c	15/32" APA RATED SHEATHING WITH	TWO	10d	2" OC	12" OC	2 v	3x	5/01 401 AT 401 00	40 1 47 4 4/01 00 50					
	STUDS AT 16" OC	1000	100	2 00	12 00	3x	(2) 2x	5/8" x 12" AT 12" OC	16d AT 1 1/2" OC ES	-				

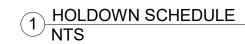NOTES:

- 1. 10d NAIL = 3" x 0.148" COMMON OR 3" x 0.128" GALVANIZED BOX.
- IF AB SPACING IS GREATER THAN SHEAR WALL LENGTH INSTALL (1) AB WITHIN 12" OF EACH END.
- NAIL SIZES SHOWN ARE FOR COMMON NAILS OR GALVANIZED BOX. POWER DRIVEN NAILS SHALL COMPLY WITH ESR 1539 FOR RECOMMENDED SPACING AND INSTALLATION TO COMPLY WITH THE ABOVE SHEAR WALL SCHEDULE.
- SILL PLATE ANCHORS SHALL INCLUDE A STEEL PLATE WASHER NOT LESS THAN 0.229"x3"x3" IN SIZE PER AFANDPA SDPWS SECTION 4.3.6.4.3. THE HOLE IN THE PLATE WASHERS SHALL BE PERMITTED TO BE DIAGONALLY SLOTTED W/ A WIDTH OF UP TO 3/16" LARGER THAN THE BOLT DIAMETER AND A SLOT LENGTH NOT TO EXCEED 1 3/4", PROVIDED A STANDARD CUT WASHER IS PLACED BETWEEN THE PLATE WASHER AND THE NUT. THE PLATE WASHER SHALL EXTEND TO WITHIN 1/2" OF THE EDGE OF THE BOTTOM PLATE ON THE SIDE(S) WITH SHEATHING.
- WHERE SHEAR DESIGN VALUES EXCEED 700 POUNDS PER LINEAR FOOT (350 PLF ASD), ALL FRAMING MEMBERS RECEIVING EDGE NAILING FROM ABUTTING PANELS SHALL NOT BE LESS THAN A SINGLE 3-INCH NOMINAL MEMBER, OR TWO 2-INCH NOMINAL MEMBERS FASTENED TOGETHER IN ACCORDANCE WITH SECTION 2306.1 TO TRANSFER THE DESIGN SHEAR VALUES BETWEEN FRAMING MEMBERS. WOOD STRUCTURAL PANEL JOINT AND SILL PLATE NAILING SHALL BE STAGGERED IN ALL CASES. SEE 7/S7.0 FOR ADDITIONAL INFORMATION.
- WHERE PANELS ARE APPLIED TO BOTH FACES OF A WALL AND NAIL SPACING IS LESS THAN 6" OC ON EITHER SIDE, PANEL JOINTS SHALL BE OFFSET TO FALL ON DIFFERENT FRAMING MEMBERS. ALTERNATIVELY, THE WIDTH OF THE NAILED FACE OF FRAMING SHALL BE 3-INCH NOMINAL OR GREATER AT ADJOINING PANEL EDGES AND NAILS AT ALL PANEL EDGES SHALL BE STAGGERED.
- SHEAR WALL NAILING MUST BE INSTALLED SUCH THAT THE NAIL HEAD OR CROWN IS FLUSH WITH THE SURFACE OF SHEATHING. OVERDRIVEN OR OVERPENETRATED NAILS WILL NOT BE ALLOWED OR COUNTED AS APPROPRIATE NAILING.

2 SHEAR WALL SCHEDULE NTS

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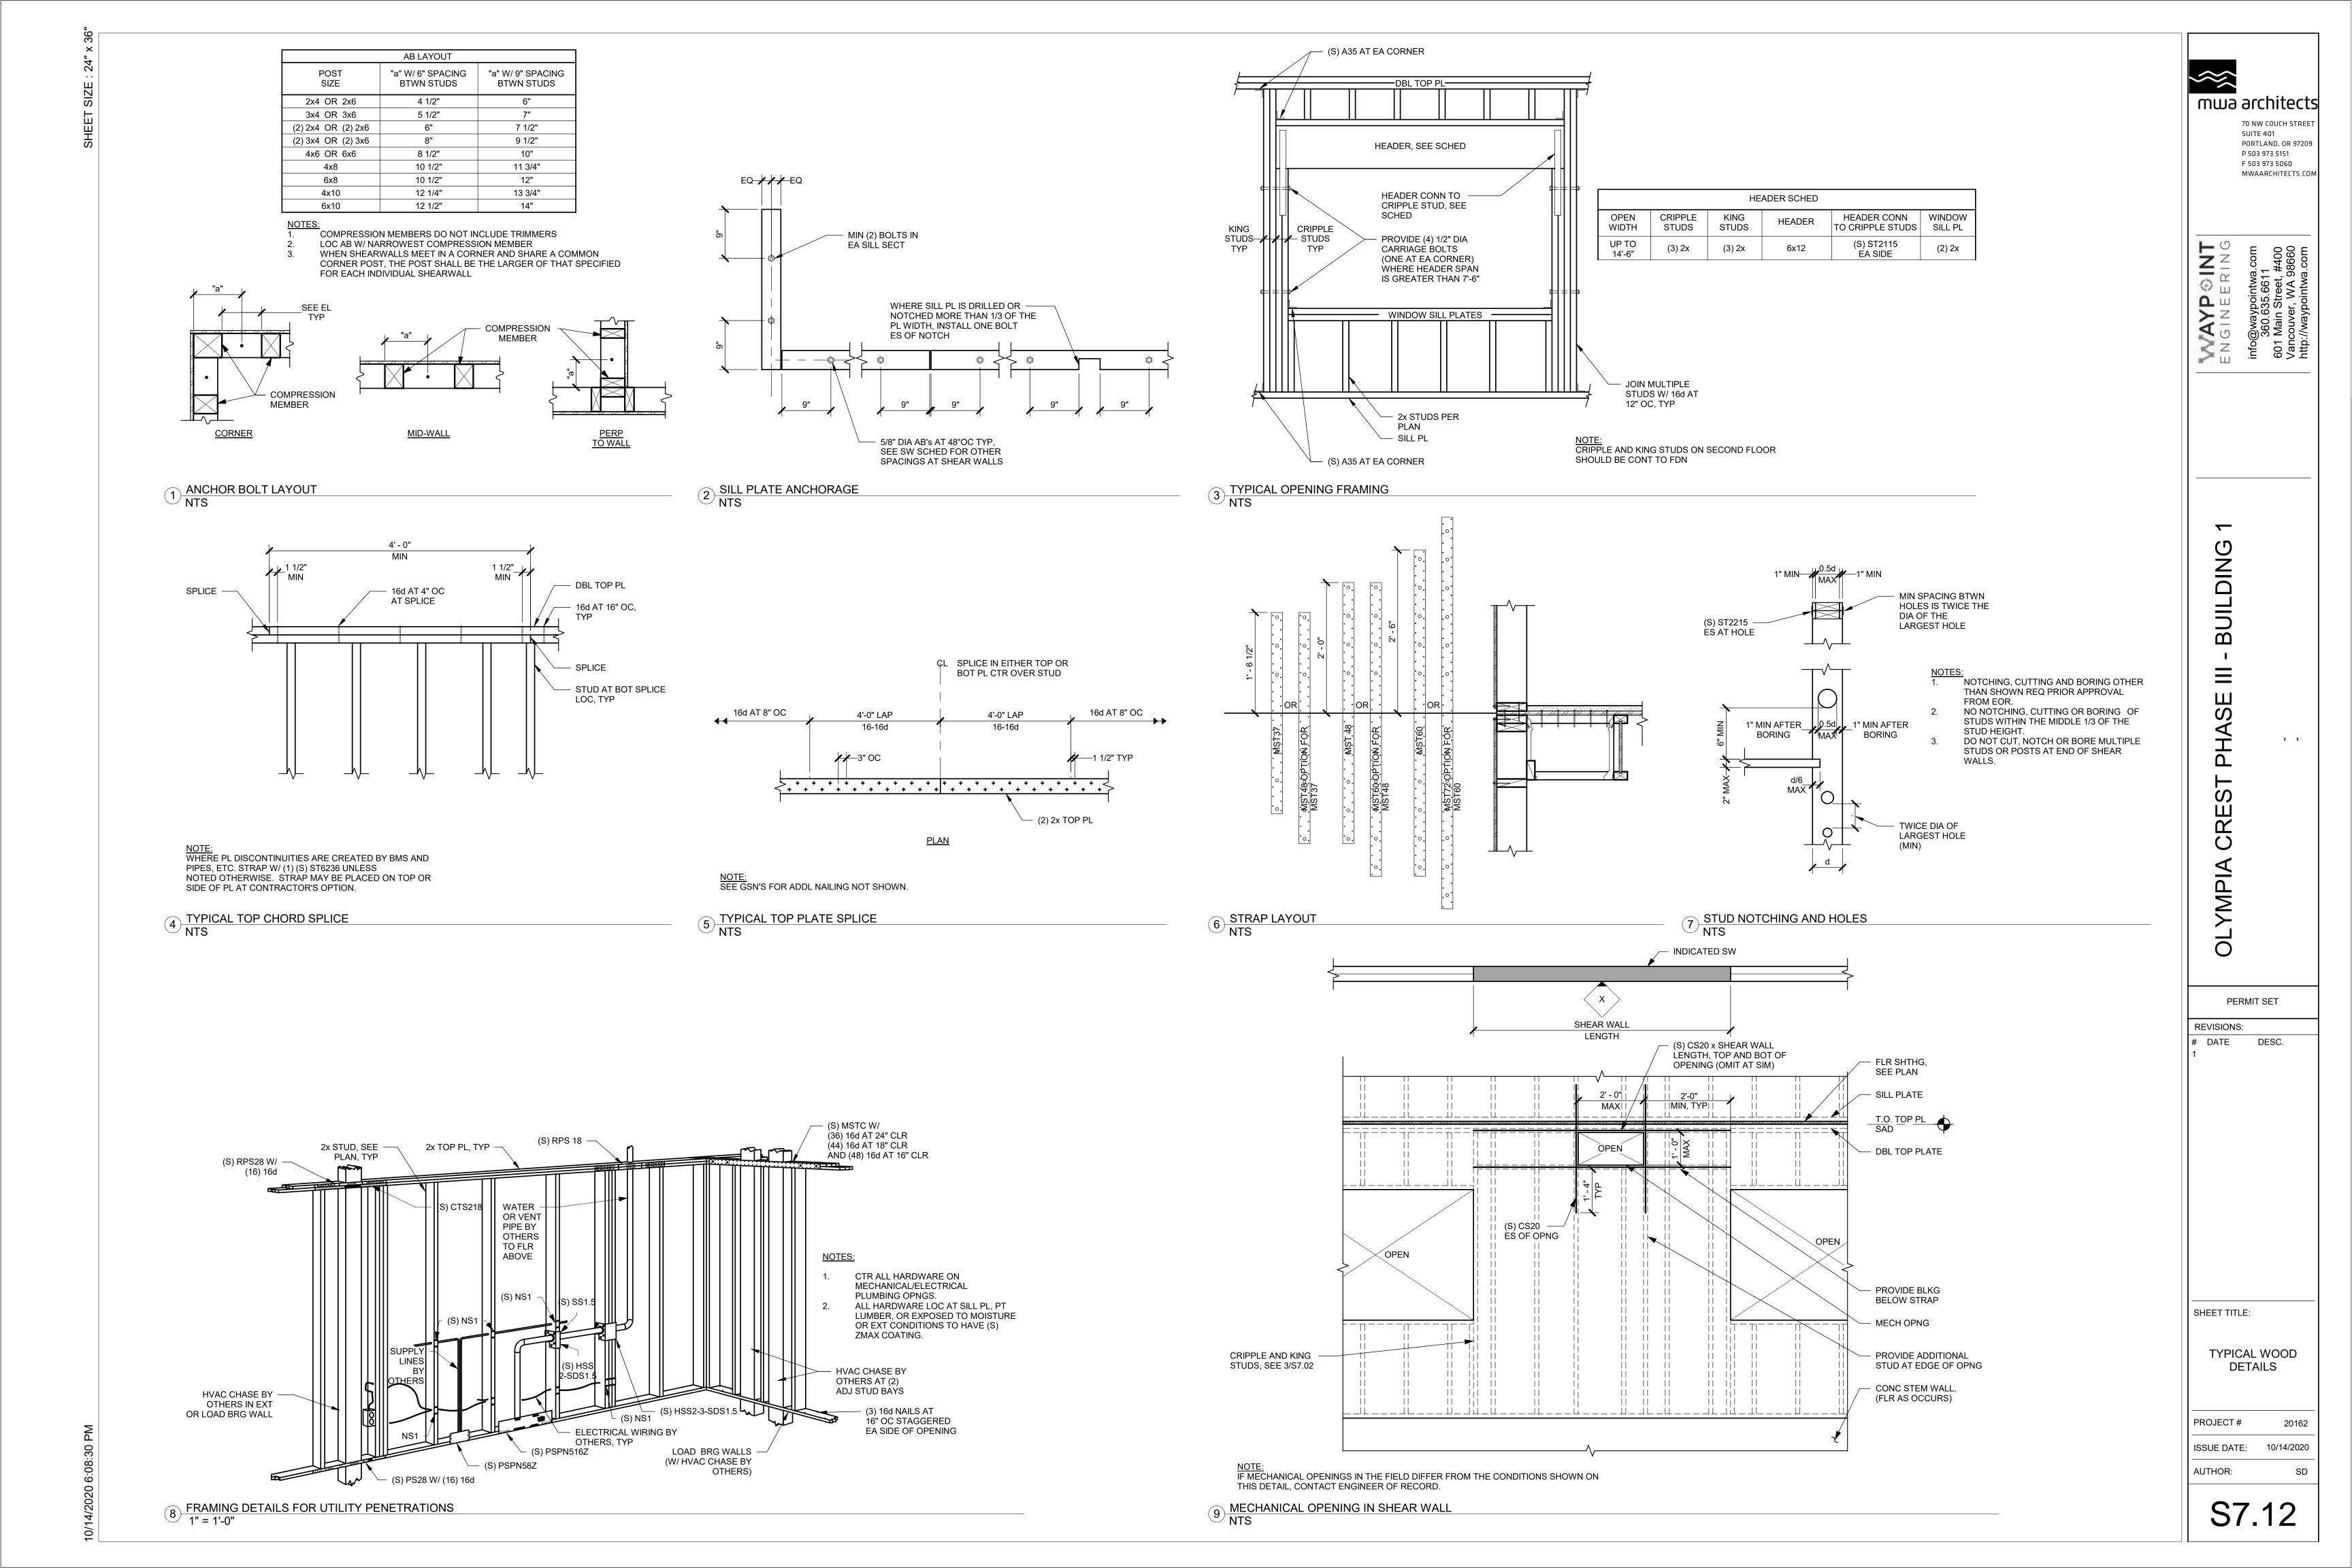
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SHEET TITLE:

AUTHOR:

SHEARWALL / HOLD-DOWN SCHEDULE AND DETAILS

PROJECT # 20162 ISSUE DATE: 10/14/2020



CONT WALL AT SIM

FASTENERS PER MFR

SHTHG, SEE PLAN

STRAP LENGTH, SEE PLAN

STRAP, SEE PLAN

TENSION TIE AND AB, SEE PLAN

JST, SEE PLAN

- FLAT BLKG, SEE PLAN


LEDGER AND AB, SEE PLAN


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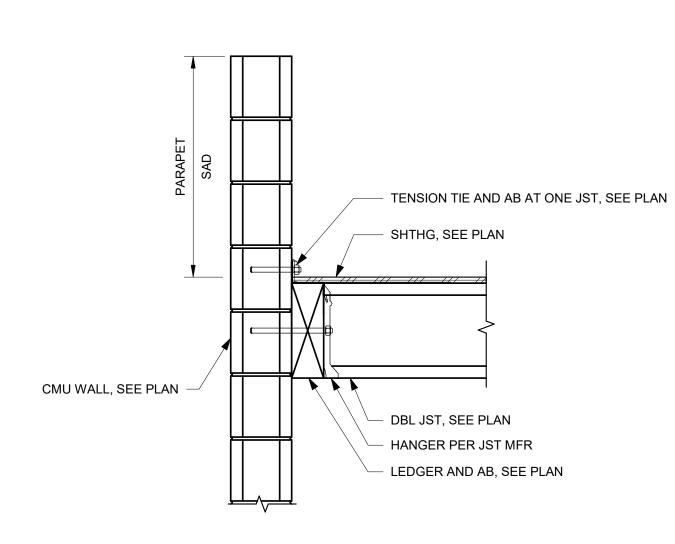
DETAILS

PROJECT# 20162


ISSUE DATE: 10/14/2020 AUTHOR: S7.13




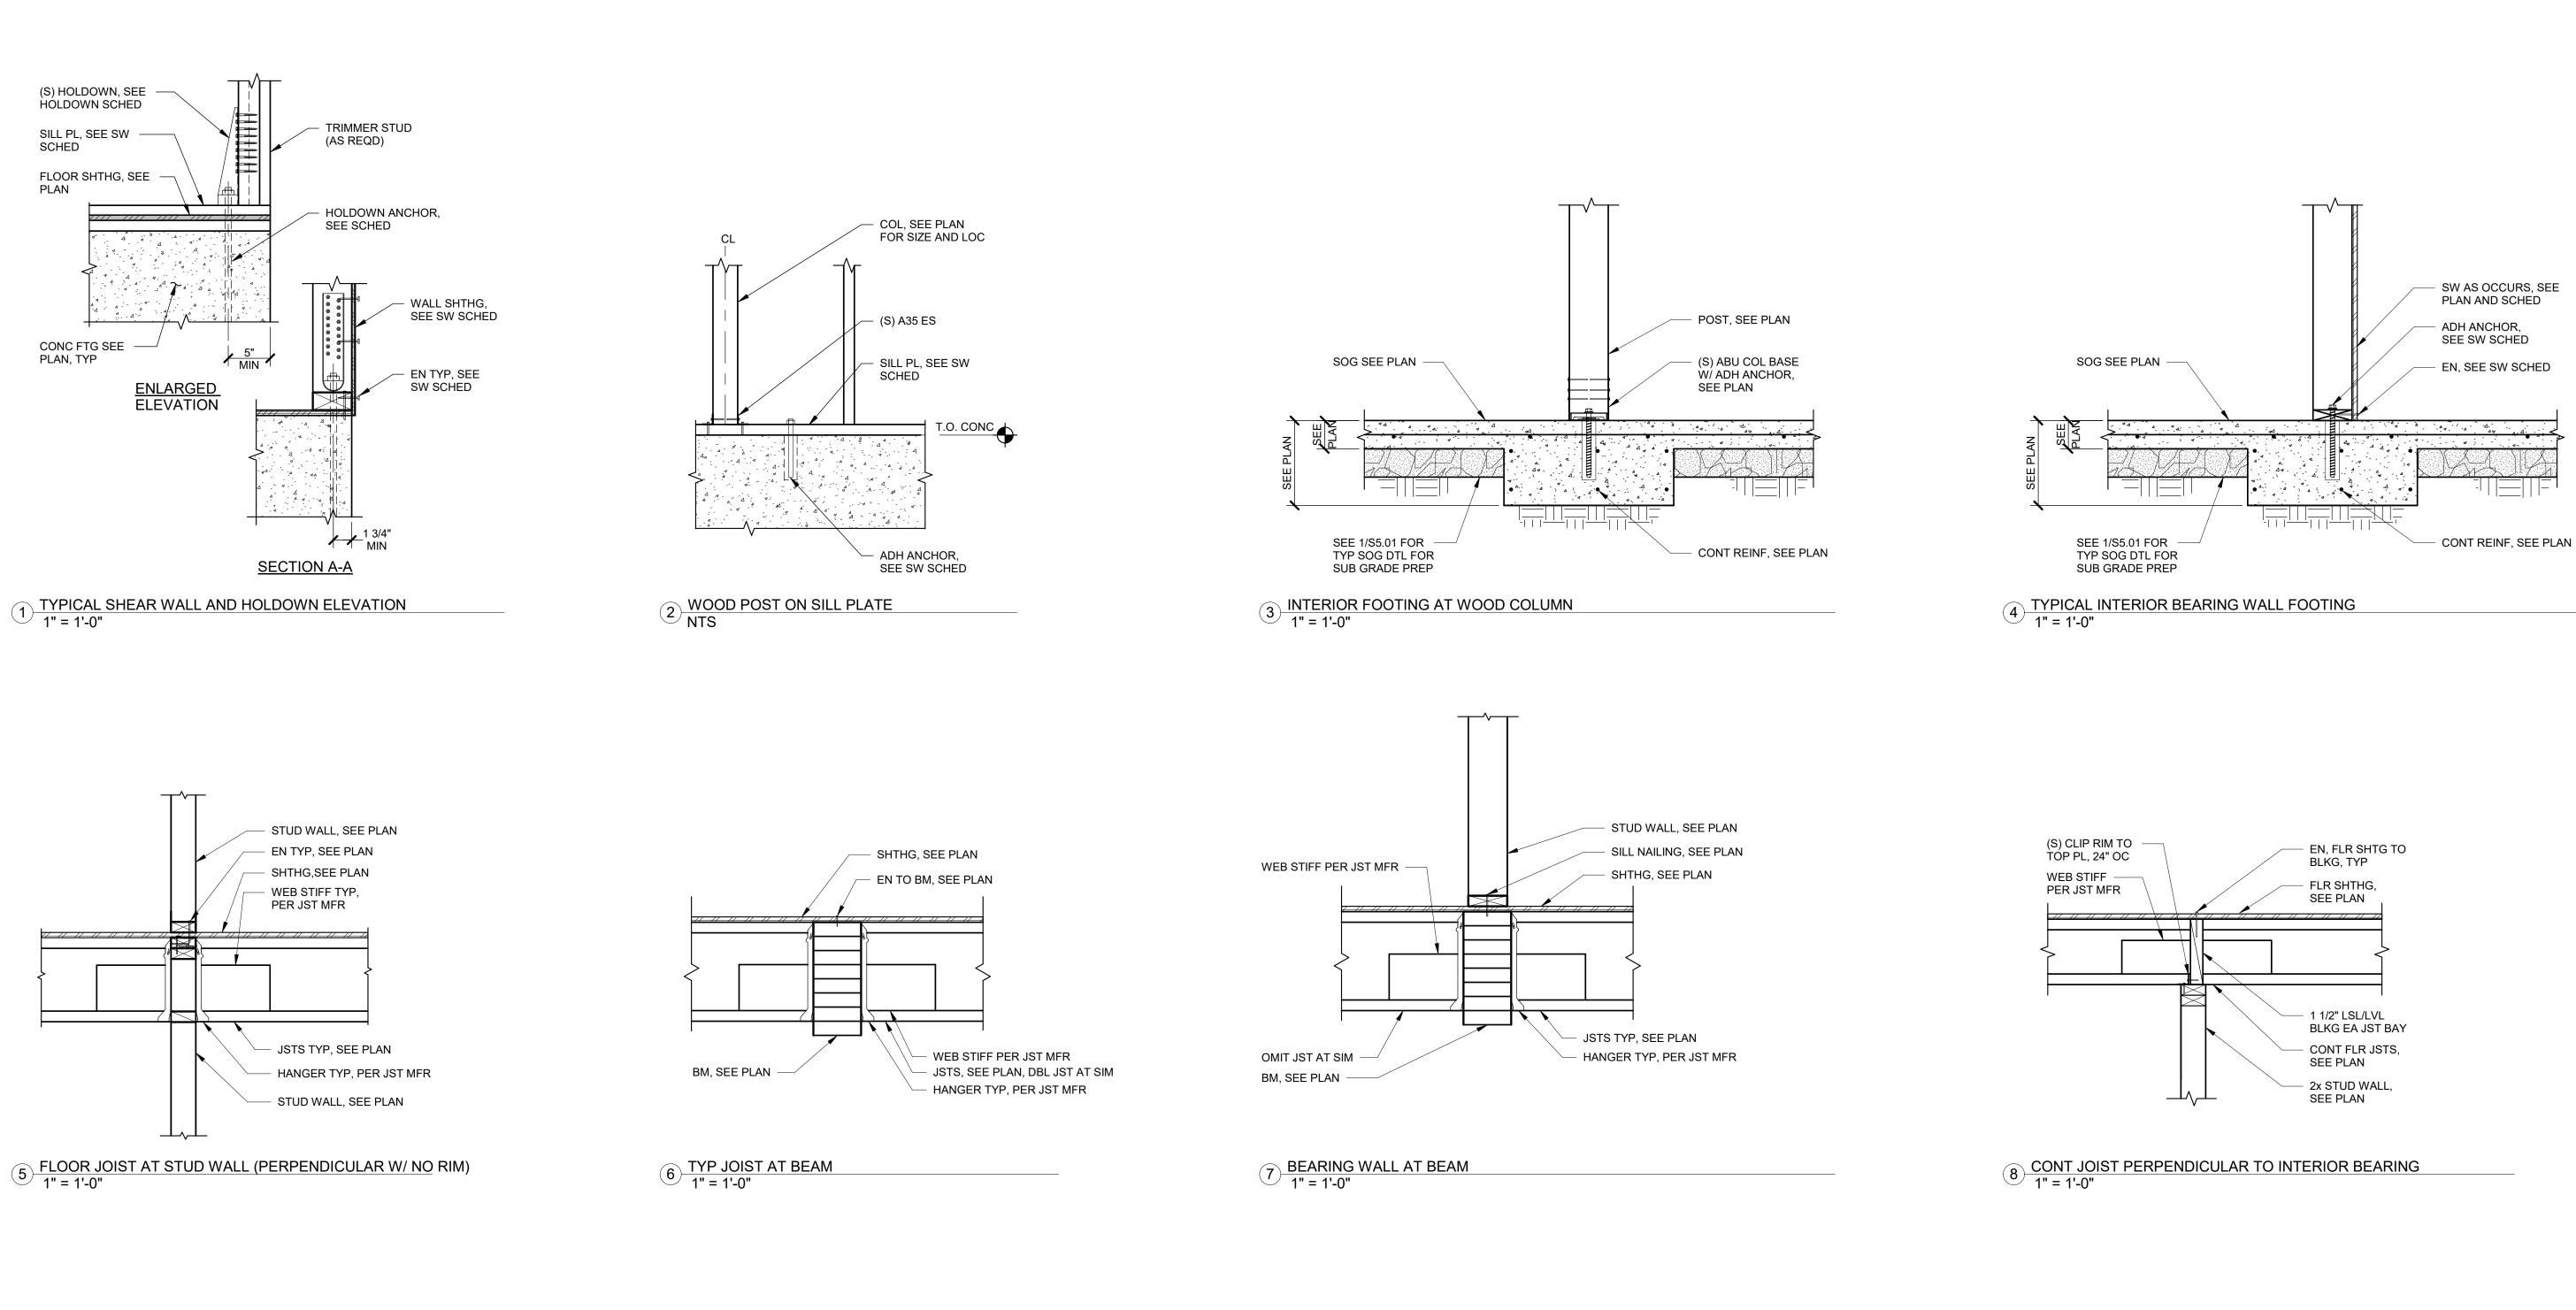


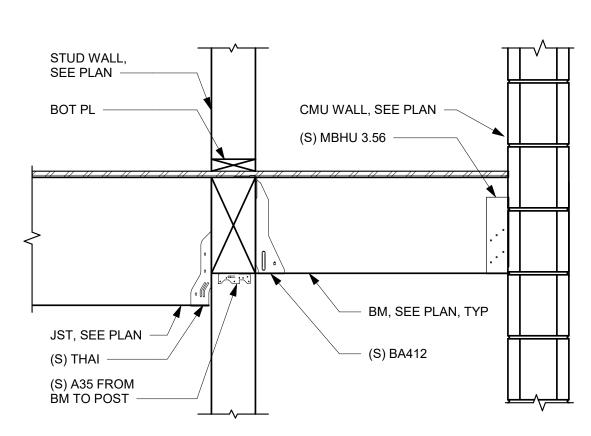


10 DOUBLE JOIST PERP TO CMU WALL
1" = 1'-0"

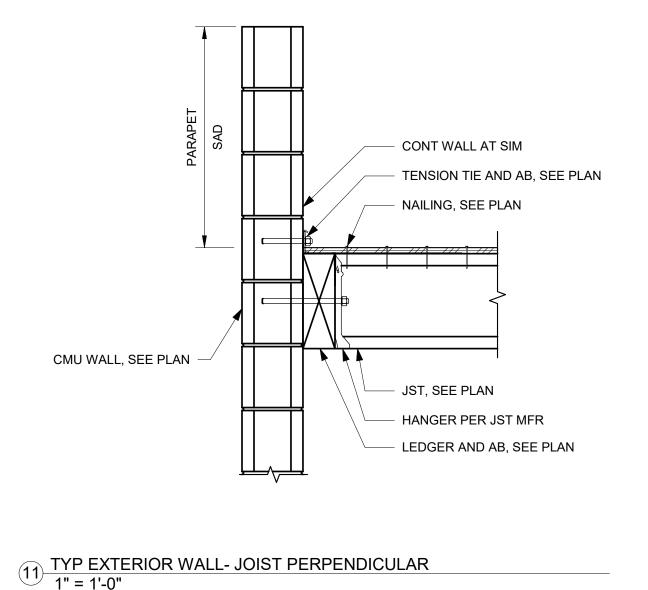

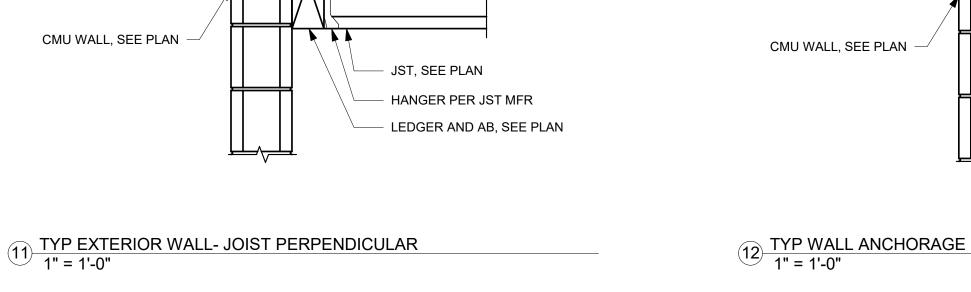

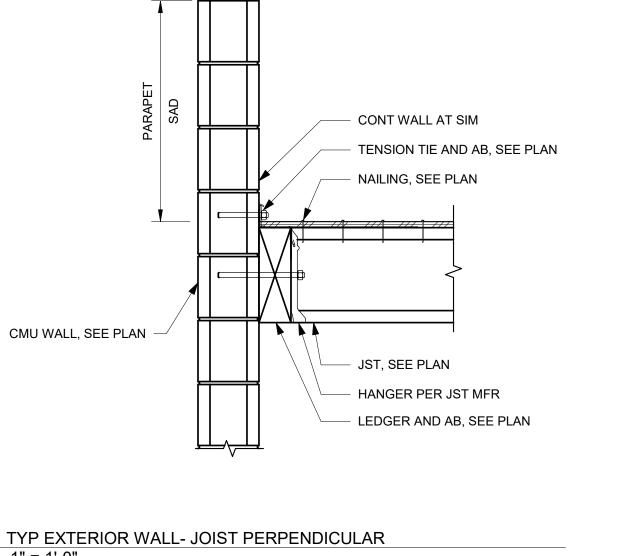

9 BEAM AT STAIRS 1" = 1'-0"

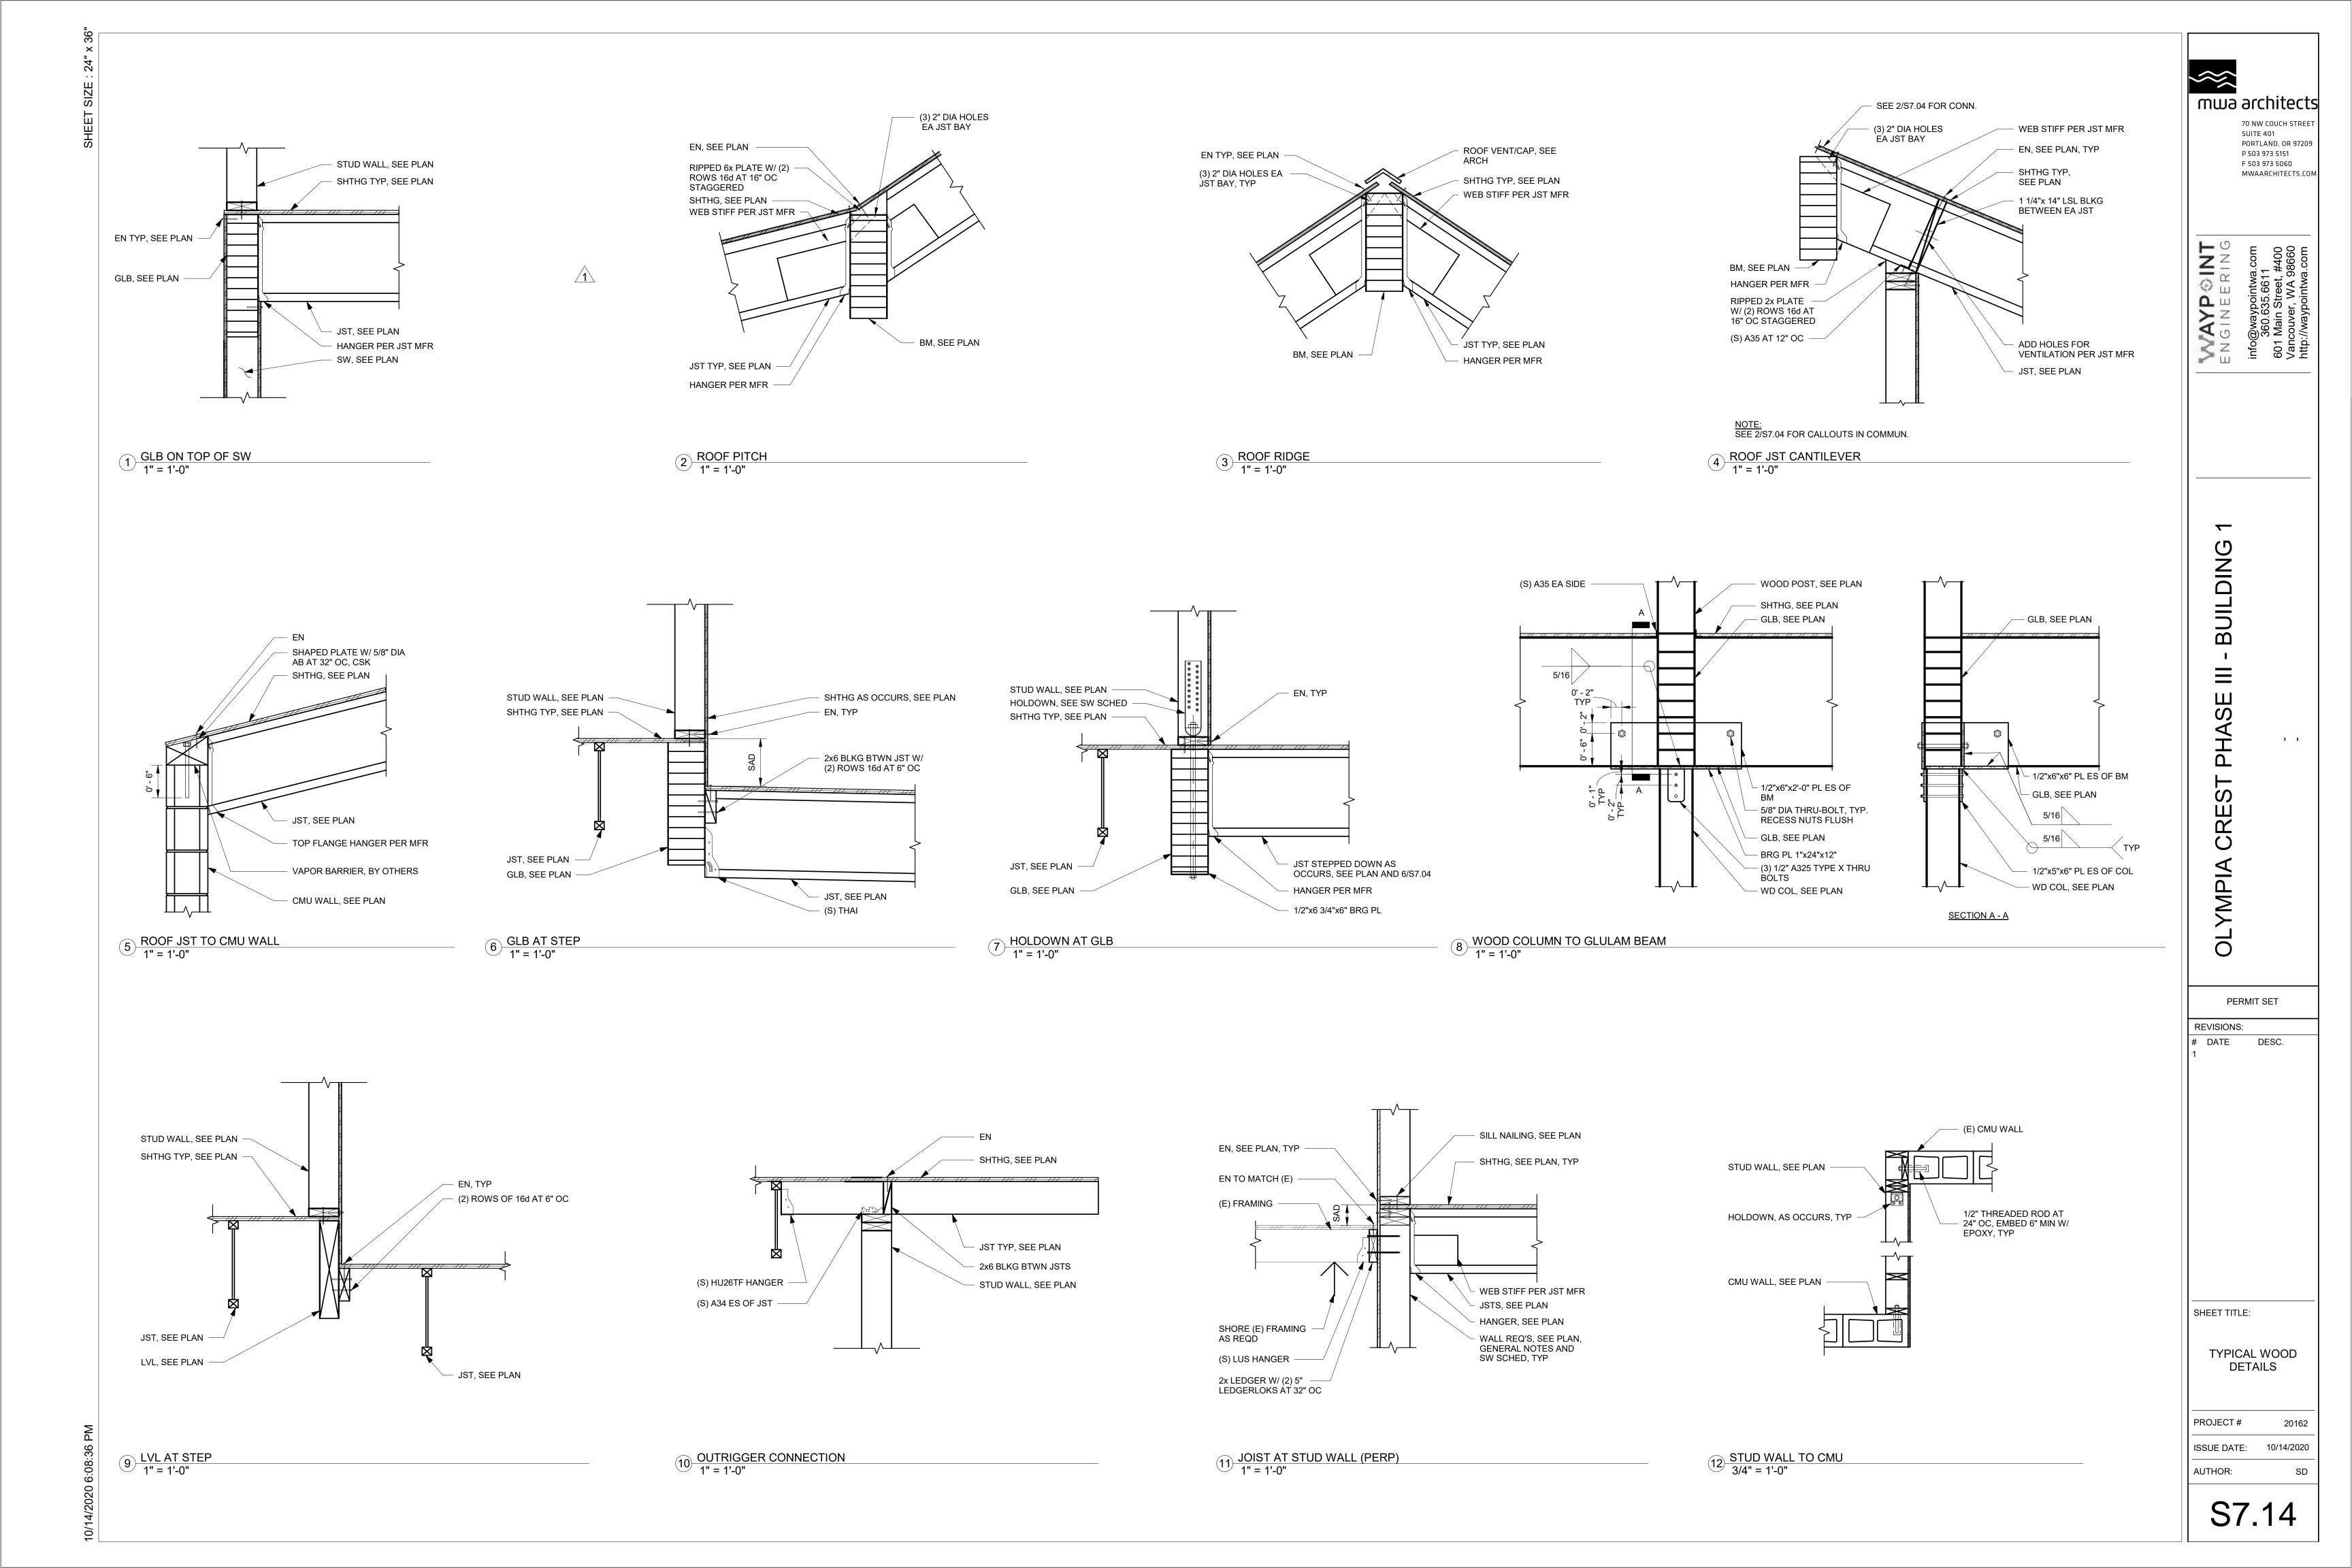

PLAN NOTES

- SEE GSN's FOR ABBREVIATIONS AND SYMBOLS, AND MATERIAL GRADE REQUIREMENTS.
- REFER TO ARCH DRAWINGS FOR ALL DIMENSIONS AND ALL ITEMS REQUIRED TO BE COORDINATED WITH THIS WORK, BUT NOT SHOWN ON THESE DRAWINGS.
- 3. REFER TO CIVIL AND MECH ENGINEERING DRAWINGS FOR EXTENT OF ALL STORM, WATER, SEWER PIPES, AND FOR PLACEMENT AND LOCATION OF ALL UNDER SLAB DRAINS AND DUCT PENETRATIONS.
- 4. SEE ARCH DWGS FOR DIMENSIONS FOR DRAINS AND SLOPED SLAB

KEYED NOTES

1. INDICATES 6" SLAB ON GRADE W/ #4 AT 18" OC CENTERED VERT IN SLAB

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JOIST SCHEDULE **SPACING** REFERENCE/ NOTES 24" OC 16" OC HANGER PER MANUF HANGER PER MANUF

MARK	SIZ	E	REFERENCE/ NOTES						
B1	5 1/2x11	7/8 GLB	(S) HU OR HB HANGER, UNO						
		COLU	MN SCHEDULE						
MARK	SIZE	CAP/BUCKET	BASE/PLATE	REFERENCE/ NOTES					
C1	4x6	PC4Z	(S) ABU44	-					

BEAM SCHEDULE

DIAPHRAGM SHEATHING SCHEDULE

8d AT 6" OC 8d AT 12" OC UNBLOCKED

C2	6x6	PC6Z (S	S) ABU66	-									
	FOOTING SCHEDULE												
	FOOTING SCHEDULE												
MARK	TRANSVERSE SIZE (WIDTH) AND REINFORCEMENT	LONGITUDINAL SIZ (LENGTH) AND REINFORCEMENT	THICKNESS	REFERENCE/ NOTES									

SHEET TITLE:

BUILDING 3 -FOUNDATION / SECOND FLOOR FRAMING PLAN

PROJECT# 20162 ISSUE DATE: 10/14/2020 AUTHOR:

PLAN NOTES

1. SEE GSN's FOR ABBREVIATIONS AND SYMBOLS, AND MATERIAL GRADE REQUIREMENTS.

REFER TO ARCH DRAWINGS FOR ALL DIMENSIONS AND ALL ITEMS REQUIRED TO BE COORDINATED WITH THIS WORK, BUT NOT SHOWN ON THESE DRAWINGS.

REFER TO CIVIL AND MECH ENGINEERING DRAWINGS FOR EXTENT OF ALL STORM, WATER, SEWER PIPES, AND FOR PLACEMENT AND LOCATION OF ALL UNDER SLAB DRAINS AND DUCT

4. ALL FRAMING TO BE CENTERED ON WALLS, COLUMN, GRIDLINES,OR LOCATED AT EQUAL SPACES BETWEEN GRIDLINES, UNO.

KEYED NOTES

95' - 6" (9)

RIDGE /

23' - 9"

24' - 0"

23' - 9"

24' - 0"

DIAPHRAGM SHEATHING SCHEDULE
 MARK
 THICKNESS
 PANEL EDGE ATTACHMENT
 FIELD ATTACHMENT
 BLOCKING REQUIREMENT
 FASTENER REFERENCE/ NOTES

MARK	SIZE		SPACING	REF	ERENCE/ NOT	ES	
			JOIST SCHE	DULE			
						-	
S1	7/16"	8d AT 6" OC	8d AT 12" OC	UNBLOCKED	(1)	-	

SHEET TITLE:

BUILDING 3 - ROOF FRAMING PLAN

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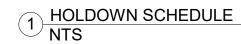
1 ROOF FRAMING PLAN 3/16" = 1'-0"

	HOLDOWN SCHEDULE											
MARK	HOLDOWN	WOOD MEMBER	WOOD FASTENER	ANCHOR BOLT	ANCHOR BOLT EMBEDMENT (IN)	COMMENTS						
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RECOMMENDATIONS.

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2 SHEAR WALL SCHEDULE NTS

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SHEARWALL / HOLD-DOWN SCHEDULE AND DETAILS

PROJECT # 20162 ISSUE DATE: 10/14/2020

S7.31

