OLYMPIA CREST III APARTMENTS

PROJECT TEAM

E: bobr@hatc.org

Housing Authority of Thurston County 1206 12th Avenue SE Olympia, WA 98501 Contact: Bob Ricks, Deputy Director T: 360-918-5819

MWA Architects 70 NW Couch Street, Suite 401 Portland, Oregon 97209 Contact: Chad Sanderson, AIA T: 503-416-8002 E: csanderson@mwaarchitects.com

ARCHITECTURAL

CIVIL

Gibbs & Olson 1157 3rd Avenue #219 Longview, WA 98632 Contact: Carol Ruiz, PE T: 360-425-0991 E: cruiz@gibbs-olson.com

LANDSCAPE

T: 503-224-1225

E: lmacdonald@mep-pc.com

MacDonald Environmental Planning 9020 SW Washington Square Road #410 Portland, OR 97223 Contact: Laurel Macdonald Bonnell, ASLA

STRUCTURAL

Interface Engineering 100 SW Main Street #1600 Portland, OR 97204 Contact: Jared Fischer, PE Contact: Thomas Phuong, PE T: 503-382-2732 E: jared@waypointwa.com E: thomasp@interfaceeng.com

NARRATIVE

OLYMPIA CREST III APARTMENTS IS THE DEVELOPMENT OF 28 UNITS OF MULTI-FAMILY AFFORDABLE HOUSING FOR THE HOUSING AUTHORITY OF THURSTON COUNTY. THIS PROJECT IS A CONTINUATION OF OLYMPIA CREST I, COMPLETED IN 1978, AND OLYMPIA CREST II, COMPLETED IN 2010, ON THE NEIGHBORING PROPERTY.

PHASE III CONSISTS OF 20 ONE-BEDROOM UNITS AND 8 TWO-BEDROOM UNITS IN A TOTAL OF THREE BUILDINGS ON A 1.43-ACRE SITE THAT BORDERS LILLY RD. THIS PROPERTY FALLS UNDER MS ZONING, BUT HAS BEEN REVISED VIA TEXT AMENDMENT TO PROVIDE MULTI-FAMILY AFFORDABLE HOUSING.

ABBREVIATIONS

ABV	ABOVE	LAV	LAVATORY
ACT	ACOUSTICAL CEILING TILE	LAV	LAVATORT
	ADJACENT	MAX	
ADJ ADJUST	ADJUSTABLE	MECH	MAXIMUM MECHANICAL
ADJUST AFF	ABOVE FINISH FLOOR	MECH MFR	MANUFACTURER
ALUM	ALUMINUM	MIN	MINIMUM
APT	APARTMENT	MTL	METAL
ARCH	ARCHITECT(URAL)	NIIO	NOT IN CONTRACT
AV	AUDIO VISUAL	NIC	NOT IN CONTRACT
20	DO 4 DD	NTS	NOT TO SCALE
BD	BOARD	00	ON OFNITED
BLDG	BUILDING	OC	ON CENTER
ВО	BOTTOM OF	OH	OPPOSITE HAND
		OPP	OPPOSITE
CG	CORNER GUARD	OSOI	OWNER SUPPLIED & OWNER INSTALLED
CH	CLOTHES HOOK	OSCI	OWNER SUPPLIED & CONTRACTOR
CJ	CONTROL JOINT		INSTALLED
CL	CENTER LINE		D 4 10 17
CLG	CEILING	PNT	PAINT
CLR	CLEAR	PL	PLATE
CMU	CONCRETE MASONRY UNIT	P-LAM	PLASTIC LAMINATE
CONC	CONCRETE	PLYWD	PLYWOOD
CONT	CONTINUOUS	PNL	PANEL
CONST	CONSTRUCTION	PREFIN	PREFINISHED
CPT	CARPET	PT	PRESSURE TREATED
CSCI	CONTRACTOR SUPPLIED & CONTRACTOR	PTD	PAPER TOWEL DISPENSER
	INSTALLED	_	DADUIG
	DOLUBU 5	R	RADIUS
DBL	DOUBLE	RB	RUBBER BASE
DEMO	DEMOLITION	REF	REFRIGERATOR
DIA	DIAMETER	REINF	REINFORCE
DIM	DIMENSION	REQ'D	REQUIRED
DN	DOWN	RM	ROOM
DS	DOWNSPOUT	RO	ROUGH OPENING
DR	DOOR		
DTL	DETAIL	SAM	SELF ADHESIVE MEMBRANE
DWG	DRAWING	SC	SOLID CORE
DWR	DRAWER	SCHED	SCHEDULE
		SD	SMOKE DETECTOR
EXIST	EXISTING	SF	SQUARE FEET
EA	EACH	SHT	SHEET
ELECT	ELECTRICAL	SHTG	SHEATHING
EQ	EQUAL	SIM	SIMILAR
EQUIP	EQUIPMENT	SOG	SLAB ON GRADE
EL/ELEV	ELEVATION	SPECS	SPECIFICATIONS
EXT	EXTERIOR	SS	STAINLESS STEEL
		STD	STANDARD
FACT	FACTORY FINISH	STL	STEEL
FEC	FIRE EXTINGUISHER CABINET	STRUCT	STRUCTURAL
FD	FLOOR DRAIN		
FDC	FIRE DEPARTMENT CONNECTION	T/TEMP	TEMPERED GLASS
FF	FINISH FLOOR	TO	TOP OF
FIN	FINISH	TOC	TOP OF CONCRETE
FLR	FLOOR	TOSR	TOP OF SINK RIM
FO	FACE OF	TOLS	TOP OF LOWER SHELF
FOC	FACE OF CONCRETE	TOW	TOP OF WALL
FOS	FACE OF STRUCTURE	TS	TUBE STEEL
FT	FEET	TYP	TYPICAL
GA	GAUGE	UNO	UNLESS NOTED OTHERWISE
GALV	GALVANIZED		
GC	GENERAL CONTRACTOR	VCT	VINYL COMPOSITION TILE
GL	GLASS	VIF	VERIFY IN FIELD
GYP BD	GYPSUM BOARD	VERT	VERTICAL
			
HB	HOSE BIBB	W	WASHER
HC	HOLLOW CORE	W/	WITH
HM	HOLLOW METAL	WC	WATER CLOSET
HOR	HORIZONTAL	WD	WOOD
HT	HEIGHT	WDW	WINDOW
		W/O	WITHOUT
INT	INTERIOR	WO	WHERE OCCURS
INSUL	INSULATION	WRB	WEATHER RESISTIVE BARRIER/
		· -	AIR BARRIER

AIR BARRIER

SHEET INDEX

GENERAL

G1.00	COVER SHEET
G2.00	ZONING AND SITE CODE PLAN
G3.00	ASSEMBLIES
DRA1.00	ARCHITECTURAL SITE PLAN
DRA1.10	SITE CONTEXT PLAN

Waypoint Engineering

601 Main Street #400

T: 360-635-6611

Vancouver, WA 98660

CIVIL

C0.0	LEGENDS, ABBREVIATIONS, & SHEET INDEX
C0.1	GENERAL NOTES
C1.0	EXISTING CONDITIONS PLAN
C1.1	EXISTING CONDITIONS PLAN
C2.0	SITE PREPARATION PLAN
C2.1	SITE PREPARATION DETAILS
C3.0	SITE & UTILITIES PLAN
C3.1	SITE DETAILS
C3.2	SITE DETAILS
C3.3	SEWER & WATER DETAILS
C3.4	WATER DETAILS
C3.5	WATER DETAILS
C4.0	STORM DRAINAGE & GRADING PLAN
C4.1	STORM DRAINAGE DETAILS
C4.2	STORM DRAINAGE DETAILS
C5.0	CHANNELIZATION PLAN
C5.1	CHANNELIZATION DETAILS


LANDSCAPE

TREE PRESERVATION PLAN
TREE PRESERVATION PLAN
HARDSCAPE PLAN
HARDSCAPE PLAN
HARDSCAPE PLAN
IRRIGATION PLAN
IRRIGATION PLAN
PLANTING PLAN
PLANTING PLAN DETAILS
STORMWATER PLANTING PLANS

ARCHITECTURAL

DRA2.11	BUILDING 1 GROUND/SECOND FLOOR PLANS
DRA2.21	BUILDING 2 GROUND/SECOND FLOOR PLANS
DRA2.31	BUILDING 3 GROUND/SECOND FLOOR PLANS
DRA4.11	BUILDING 1 ELEVATIONS
DRA4.12	BUILDING 2 ELEVATIONS
DRA4.13	BUILDING 3 ELEVATIONS

VICINITY MAP

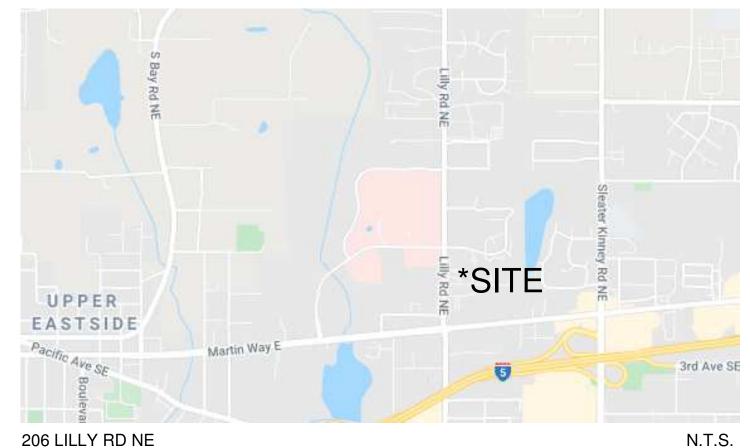



REVISION NO

OC-III

APARTMENTS

CONCEPT DESIGN REVIEW

204 LILLY RD NE

OLYMPIA, WA

95806

ISSUANCE

DATE

2/10/21

12" = 1'-0"

202010.00

DRAWN BY

PROJECT NUMBER

SCALE

mwa architects

SUITE 401


70 NW COUCH STREET


PORTLAND, OR 97209 P 503 973 5151 F 503 973 5060

MWAARCHITECTS.COM

SYMBOLS - ARCHITECTURAL

OLYMPIA, WA 98506

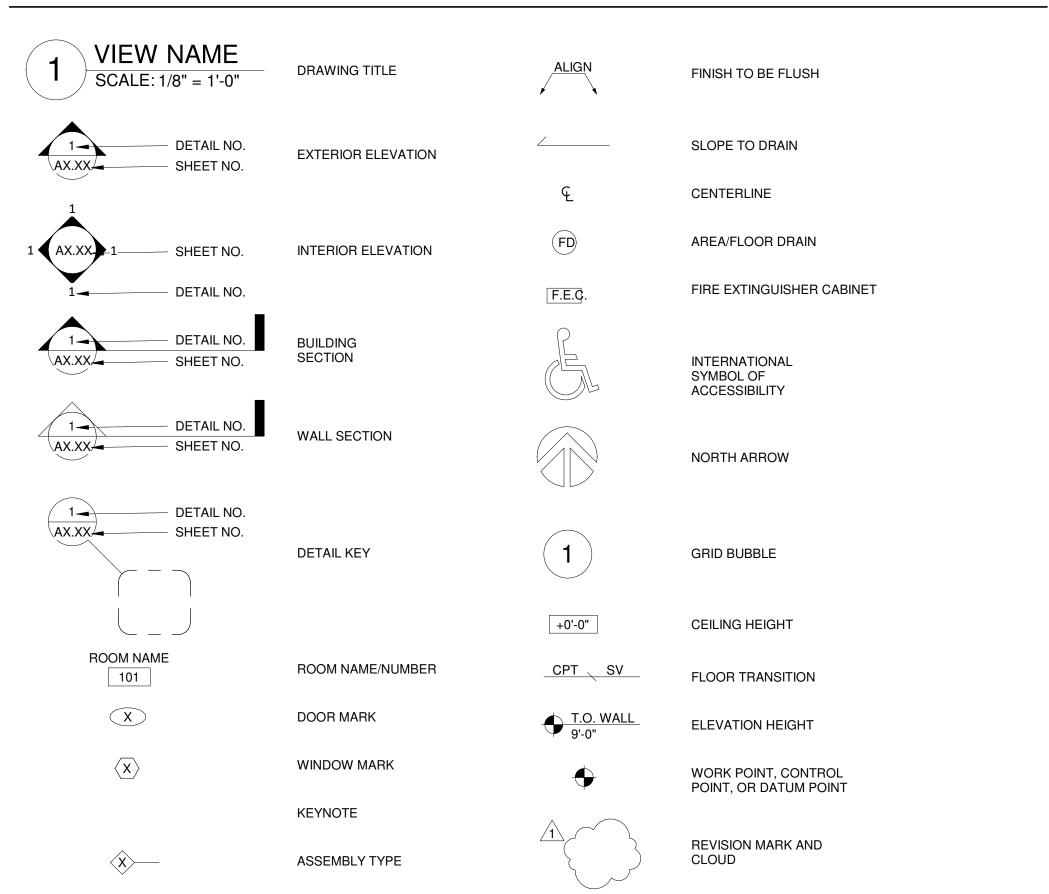

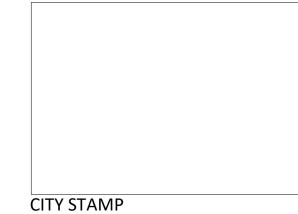

DRAWING TITLE COVER SHEET

SHEET NUMBER

ENERGY CODE REQUIREMENTS

INSULATION REQUIREMENTS PER 2019 OR ENERGY CODE (ASHRAE 90.1-2016) MULTNOMAH COUNTY ZONE 4C

PROVISIONS SHOWN ARE FOR RESIDENTIAL STRUCTURES

PROVISIONS SHOWN ARE FOR RESIDENTIAL STRUCTURES						
	REQ	JIRED	PROVIDED			
	ASSEMBLY MAXIMUM	MIN R VALUE				
ROOFS						
INSULATION ENTIRELY ABOVE DECK	U-0.032	R-30ci	Χ			
METAL BUILDING	U-0.037	R-19+R-11 Ls R-25+R-8 Ls	Х			
ATTIC AND OTHER	U-0.021	R-49	Χ			
WALLS ABOVE GRADE						
MASS	U-0.090	R-11.4ci	X			
METAL BUILDING	U-0.050	R-0+R-19ci	X			
STEEL FRAMED	U-0.064	R-13+R-7.5ci	X			
WOOD FRAME AND OTHER	U-0.064	R-13+R-3.8ci or R-20	X			
WALLS BELOW GRADE			Χ			
BELOW GRADE WALL	C-0.092	R-10ci	Χ			
FLOORS						
MASS	C-0.051	R-16.7ci	Χ			
STEEL JOIST	C-0.038	R-30	Χ			
WOOD FRAMED AND OTHER	C-0.033	R-30	X			
SLAB ON GRADE FLOORS						
UNHEATED	F-0.520	R-15 for 24"	X			
HEATED	F-0.668	R-20 for 48"	X			
OPAQUE DOORS						
SWINGING	U-0.370		X			
NON SWINGING	U-0.310		Χ			

VERTICAL FENESTRATIONS	REQUIRED			PROVIDED
	MAX U	MAX SHGC	MIN VT/SHGC	
NON METAL FRAMING - ALL	0.31	0.36	1.10	X
METAL FRAME - FIXED	0.38	0.36	1.10	Х
METAL FRAME - OPERABLE	0.46	0.36	1.10	Х
METAL FRAME - ENTRANCE DOORS	0.68	0.36	1.10	Х
SKYLIGHTS				X
ALL	0.50	0.40	0	Х

AIR BARRIER SYSTEM REQUIREMENTS

THE AIR BARRIER SYSTEM IS AN AIR TIGHT BUILDING ENCLOSURE AND IS COMPRISED OF MULTIPLE PRODUCTS THAT FORM A CONTINUOUS PATH THAT CONTROLS INFILTRATION OR EXFILTRATION OF AIR. ADDITIONAL DESCRIPTIONS AND SYSTEM REQUIREMENTS ARE AS FOLLOWS:

1. THE AIR TIGHT COMPONENTS OF THE BUILDING ENCLOSURE AND THE JOINTS, JUNCTURES AND TRANSITIONS BETWEEN MATERIALS, PRODUCTS AND ASSEMBLIES FORMING THE AIR TIGHTNESS OF THE BUILDING ENCLOSURE ARE CALLED THE "AIR BARRIER SYSTEM". SERVICES INCLUDE COORDINATION BETWEEN THE TRADES, THE PROPER SCHEDULING AND SEQUENCING OF THE WORK, AND PRECONSTRUCTION MEETINGS.

2. THE CONTRACTOR SHALL ENSURE THAT THE INTENT OF CONSTRUCTING THE BUILDING ENCLOSURE WITH A CONTINUOUS AIR BARRIER SYSTEM TO CONTROL AIR LEAKAGE, INTO OR OUT OF THE CONDITIONED SPACE IS ACHIEVED. THE AIR BARRIER SYSTEM SHALL HAVE THE FOLLOWING CHARACTERISTICS:

A. IT MUST BE CONTINUOUS, WITH ALL JOINTS SEALED.

B. IT MUST BE STRUCTURALLY SUPPORTED TO WITHSTAND POSITIVE AND NEGATIVE AIR PRESSURES APPLIED TO THE BUILDING ENCLOSURE.

C. CONNECTION SHALL BE MADE BETWEEN:
1. FOUNDATION AND WALLS

DUCT PENETRATIONS

2. WALLS AND WINDOWS/DOORS3. DIFFERENT WALL SYSTEMS4. WALL AND ATTIC ROOF/CEILING ASSEMBLY5. WALLS, FLOORS, AND ROOF AT UTILITY, PIPE AND

3. AIR BARRIER PENETRATIONS: ALL PENETRATIONS OF THE AIR BARRIER AND PATHS OF AIR INFILTRATION/EXFILTRATION SHALL BE SEALED.

4. AIR BARRIER TESTING: (1) AIR BARRIER TEST MUST BE PERFORMED AND SUBMITTED TO THE JURISDICTION HAVING AUTHORITY ONCE THE TEST IS COMPLETE; (2) IF TEST RESULTS EXCEED 0.4 CFM/FT2 AT 0.3 IN. WG IN ACCORDANCE WITH ASTM E779 THEN VISUALLY INSPECT AIR BARRIER AND SEAL NOTED SOURCES OF LEAKAGE; (3) SUBMIT A FOLLOW-UP REPORT TO JURISDICTION HAVING AUTHORITY NOTING CORRECTIVE MEASURES TAKEN.

ZONING DATA

ZONING CLAS	SSIFICAT	ION: MEDICAL SERVICE	E (MS)	
BASE ZONE:	MS - M	IEDICAL SERVICE		
PLAN OVERLAY	MS - M	EDICAL SERVICE		
OVERLAY ZONE	DESIG	N ZONE - D		
ALLOWED USES	FULL-SERVICE HEALTH CARE FACILITIES, COMPLEMENTARY HEALTH CARE FACILITIES, COMMERICAL SERVICES FOR MEDICAL USERS AND EMPLOYEES, HIGH DENSITY HOUSING NEAR MEDICAL FACILITIES TO HELP MEET THE NEEDS OF THOSE EMPLOYED THERE.			
STREET CLASSIFICATIONS	LILLY F	RD NE - MINOR ARTERIA	AL	
	FAR RE	QUIREMENTS		
MINIMUM FAR		REQUIRED	PROVIDED	
MINIMUM DENSITY CHAPTER 18.06, TABLE 6.02		18 UNITS / ACRE	28 TOTAL	
MAXIMUM DENSITY CHAPTER 18.06, TABLE 6.02		30 UNITS / ACRE	28 TOTAL	
L	OT SIZE	REQUIREMENTS		
MINIMUM LOT SIZE		7,200 SF	62,292 SF	
MAXIMUM LOT COVERAGE CHAPTER 18.06, TABLE 6.02		MAXIMUM - 50%	31,146 SF	
MINIMUM LOT WIDTH		80'	100'	
MINIMUM LOT DEPTH		NOT REGULATED	600'	
SETBAC	K STAN	DARD REQUIREMENTS		
FRONT YARD (WEST)		MAXIMUM - 10'-0"	10'-0"	
SIDE YARD (NORTH)		MINIMUM - 10'-0"	41'-5" - 54'-0"	
REAR YARD (EAST)		MINIMUM - 15'-0"	95'-3"	
SIDE YARD (SOUTH)		MINIMUM - 10'-0"	15'-0"	
•	OTHER F	REQUIREMENTS		
MAXIMUM LANDSCAPING AREA		60%	15% - 7,905 SF	
PARKING		1.5 SPACES / UNIT	1.25 / UNIT	
LONG-TERM BIKE PARKING SHORT-TERM BIKE PARKING		1 SPACE / UNIT 1 SPACE / 10 UNITS	1 SPACE / UNIT 2 SPACES / BLDG	
HEIGHT		75'-0"	27'-8"	

PARKING SUMMARY

	REQUIRED	PROVIDED
MINIMUM ON SITE PARKING	42 SPACES	38
STANDARD		25
ACCESSIBLE		2
COMPACT		11
MINIMUM BICYCLE PARKING	SEE BELOW	SEE BELOW
	1	L

1.5:1 RATIO IS REQUIRED, BUT A 10% REDUCTION IS ACCEPTABLE

SHORT TERM BIKE PARKING

CODE: 2 PER BUILDING X 3 = 6

BUILDING 1: OUTDOOR COVERED BIKE PARKING = 2 BUILDING 2: OUTDOOR COVERED BIKE PARKING = 2 BUILDING 3: OUTDOOR COVERED BIKE PARKING = 2

TOTAL SPACES PROVIDED: 6

LONG TERM BIKE PARKING

CODE: 1 PER UNIT X 28 = 28

1 BEDROOM: IN UNIT STORAGE = 20 2 BEDROOM: EXTERIOR STORAGE = 8

TOTAL SPACES PROVIDED: 28

GENERAL BUILDING INFO

BUILDING OWNER:

HOUSING AUTHORITY OF THURSTON COUNTY (HATC)

PERMIT APPLICANT:

HATC, MWA ARCHITECTS

PROJECT ADDRESS:

204 LILLY RD NE, OLYMPIA, WA 95806

SITE AREA:

1.43 ACRES

PARCEL NUMBER: 1.43 ACRES

1.43 ACRES

1.43 ACRES

SEISMIC ZONE: D

APPLICABLE CODES:

2018 INTERNATIONAL BUILDING CODE
(INCLUDES ADOPTION OF AND AMENDMENTS TO THE 2018)

INTERNATIONAL EXISTING BUILDING CODE AND ICC/ANSI A117.1-2009)

• 2018 INTERNATIONAL MECHANICAL CODE (IMC) W STATE AMENDMENTS

2018 INTERNATIONAL FIRE CODE (IFC) W STATE AMENDMENTS
 2018 UNIFORM PLUMBING CODE (UPC) W STATE AMENDMENTS

2018 UNIFORM PLUMBING CODE (UPC) W STATE AME
 2018 WASHINGTON STATE ENERGY CODE (WAC)

BUILDING DESCRIPTION

(3) TWO-STORY APARTMENT BUILDINGS WITH (20) 1 BEDRROM AND (8) 2 BEDROOM UNITS FOR (28) UNITS TOTAL.

BUILDING SIZE: FIRST FLOOR: SECOND FLOOR:
BUILDING 1: 2,922 SF
BUILDING 2: 4,298 SF
BUILDING 2: 3,959 SF

BUILDING 3: 4,206 SF BUILDING 3: 3,695 SF

TOTAL: 11,426 SF TOTAL: 10,315 SF

BUILDING USE: MULTI-FAMILY RESIDENTIAL HOUSING

BUIDING ADJACENCIES: MEDICAL OFFICES AND OLYMPIA CREST PHASES I & II

OCCUPANCY AND USE

CH 3 AND TABLE 1006.2.1

APPLICABLE OCCUPANCY CLASSIFICATION GROUPS: R-2: RESIDENTIAL

OCCUPANT LOAD SUMMARY (BUILDING 1)							
UNITS	LEVEL	AREA (SF)	FUNCTION (PER 1004.1.1)	OCCUPANT LOAD			
(4) 1BR	1	2,922	RESIDENTIAL	10			
(4) 1BR	2	2,661	RESIDENTIAL	10			

(6) 1BR 1 4,298 RESIDENTIAL 10	OCCUPANT LOAD SUMMARY (BUILDING 2)					
	UNITS	LEVEL	AREA (SF)		OCCUPANT LOAD	
(6) 1PD 0 0.0F0 PESIDENTIAL 10	(6) 1BR	1	4,298	RESIDENTIAL	10	
(0) IBN 2 3,959 RESIDENTIAL 10	(6) 1BR	2	3,959	RESIDENTIAL	10	

	OCCL	IPANT LOAD SU	MMARY (BUILDING 3)	
UNITS	LEVEL	AREA (SF)	FUNCTION (PER 1004.1.1)	OCCUPANT LOAD
(4) 2BR	1	4,206	RESIDENTIAL	10
(4) 2BR	2	3,695	RESIDENTIAL	10

CITY STAMP

muja architer

nwa architects
70 NW COUCH STREET
SUITE 401

PORTLAND, OR 97209



REVISION NO DAT

OC-III APARTMENTS

204 LILLY RD NE OLYMPIA, WA 95806

ISSUANCE CONCEPT DESIGN REVIEW DATE 2/10/21 SCALE

12" = 1'-0" PROJECT NUMBER 202010.00


DRAWN BY OS

DRAWING TITLE

ZONING AND
SITE CODE
PLAN

SHEET NUMBER

G2.00

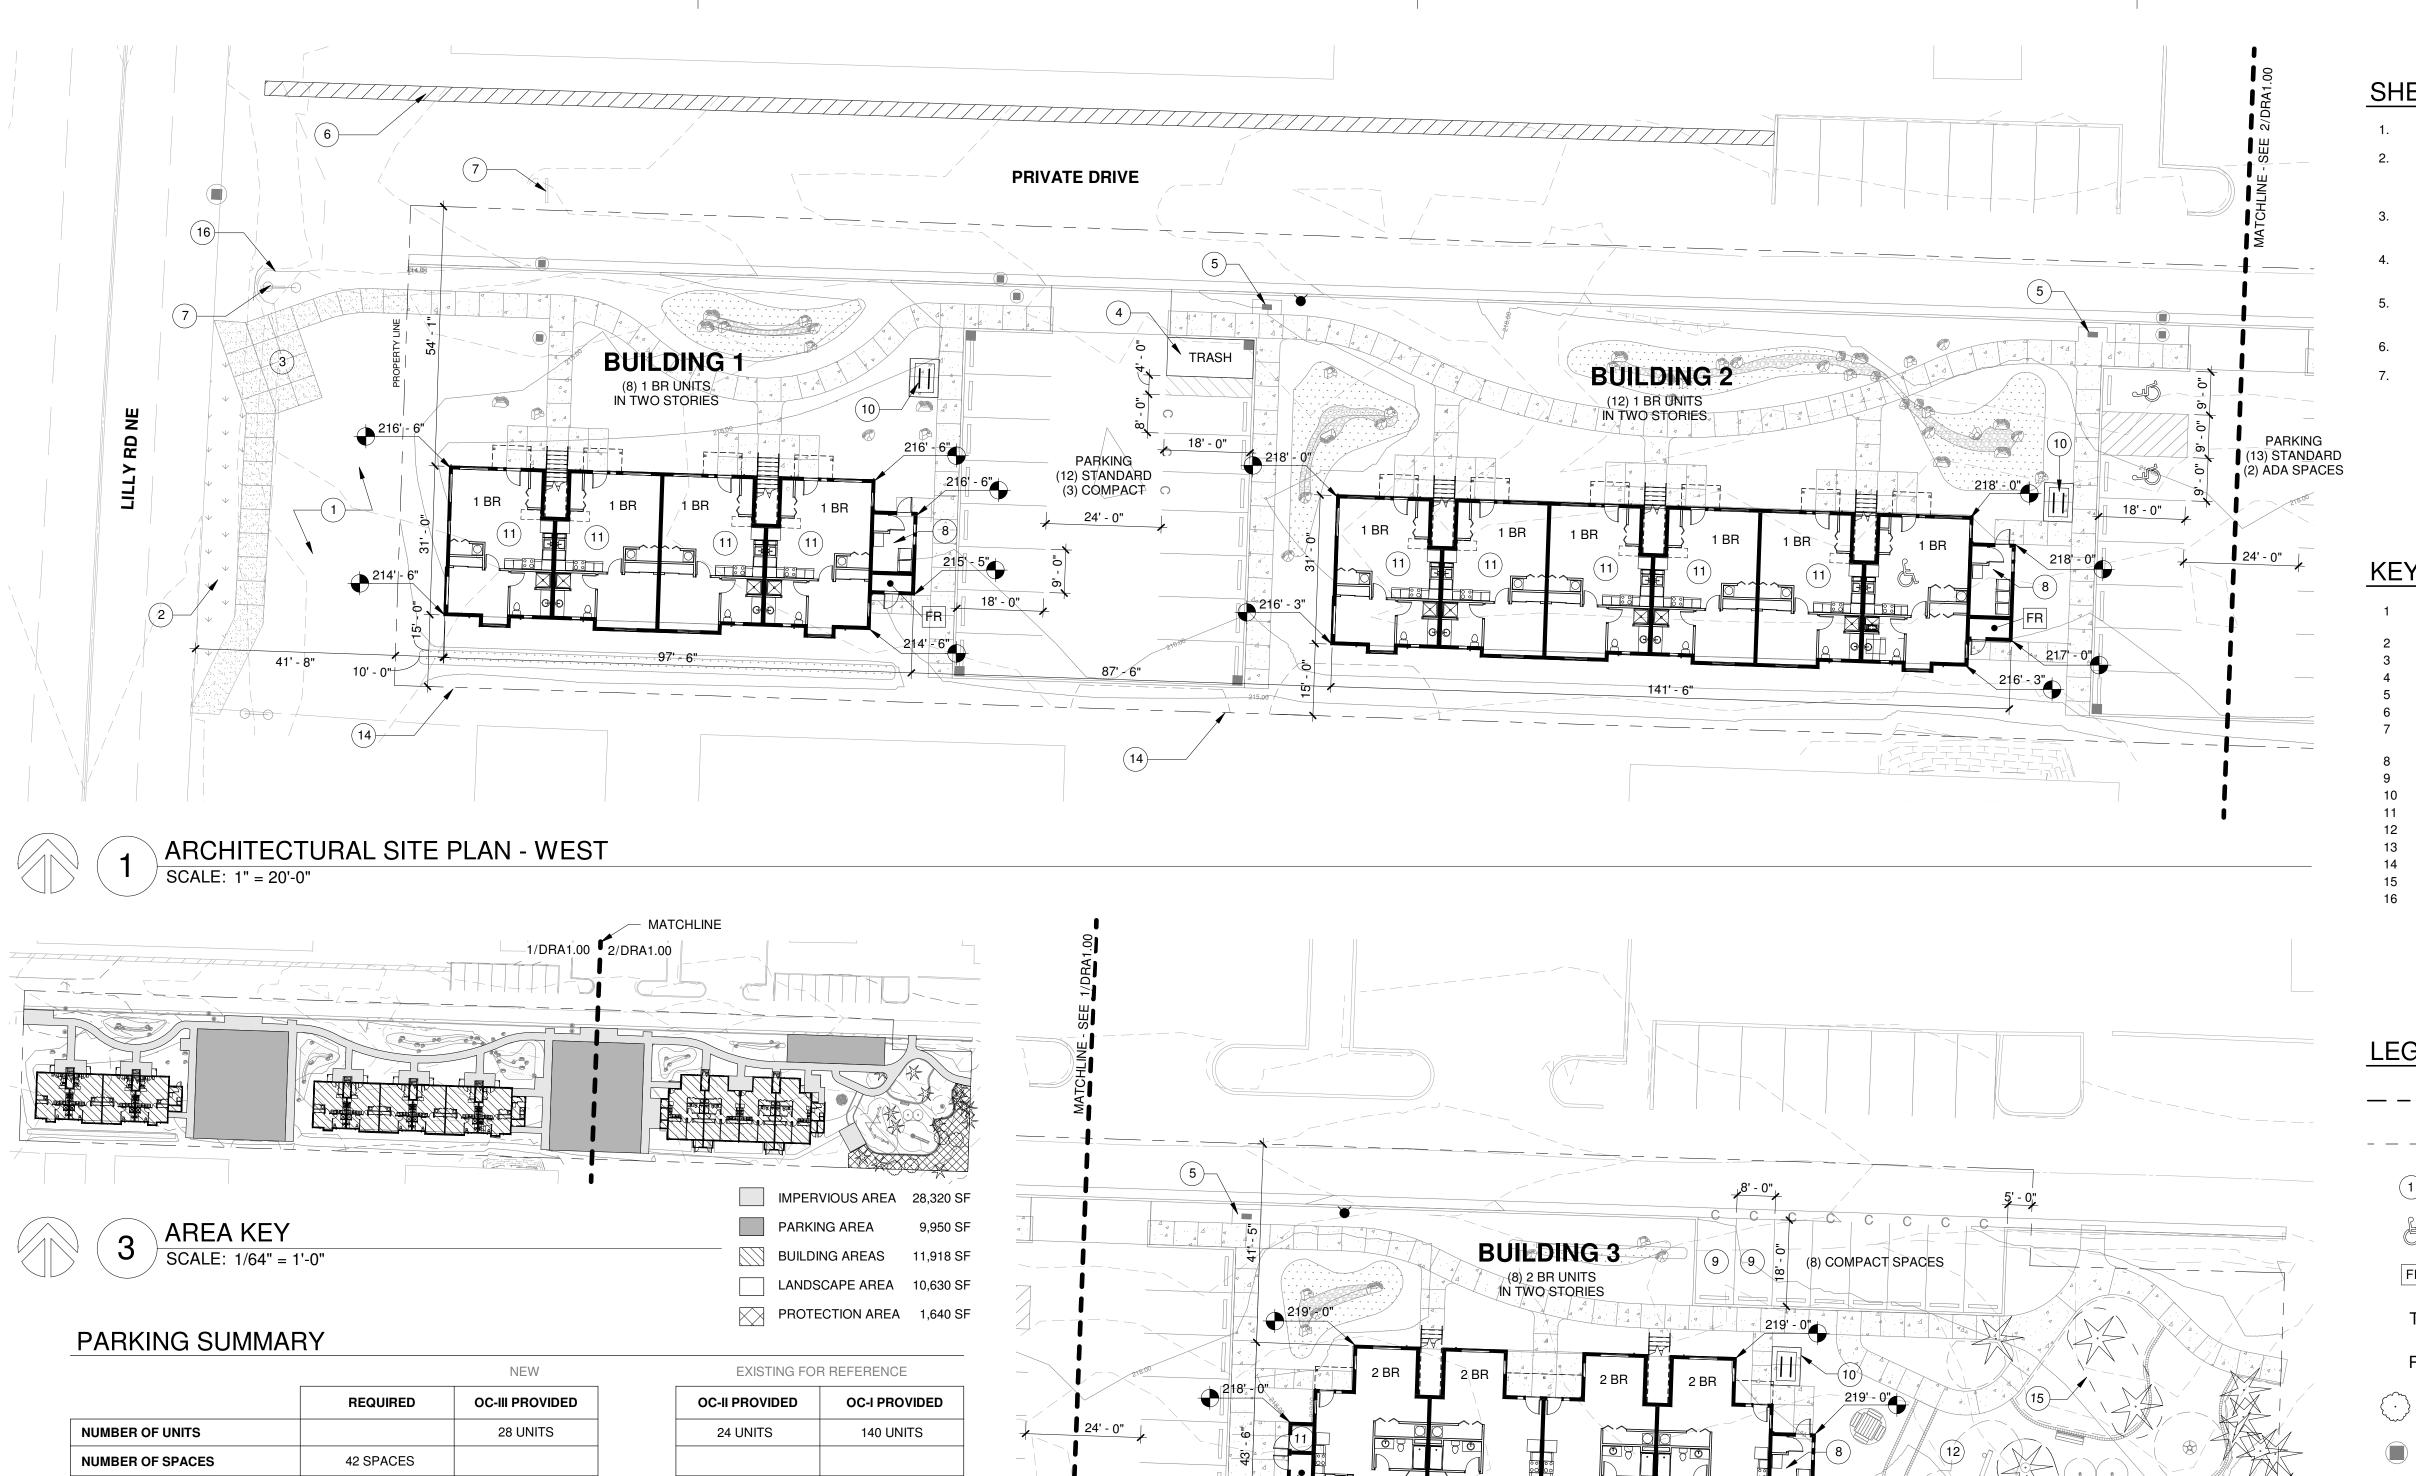

		NEW
	REQUIRED	OC-III PROVIDED
NUMBER OF UNITS		28 UNITS
NUMBER OF SPACES	42 SPACES	
STANDARD SPACES		25
ACCESSIBLE SPACES		2
COMPACT SPACES		11
TOTAL SPACES		38 SPACES

1.5: 1 RATIO IS REQUIRED, BUT A 10% REDUCTION IS ACCEPTABLE

TREES FOR RETENTION


SPECIES	DIAMETER	NUMBER OF TREES	POTENTIAL TREE UNITS
PACIFIC MADRONE	4"	1	1
	6"	2	2
DOUGLAS FIR	12"	3	3
	14"	2	3
	18"	1	4
	20"	4	20
	22"	2	12
	24"	2	14
BIG LEAF MAPLE	4"	1	1
WILLOW	6"	1	1
WESTERN RED CEDAR	14"	1	3
TOTALS		20 TREES	64 UNITS

SITE IS 1.43 ACRES - A MINIMUM OF 43 UNITS MUST BE RETAINED

ION AREA 1,640 S	F /
EFERENCE	
OC-I PROVIDED	_
140 UNITS	7
	_
223	_
VIF	
223 SPACES	

23

25 SPACES

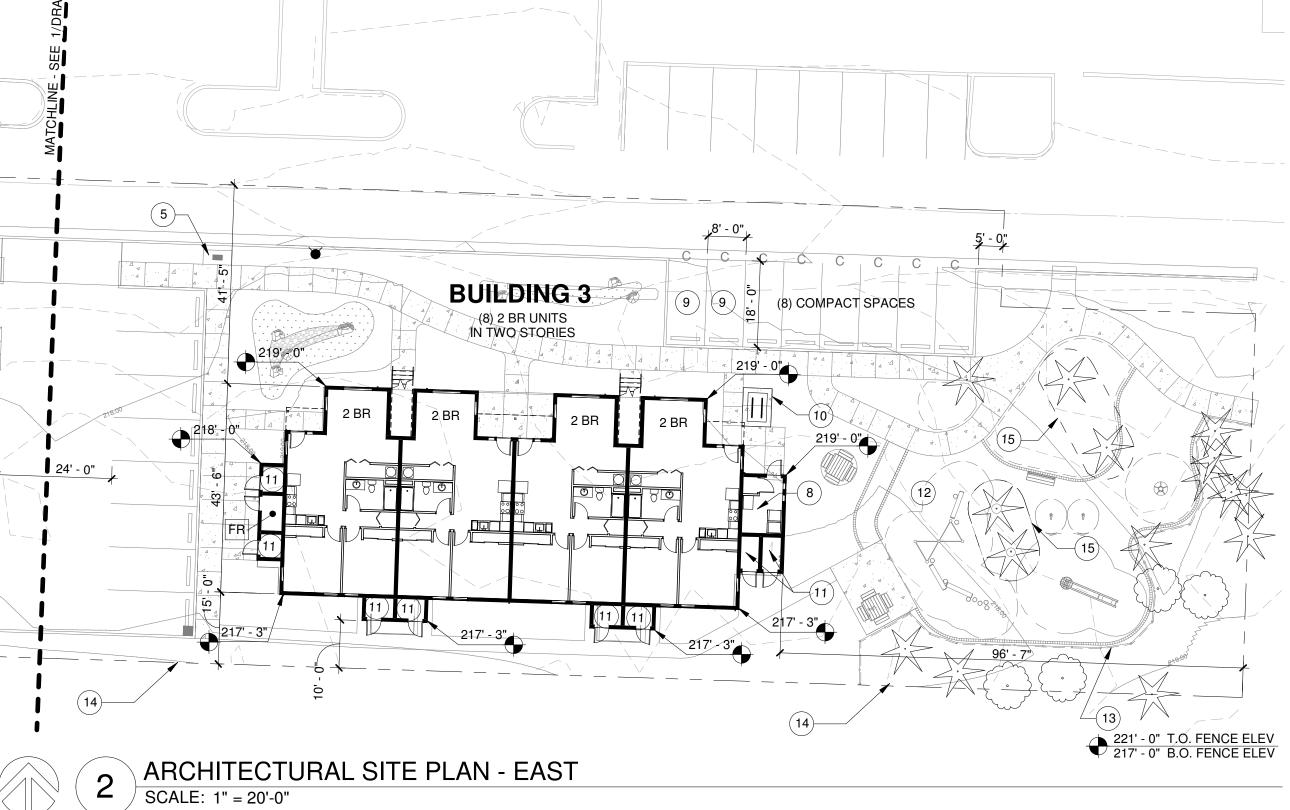

SHEET GENERAL NOTES

- PROPERTY LINE BASED ON SURVEY PROVIDED BY OWNER.
- SEE CIVIL DRAWINGS FOR UTILITY EASEMENT, SITE DIMENSIONS AT PARKING, SITE UTILITIES, GRADING, EROSION CONTROL, BUILDING PAD ELEVATIONS, AND RELATED DETAILS.
- SEE LANDSCAPE DRAWINGS FOR HARDSCAPE DIMENSIONS, PLANTING, AND IRRIGATION INFORMATION.
 - SEE CIVIL DRAWINGS FOR ACCESSIBILITY SITE RELATED
 - SITE LIGHTING AND SERVICE DISTRIBUTION TO BE BIDDER DESIGNED.
 - SEE CIVIL DRAWINGS FOR FIRE HYDRANT AND FDC LOCATIONS.
- DIMENSIONS AT BUILDINGS ARE TO FACE OF STUD.

KEYNOTES

- LANDSCAPING AND GRADING TO BE PROVIDED IN THE CITY
- RIGHT OF WAY
- ROW IMPROVEMENTS, SEE CIVIL SCHOOL BUS WAITING ZONE
- FENCED TRASH ENCLOSURE
- MAILBOXES AND RECYCLING
- EXISTING WALK PATH TO LILLY RD EXISTING SIGNAGE, COORDINATE RELOCATION WITH THE CITY
- IF REQUIRED SHARED LAUNDRY ROOM
- PROVIDE ELECTRIC VEHICLE CHARGING INFRASTRUCTURE
- COVERED AREA FOR SHORT-TERM BIKE PARKING
- STORAGE FOR LONG-TERM BIKE PARKING PLAY AREA, SEE LANDSCAPE
- SVPA, SEE LANDSCAPE FOR SPLIT RAIL FENCE
- EXISTING 6' CHAIN LINK TO 4.5' WOOD FENCE TO REMAIN TEMPORARY PROTECTION FENCE DURING CONSTRUCTION
- EXISTING 1' WIDE BLOCK RETAINING WALL

LEGEND

— — — PROPERTY LINE

- - - - CONTEXT LINE 100' FROM PROPERTY LINE

KEYNOTE

LOCATION OF ACCESIBLE PARKING SPACE/UNIT

FIRE RISER ROOM

TRASH LOCATION

RECYCLING LOCATION

EXISTING TREE TO REMAIN

STORM DRAIN LOCATION PER CIVIL

FIRE HYDRANT LOCATION PER CIVIL

CITY STAMP

2/10/21 SCALE As indicated PROJECT NUMBER

202010.00 DRAWN BY

OC-III

APARTMENTS

CONCEPT DESIGN REVIEW

204 LILLY RD NE

OLYMPIA, WA

95806

ISSUANCE

DATE

DRAWING TITLE

ARCHITECTURAL SITE PLAN

mwa architects

SUITE 401

REVISION NO


F 503 973 5060 MWAARCHITECTS.COM

70 NW COUCH STREET

PORTLAND, OR 97209 P 503 973 5151

SHEET NUMBER

DRA1.00

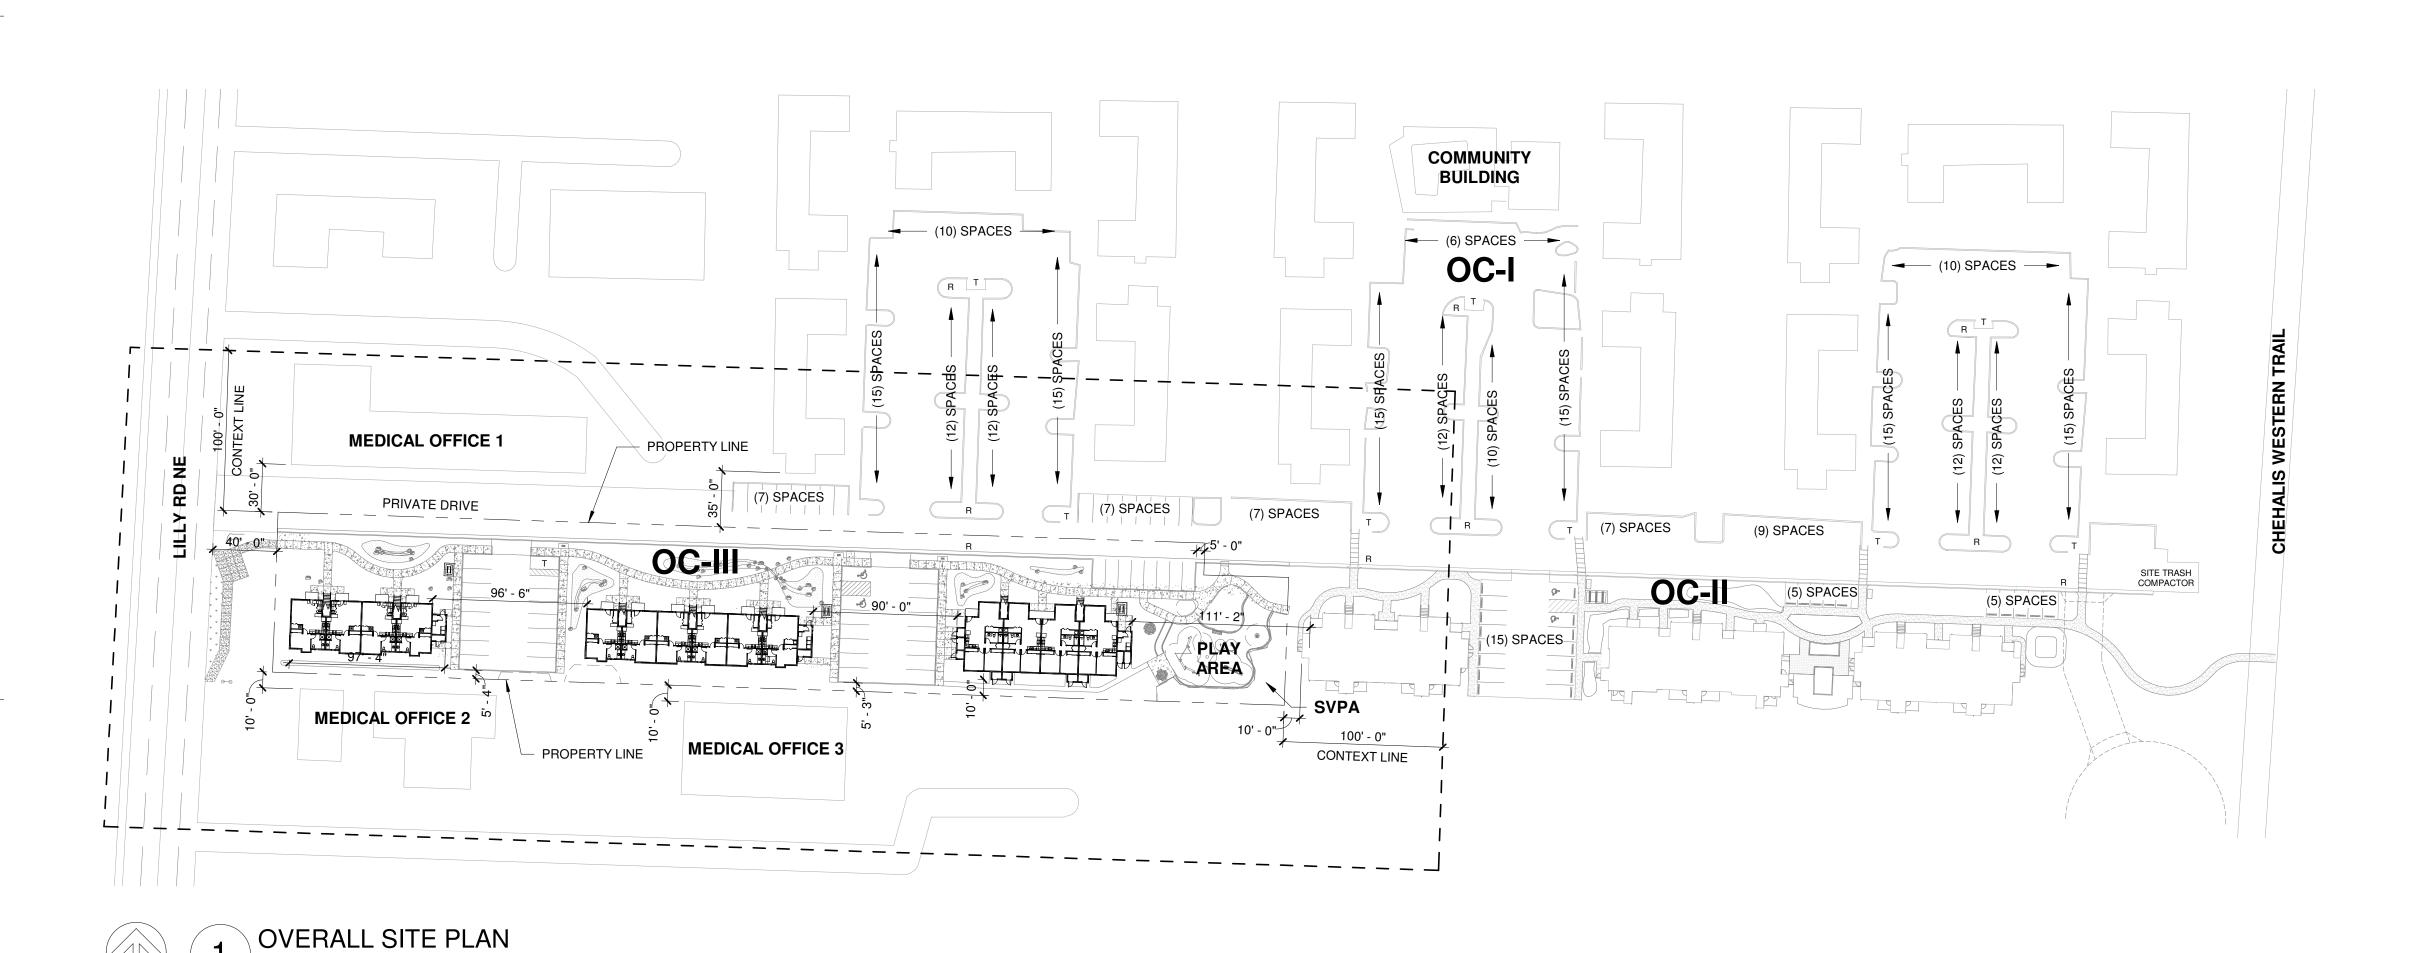











MEDICAL OFFICE 3





OC-I (1978)







OC-II (2010)

SHEET GENERAL NOTES

- PROPERTY LINE BASED ON SURVEY PROVIDED BY OWNER.
- SEE CIVIL DRAWINGS FOR UTILITY EASEMENT, SITE DIMENSIONS AT PARKING, SITE UTILITIES, GRADING, EROSION CONTROL, BUILDING PAD ELEVATIONS, AND RELATED DETAILS.
- SEE LANDSCAPE DRAWINGS FOR HARDSCAPE DIMENSIONS, PLANTING, AND IRRIGATION INFORMATION.
- SEE CIVIL DRAWINGS FOR ACCESSIBILITY SITE RELATED
- SITE LIGHTING AND SERVICE DISTRIBUTION TO BE BIDDER DESIGNED.
- SEE CIVIL DRAWINGS FOR FIRE HYDRANT AND FDC LOCATIONS.
- DIMENSIONS AT BUILDINGS ARE TO FACE OF STUD.

KEYNOTES

LEGEND

— − − − PROPERTY LINE

- - - - CONTEXT LINE 100' FROM PROPERTY LINE

KEYNOTE

LOCATION OF ACCESIBLE PARKING SPACE/UNIT

FIRE RISER ROOM

TRASH LOCATION

EXISTING TREE TO REMAIN

STORM DRAIN LOCATION PER CIVIL

RECYCLING LOCATION

FIRE HYDRANT LOCATION PER CIVIL

204 LILLY RD NE OLYMPIA, WA 95806

APARTMENTS

OC-III

REVISION NO

mwa architects

SUITE 401

F 503 973 5060 MWAARCHITECTS.COM

70 NW COUCH STREET

PORTLAND, OR 97209 P 503 973 5151

ISSUANCE CONCEPT DESIGN REVIEW DATE

2/10/21

SCALE

As indicated PROJECT NUMBER

202010.00

DRAWN BY

DRAWING TITLE

SITE CONTEXT

PLAN

SHEET NUMBER

DRA1.10

2 EXISTING SITE ADJACENCIES

SCALE: 12" = 1'-0"







MEDICAL OFFICE 2











CITY STAMP

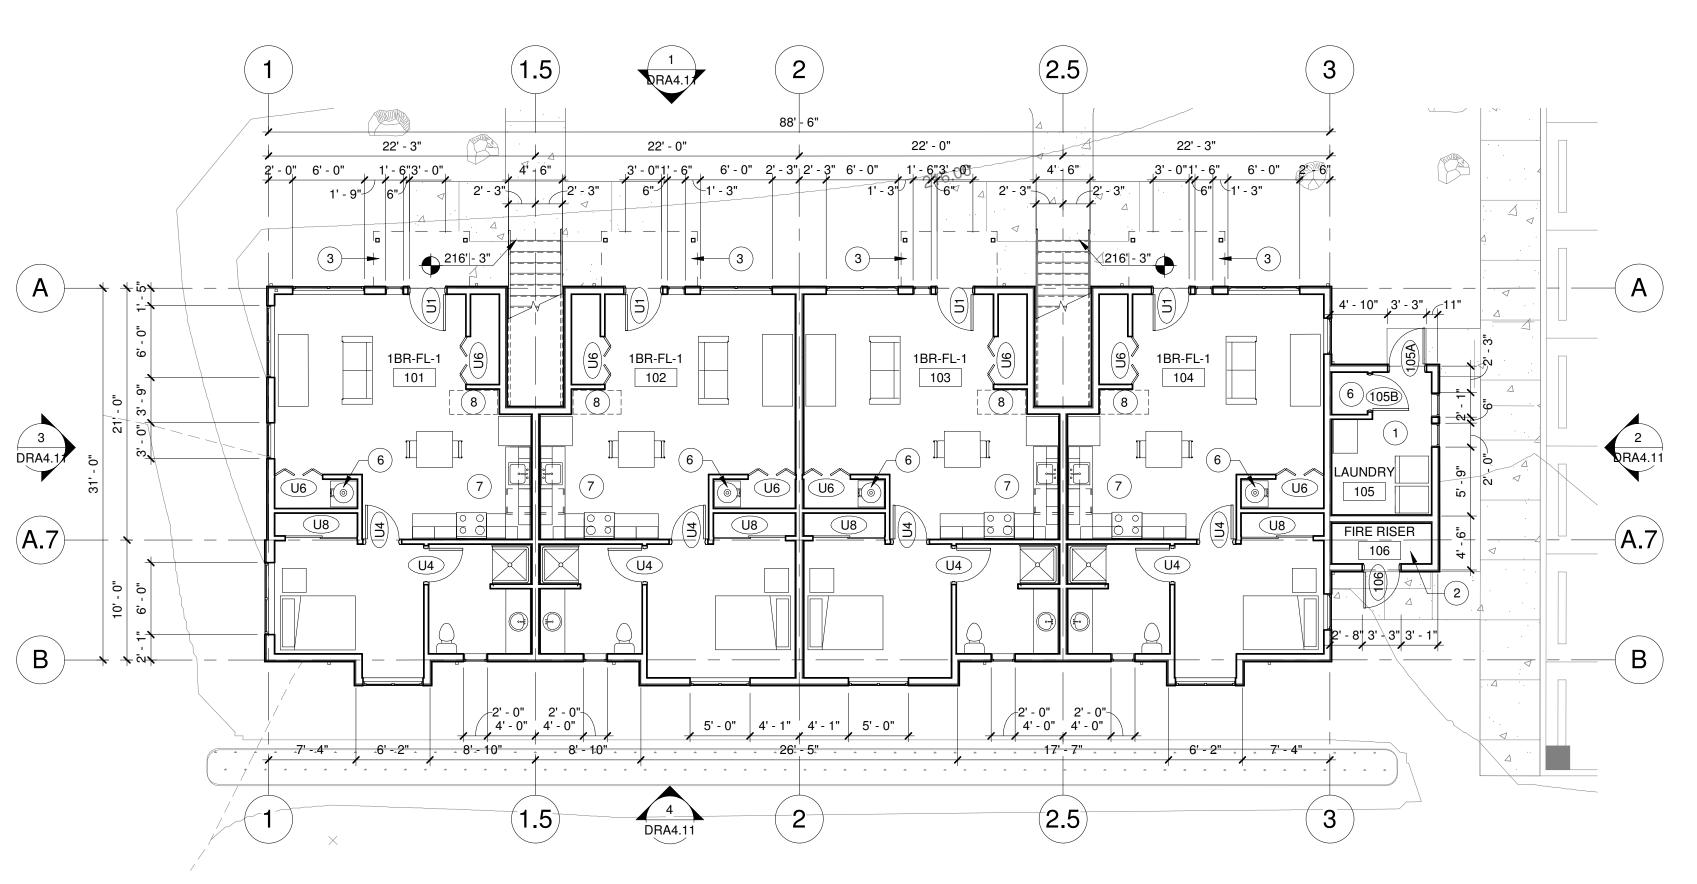

1 BUILDING 1 - GROUND FLOOR
SCALE: 1/8" = 1'-0"

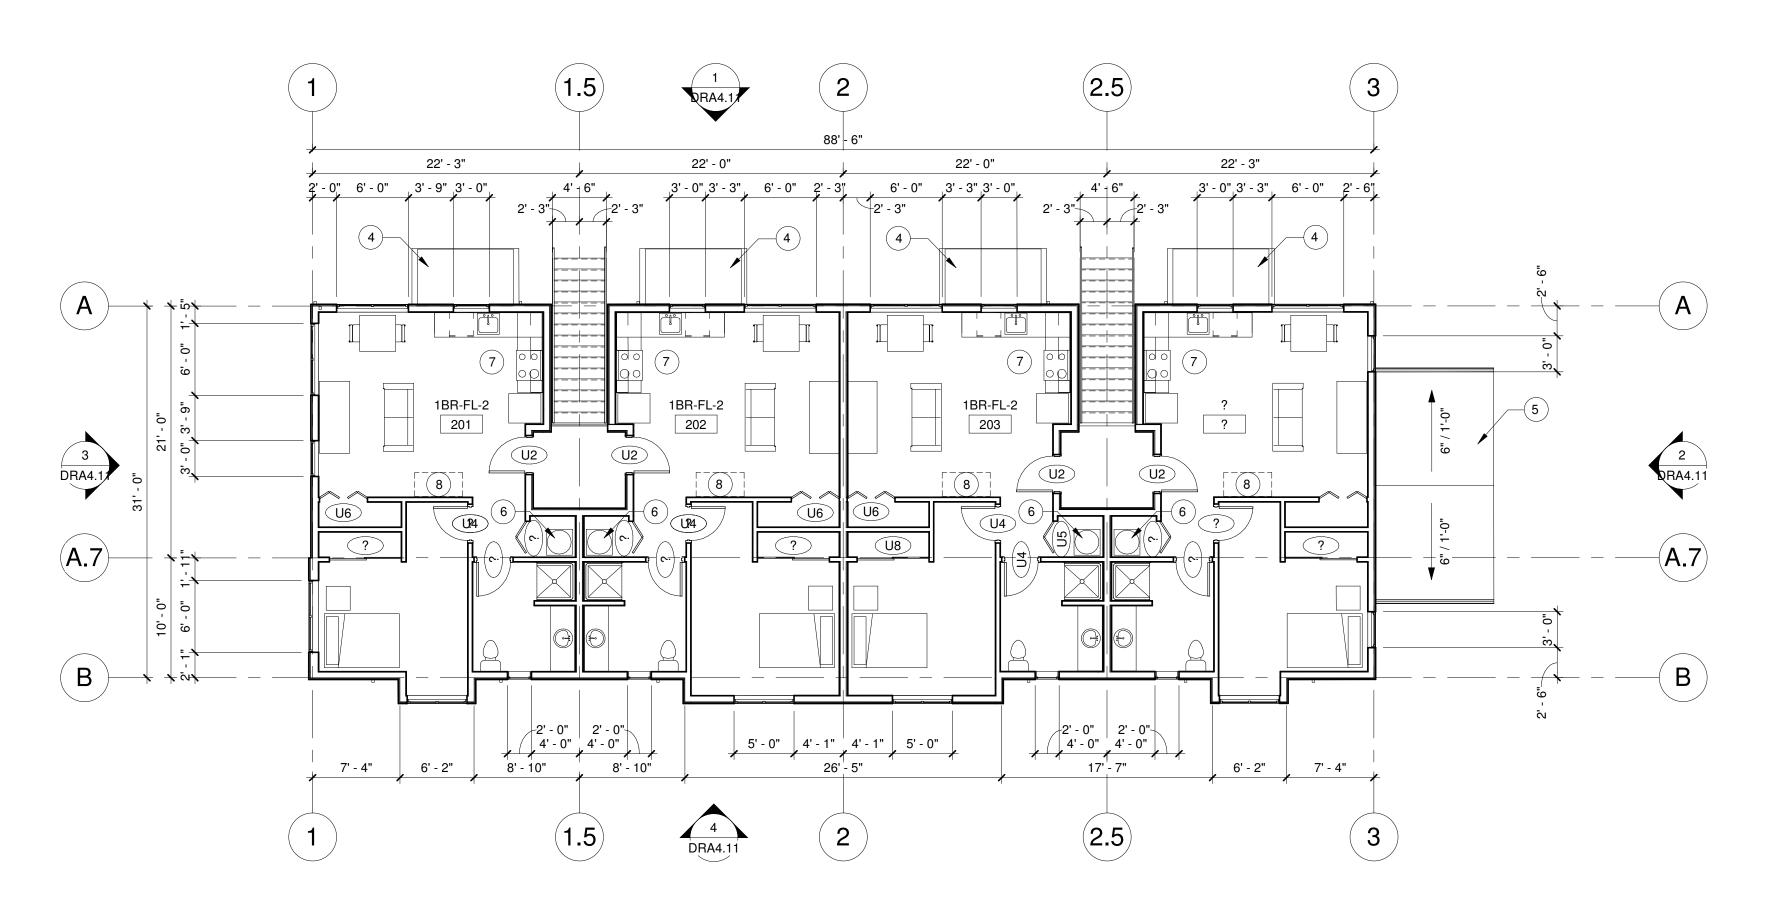

2 BUILDING 1 - SECOND FLOOR SCALE: 1/8" = 1'-0"

SHEET GENERAL NOTES

- 1. DIMENSIONS ARE TO GRID, FACE OF STUD, CONCRETE, CMU, AND CENTERLINE OF PARTY WALLS, COLUMNS, DOORS, AND WINDOWS, U.N.O.
- 2. SEE UNIT PLANS FOR ADDITIONAL WALL TYPE AND DIMENSION INFORMATION.
- 3. SEE ELEVATION SHEETS FOR SIDING PATTERNS AND MATERIALS.
- 4. MECHANICAL, ELECTRICAL, AND PLUMBING SUBCONTRACTORS TO COMPLY W/ FIRE BLOCKING AND FIRE STOPPING REQUIREMENTS AT ALL PENETRATIONS OR RATED WALL AND FLOOR/CEILING ASSEMBLIES.
- 5. SEE CODE PLANS FOR LOCATION OF FIRE RATED WALLS.
- 6. NOT ALL KEYNOTES OR LEGEND SYMBOLS USED ON EVERY SHEET.

Housing Author of Thurston Co

REVISION NO

mwa architects

SUITE 401

P 503 973 5151

F 503 973 5060 MWAARCHITECTS.COM

70 NW COUCH STREET

PORTLAND, OR 97209

KEYNOTES

- 1 SHARED LAUNDRY ROOM. MACHINES LEASED BY OWNER
- 2 FIRE RISER ROOM3 LINE OF CANOPY ABOVE
- 4 CANOPY BELOW
- 5 ROOF BELOW
- 6 WATER HEATER
 7 OWNER PROVIDED
- 7 OWNER PROVIDED REFRIGERATOR, STOVE, AND DISHWASHER

CITY STAMP

LONG-TERM BIKE STORAGE

1 1	=		ЛL	١
	— (-	: — [NH.)

1 KEYNOTE

OC-III APARTMENTS

204 LILLY RD NE OLYMPIA, WA 95806

ISSUANCE CONCEPT DESIGN REVIEW DATE 2/10/21

SCALE

As indicated
PROJECT NUMBER

202010.00 DRAWN BY


DRAWING TITLE


DRAWING TITLE

BUILDING 1
GROUND/SECOND
FLOOR PLANS

SHEET NUMBER

DRA2.11

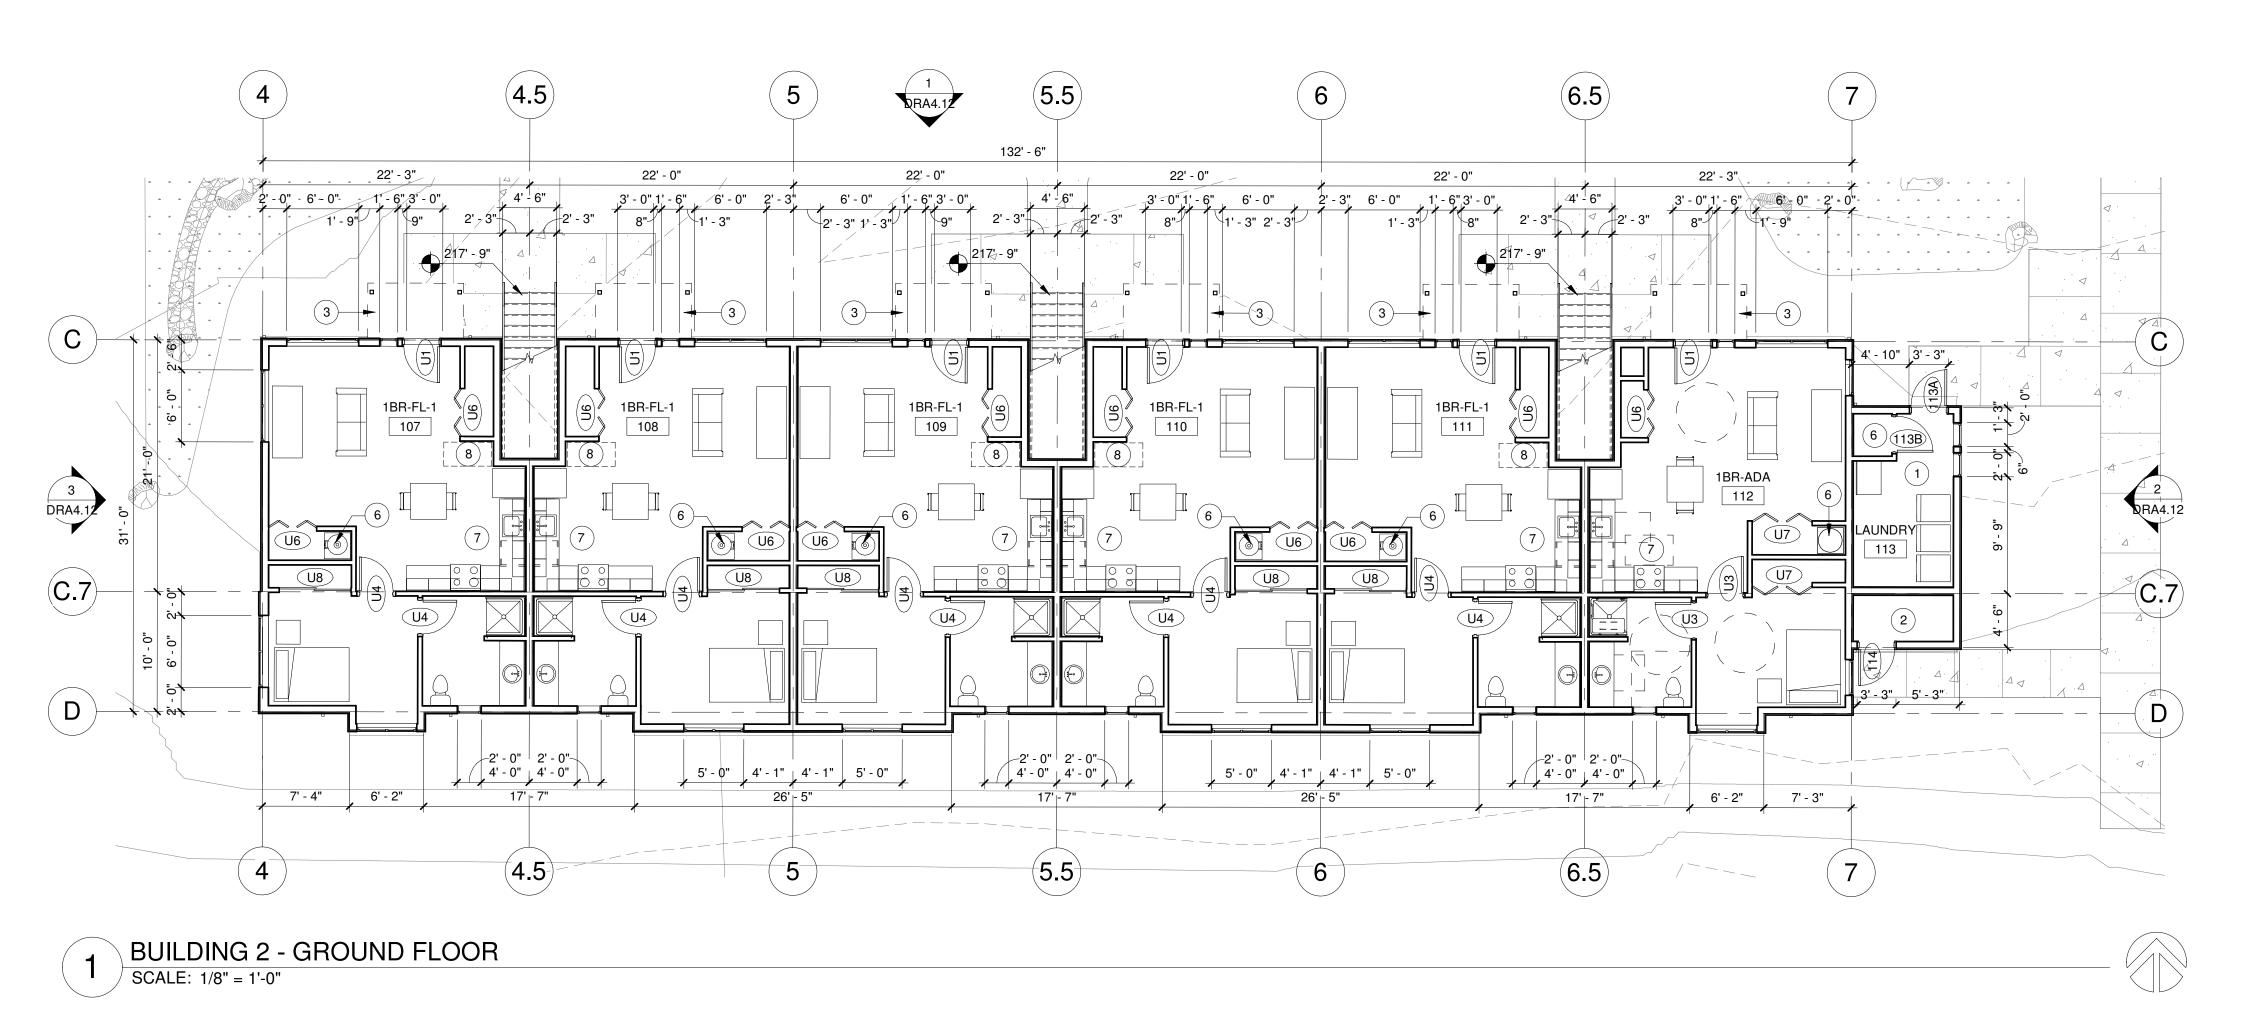

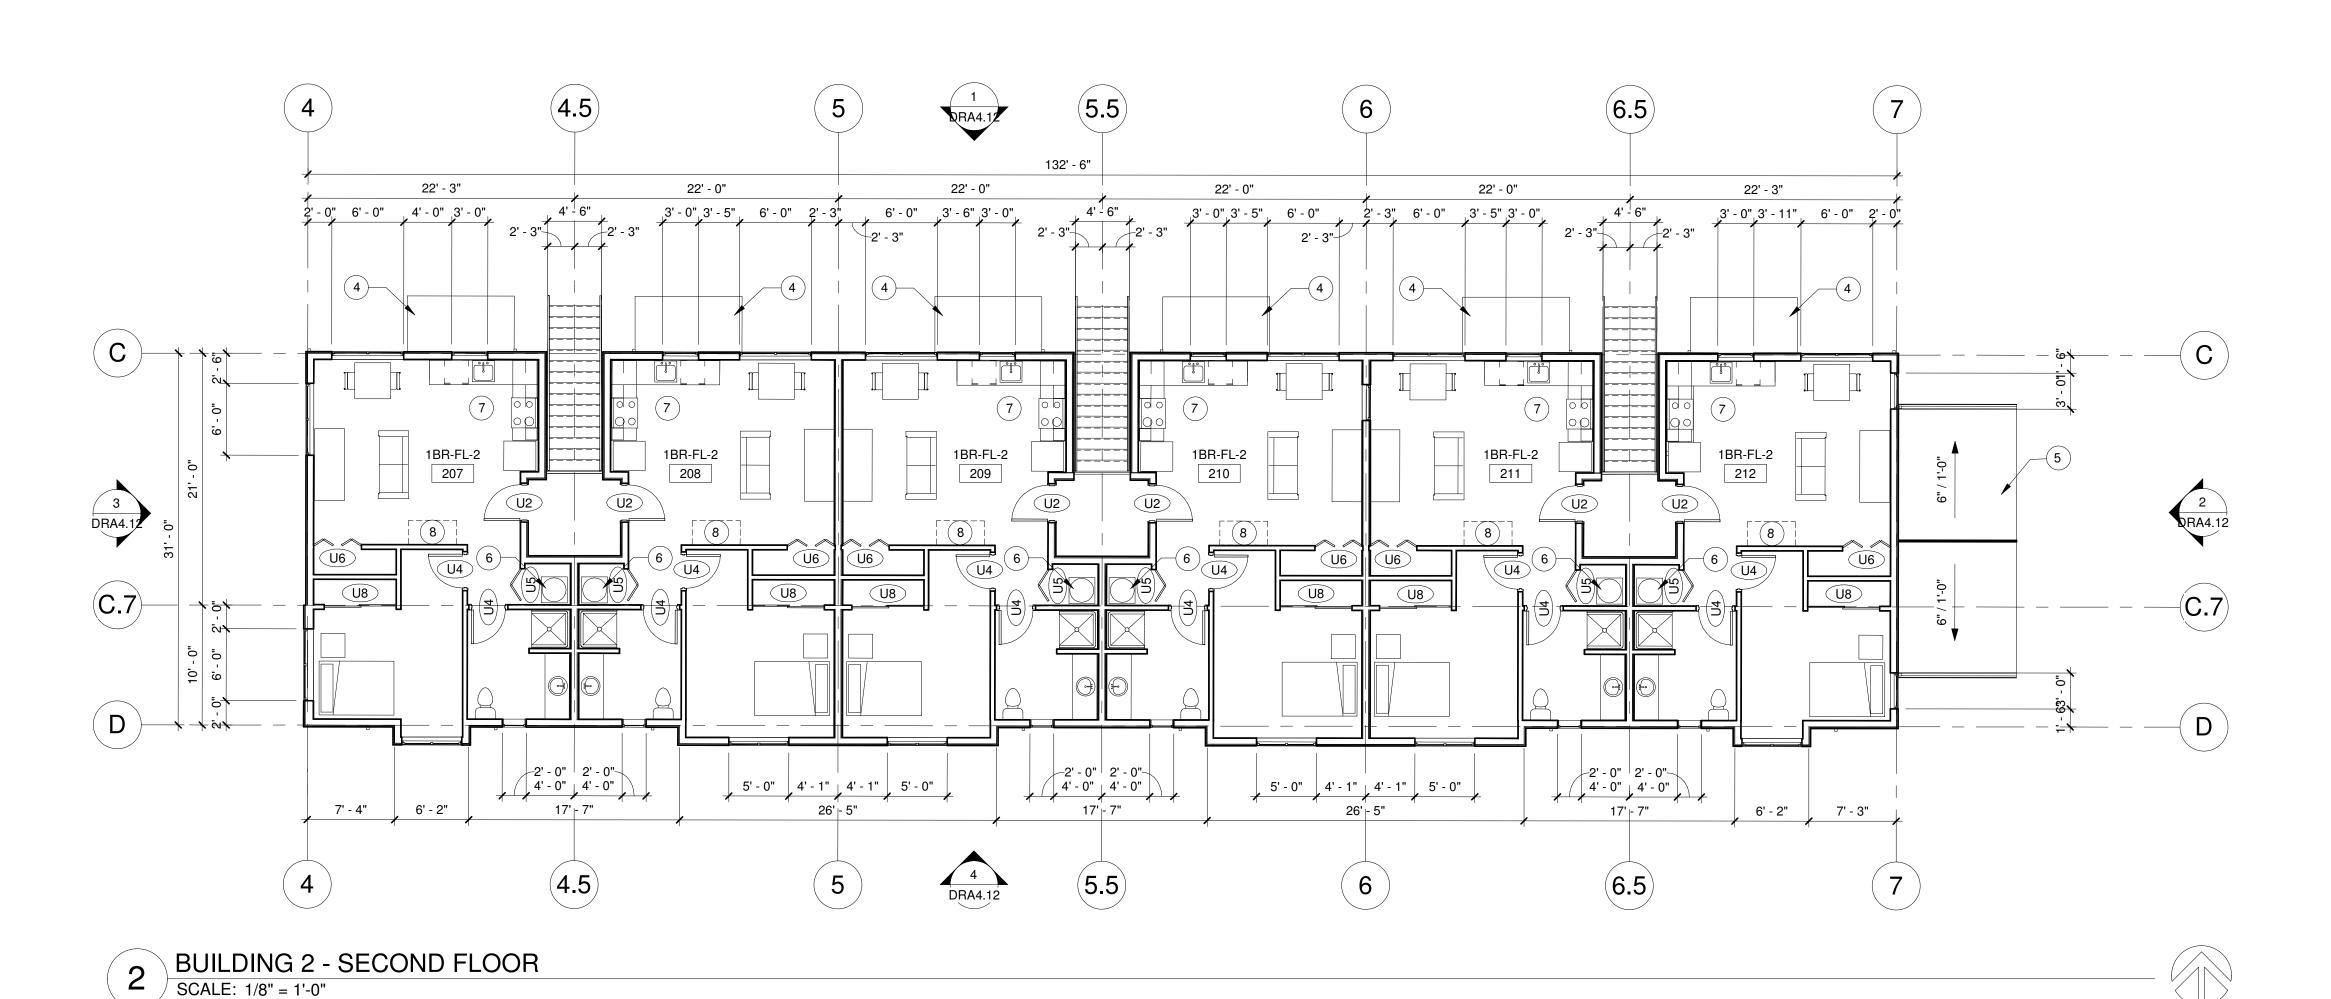

SHEET GENERAL NOTES

- 1. DIMENSIONS ARE TO GRID, FACE OF STUD, CONCRETE, CMU, AND CENTERLINE OF PARTY WALLS, COLUMNS, DOORS, AND WINDOWS, U.N.O.
- 2. SEE UNIT PLANS FOR ADDITIONAL WALL TYPE AND DIMENSION INFORMATION.
- SEE ELEVATION SHEETS FOR SIDING PATTERNS AND MATERIALS.
- 4. MECHANICAL, ELECTRICAL, AND PLUMBING SUBCONTRACTORS TO COMPLY W/ FIRE BLOCKING AND FIRE STOPPING REQUIREMENTS AT ALL PENETRATIONS OR RATED WALL AND FLOOR/CEILING ASSEMBLIES.
- 5. SEE CODE PLANS FOR LOCATION OF FIRE RATED WALLS.
- NOT ALL KEYNOTES OR LEGEND SYMBOLS USED ON EVERY SHEET.

KEYNOTES

- 1 SHARED LAUNDRY ROOM. MACHINES LEASED BY OWNER
- FIRE RISER ROOM LINE OF CANOPY ABOVE
- 4 CANOPY BELOW
- 5 ROOF BELOW
- 6 WATER HEATER
 - OWNER PROVIDED REFRIGERATOR, STOVE, AND DISHWASHER

CITY STAMP

LONG-TERM BIKE STORAGE

LEGEND

(1) KEYNOTE

OC-III
APARTMENTS

REVISION NO

mwa architects

SUITE 401

P 503 973 5151

F 503 973 5060 MWAARCHITECTS.COM

70 NW COUCH STREET

PORTLAND, OR 97209

204 LILLY RD NE OLYMPIA, WA 95806

ISSUANCE CONCEPT DESIGN REVIEW

DATE 2/10/21

SCALE

As indicated

PROJECT NUMBER

202010.00

DRAWN BY

OS


DRAWING TITLE

BUILDING 2
GROUND/SECOND

FLOOR PLANS

SHEET NUMBER

DRA2.21

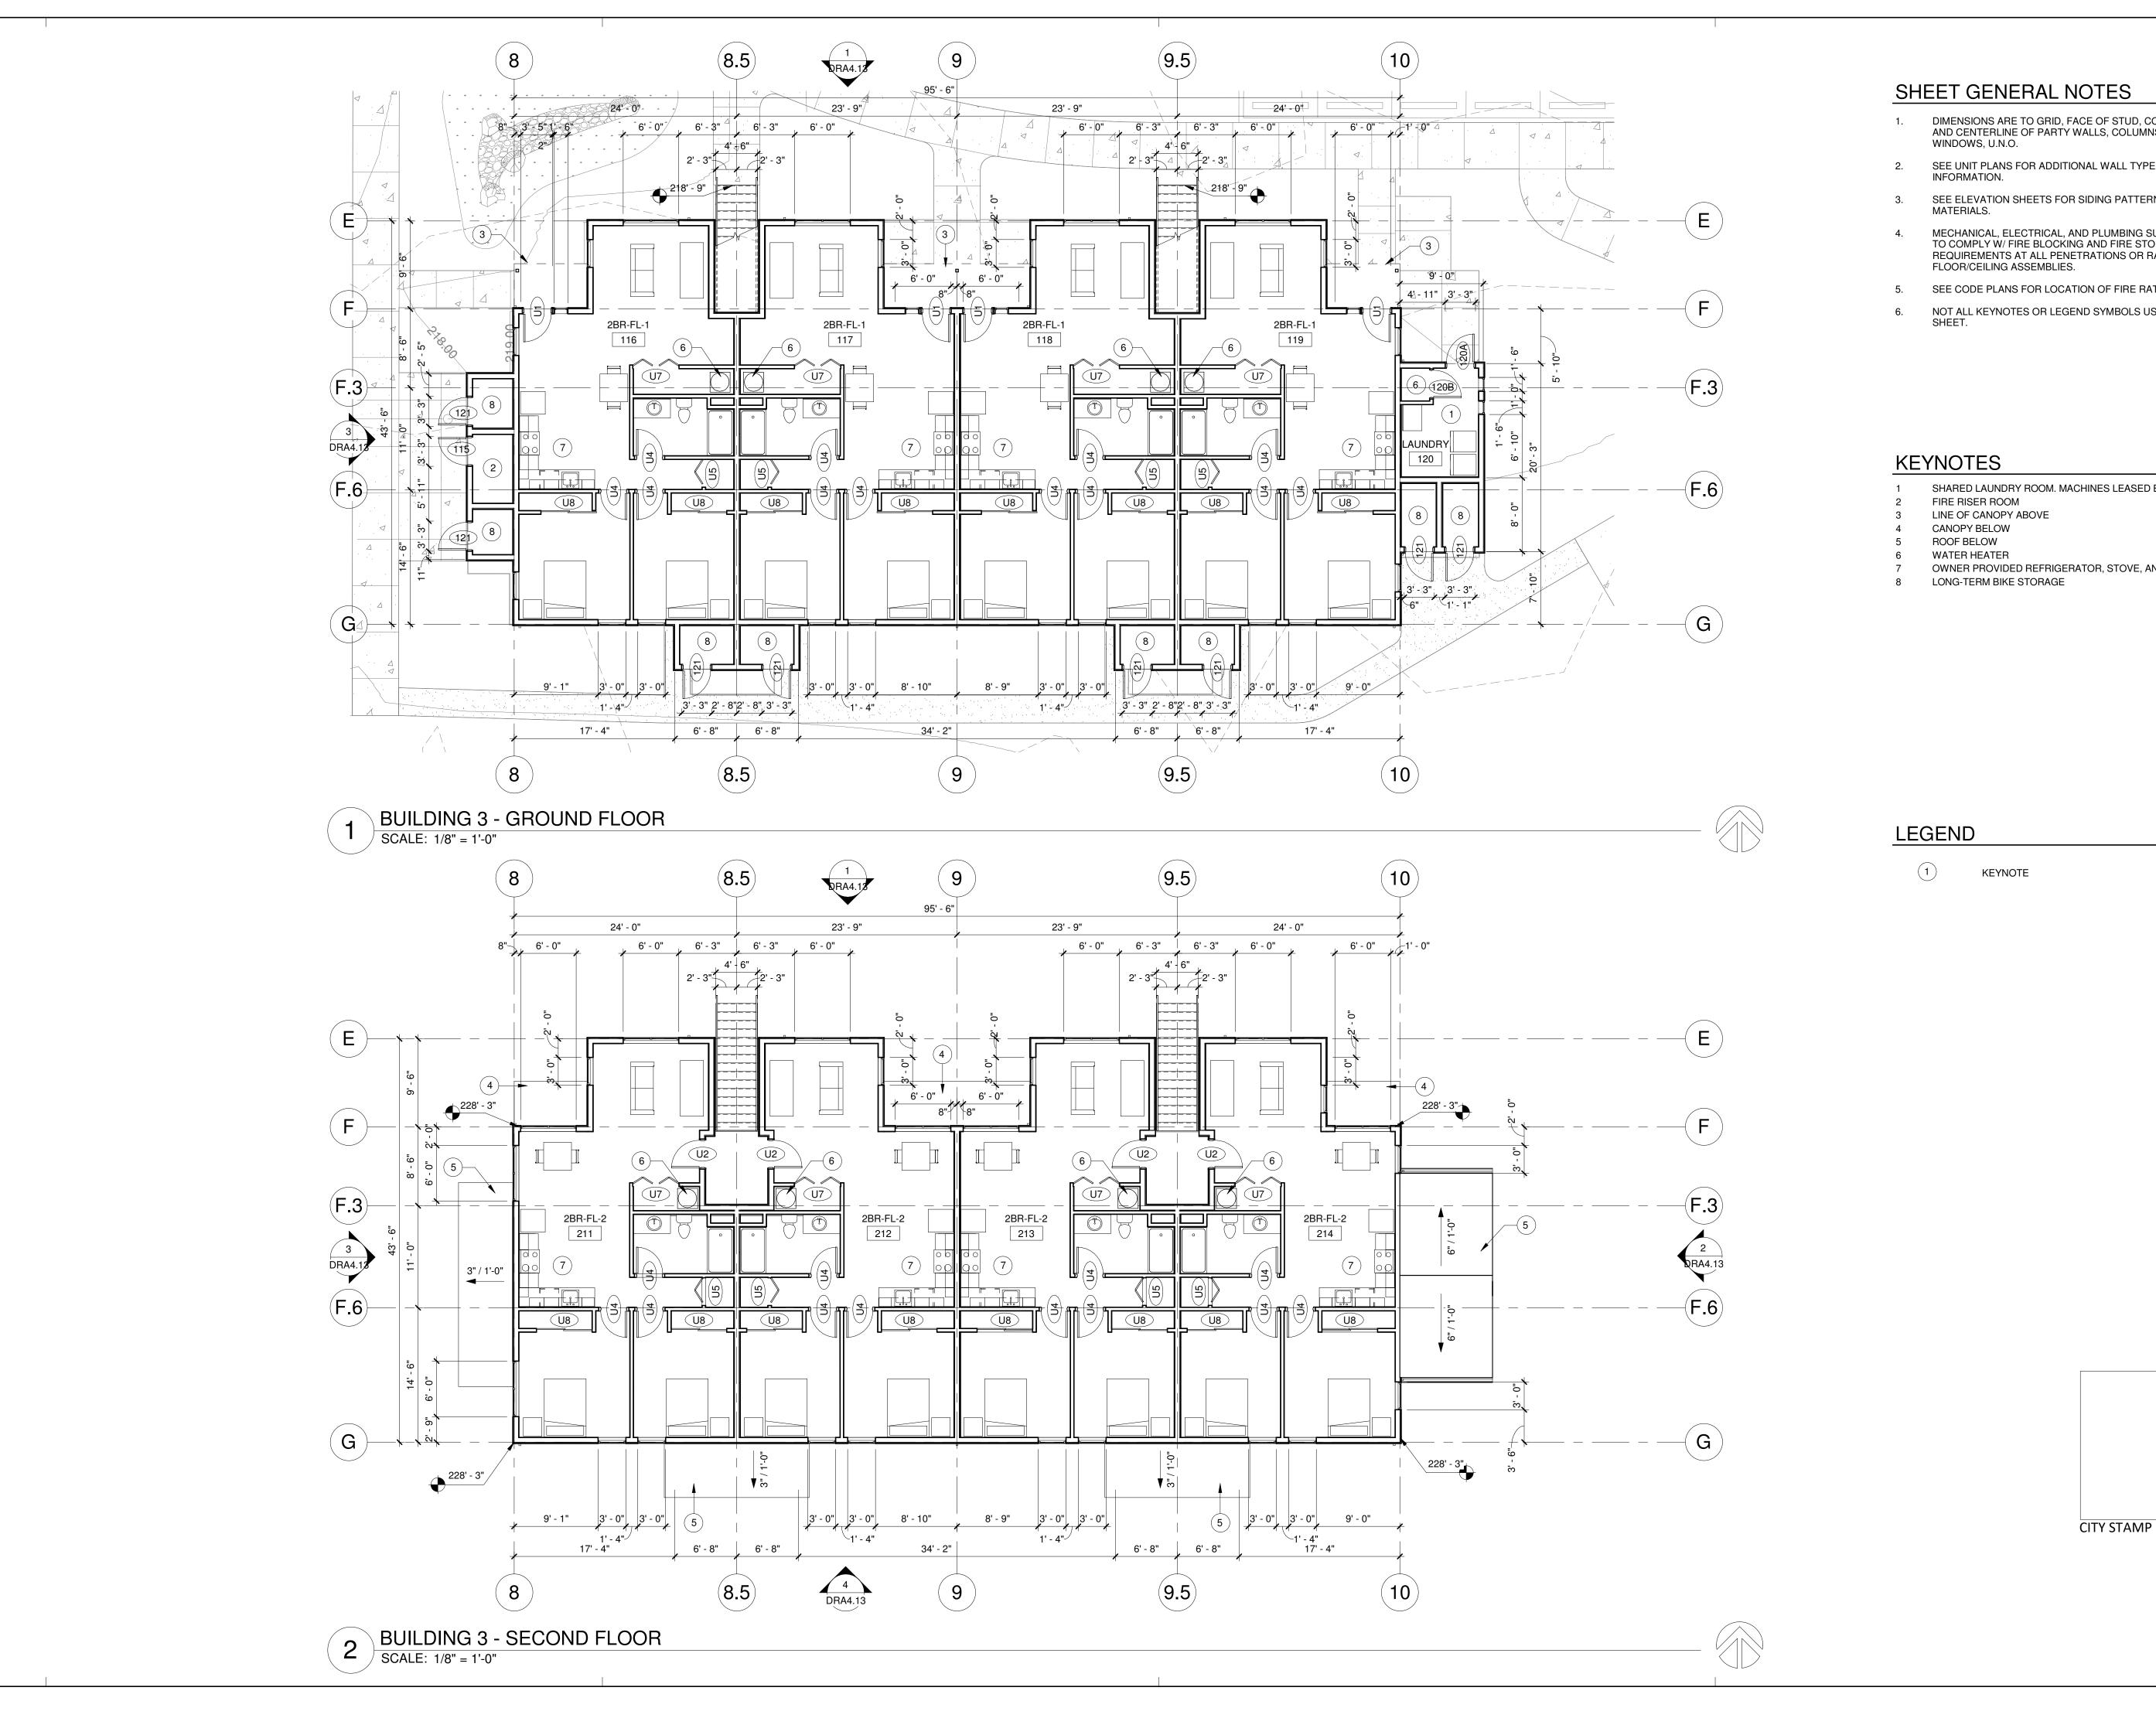

- DIMENSIONS ARE TO GRID, FACE OF STUD, CONCRETE, CMU, AND CENTERLINE OF PARTY WALLS, COLUMNS, DOORS, AND
- SEE UNIT PLANS FOR ADDITIONAL WALL TYPE AND DIMENSION
- SEE ELEVATION SHEETS FOR SIDING PATTERNS AND
- MECHANICAL, ELECTRICAL, AND PLUMBING SUBCONTRACTORS TO COMPLY W/ FIRE BLOCKING AND FIRE STOPPING REQUIREMENTS AT ALL PENETRATIONS OR RATED WALL AND
- 5. SEE CODE PLANS FOR LOCATION OF FIRE RATED WALLS.
- NOT ALL KEYNOTES OR LEGEND SYMBOLS USED ON EVERY



REVISION NO

mwa architects

SUITE 401

P 503 973 5151

F 503 973 5060 MWAARCHITECTS.COM

70 NW COUCH STREET

PORTLAND, OR 97209

- SHARED LAUNDRY ROOM. MACHINES LEASED BY OWNER
- OWNER PROVIDED REFRIGERATOR, STOVE, AND DISHWASHER

OC-III **APARTMENTS**

204 LILLY RD NE OLYMPIA, WA 95806

ISSUANCE CONCEPT DESIGN REVIEW

DATE 2/10/21 SCALE

| As indicated PROJECT NUMBER

202010.00

DRAWN BY

DRAWING TITLE

BUILDING 3 GROUND/SECOND


SHEET NUMBER

FLOOR PLANS

DRA2.31



B A.7 A A A A B BLDG 1 B.O. TRUSS 224'-0" BLDG 1 SECOND 225'-9" BLDG 1 GROUND 216'-6' B BLDG 1 GROUND 216'-6' C

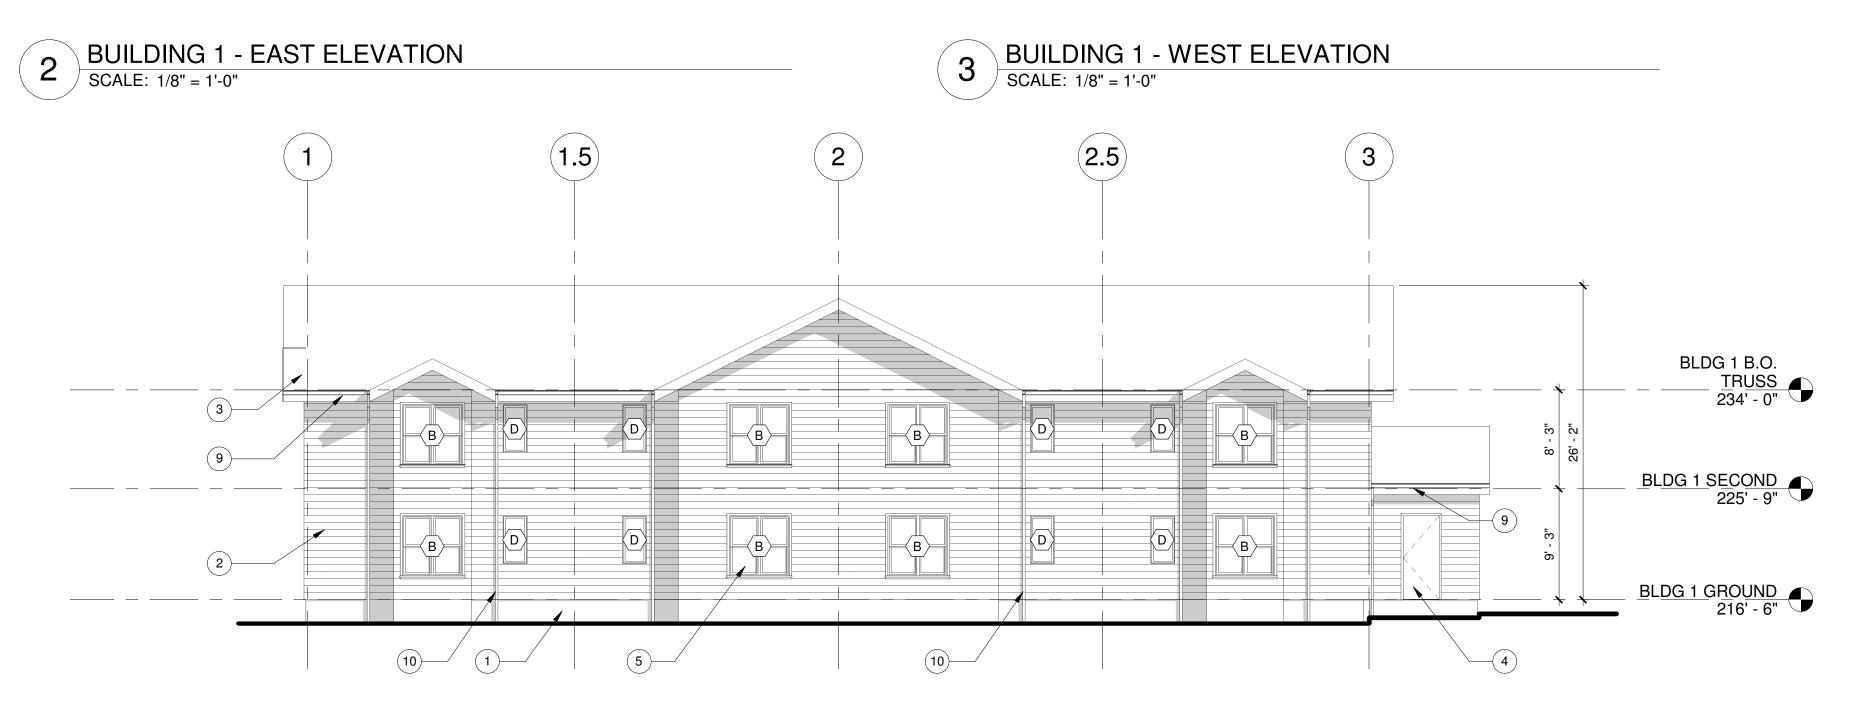



- DIMENSIONS ARE TO GRID, FACE OF STUD, CONCRETE, CMU, AND CENTERLINE OF PARTY WALLS, COLUMNS, DOORS, AND WINDOWS, U.N.O.
- 2. SEE ROOF PLAN FOR ROOF SLOPES.
- 3. SEE WINDOW SCHEDULE FOR WINDOW TYPES.
- 4. ALL EXHAUST VENTS TO BE A MINIMUM OF 3'-0" AWAY FROM OPERABLE OPENINGS.
- 5. NOT ALL KEYNOTES OR LEGEND SYMBOLS USED ON EVERY


KEYNOTES


- CONCRETE BASE WALL TYP.
- FIBER CEMENT PLANK SIDING
 ASPHALT SHINGLE ROOFING SYSTEM
- 4 INSULATED FIBERGLASS DOOR, TYP.
- VINYL WINDOW SYSTEM, TYP.
 STEEL STAIRS W/ PRE-CAST TREADS AND METAL RAILINGS
- 8 CANOPY
- 9 GUTTER 10 DOWNSPOUT


LEGEND


1 KEYNOTE

X WINDOW TAG

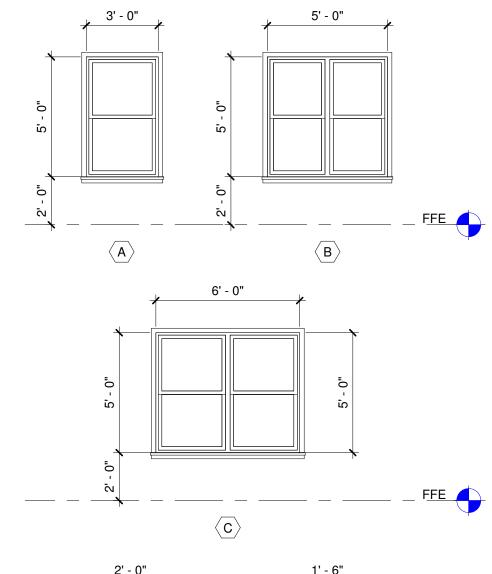

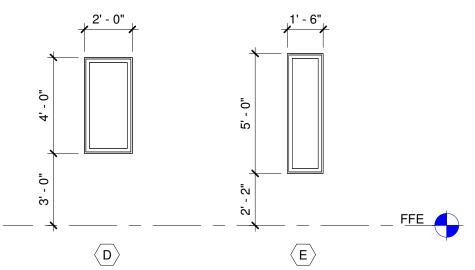

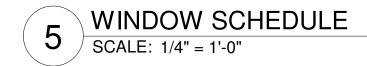

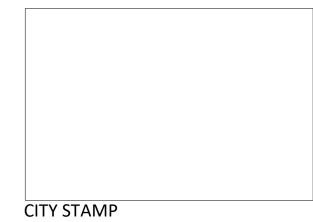

DRAWING TITLE
BUILDING 1

OC-III

APARTMENTS

CONCEPT DESIGN REVIEW

204 LILLY RD NE

OLYMPIA, WA

95806

ISSUANCE

DATE 2/10/21

SCALE As indicated

DRAWN BY

PROJECT NUMBER 202010.00

SHEET NUMBER

ELEVATIONS

mwa architects

SUITE 401


REVISION NO


70 NW COUCH STREET

PORTLAND, OR 97209 P 503 973 5151 F 503 973 5060 MWAARCHITECTS.COM

DRA4.11

4 BUILDING 1 - SOUTH ELEVATION SCALE: 1/8" = 1'-0"

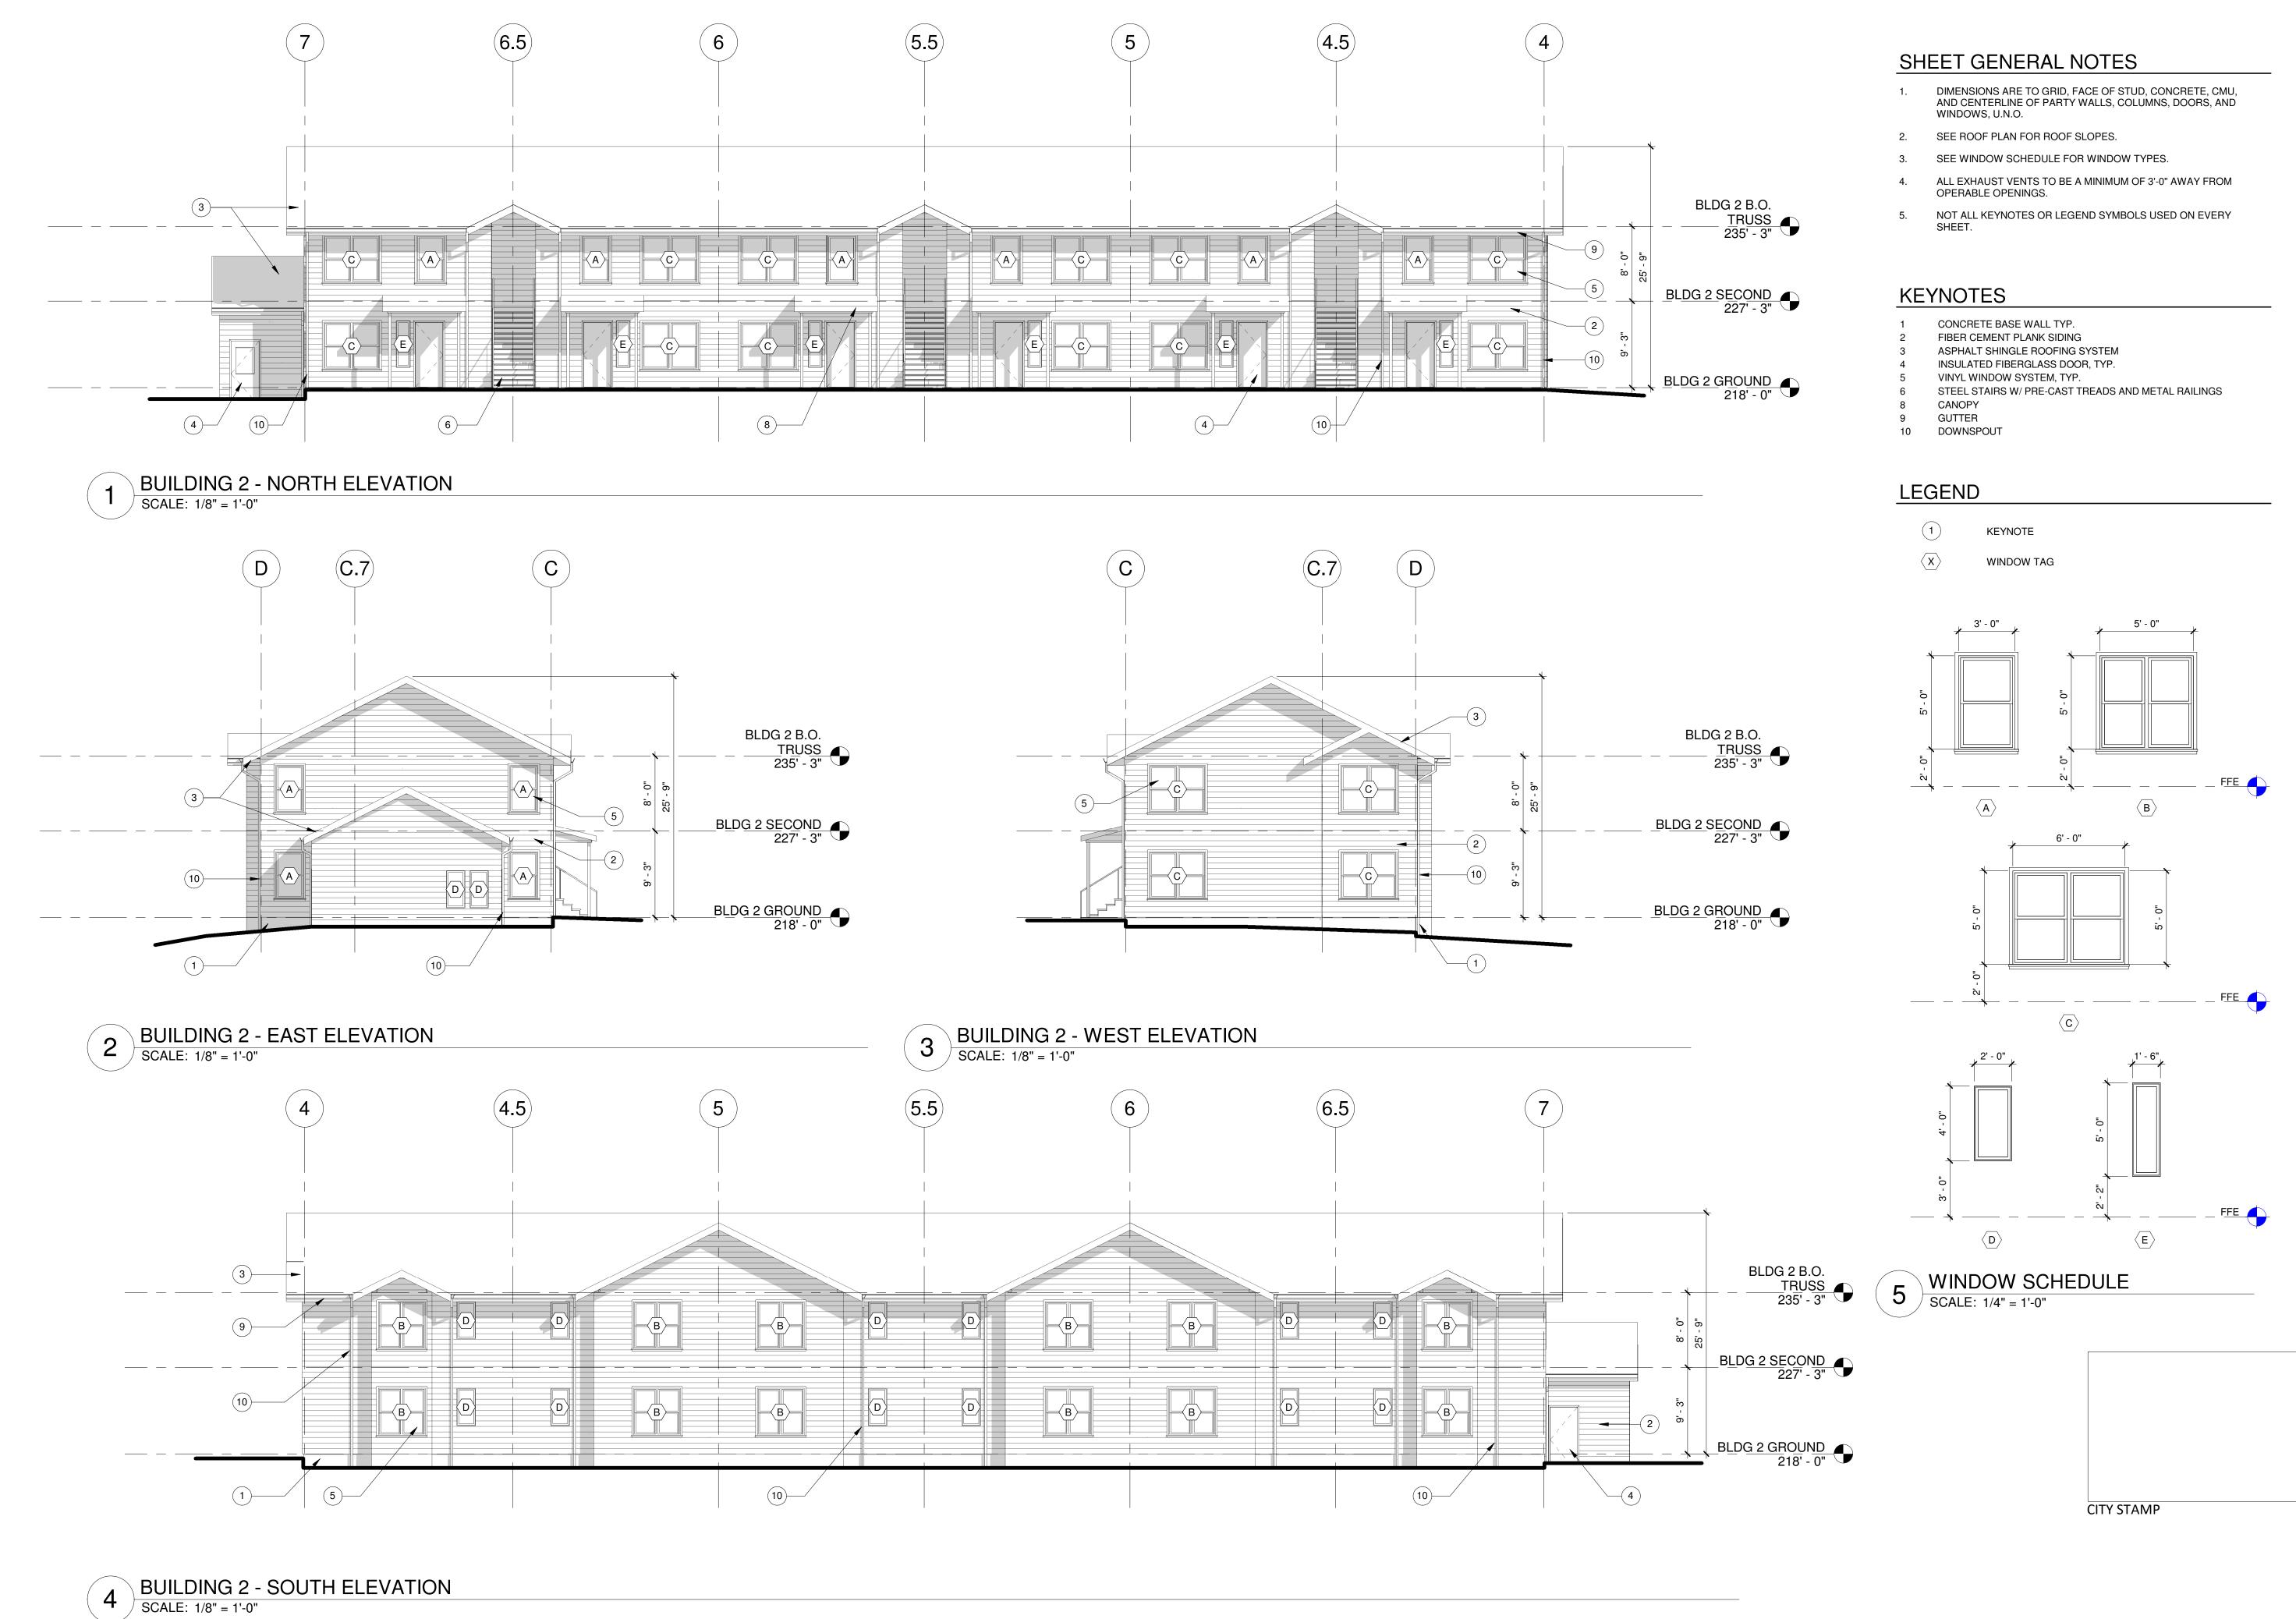

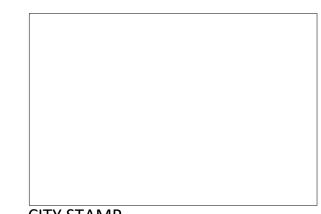

SHEET NUMBER

DRA4.12

mwa architects

SUITE 401

REVISION NO

OC-III

APARTMENTS

CONCEPT DESIGN REVIEW

204 LILLY RD NE

OLYMPIA, WA

95806

ISSUANCE

DATE 2/10/21

SCALE As indicated

202010.00

DRAWN BY

PROJECT NUMBER

DRAWING TITLE

BUILDING 2

ELEVATIONS

70 NW COUCH STREET

PORTLAND, OR 97209 P 503 973 5151 F 503 973 5060 MWAARCHITECTS.COM



mwa architects

70 NW COUCH STREET **SUITE 401** PORTLAND, OR 97209 P 503 973 5151 F 503 973 5060 MWAARCHITECTS.COM





OC-III

204 LILLY RD NE OLYMPIA, WA 95806

ISSUANCE CONCEPT DESIGN REVIEW DATE 2/10/21

SCALE As indicated

PROJECT NUMBER 202010.00


DRAWN BY

DRAWING TITLE

BUILDING 3 ELEVATIONS

SHEET NUMBER

DRA4.13

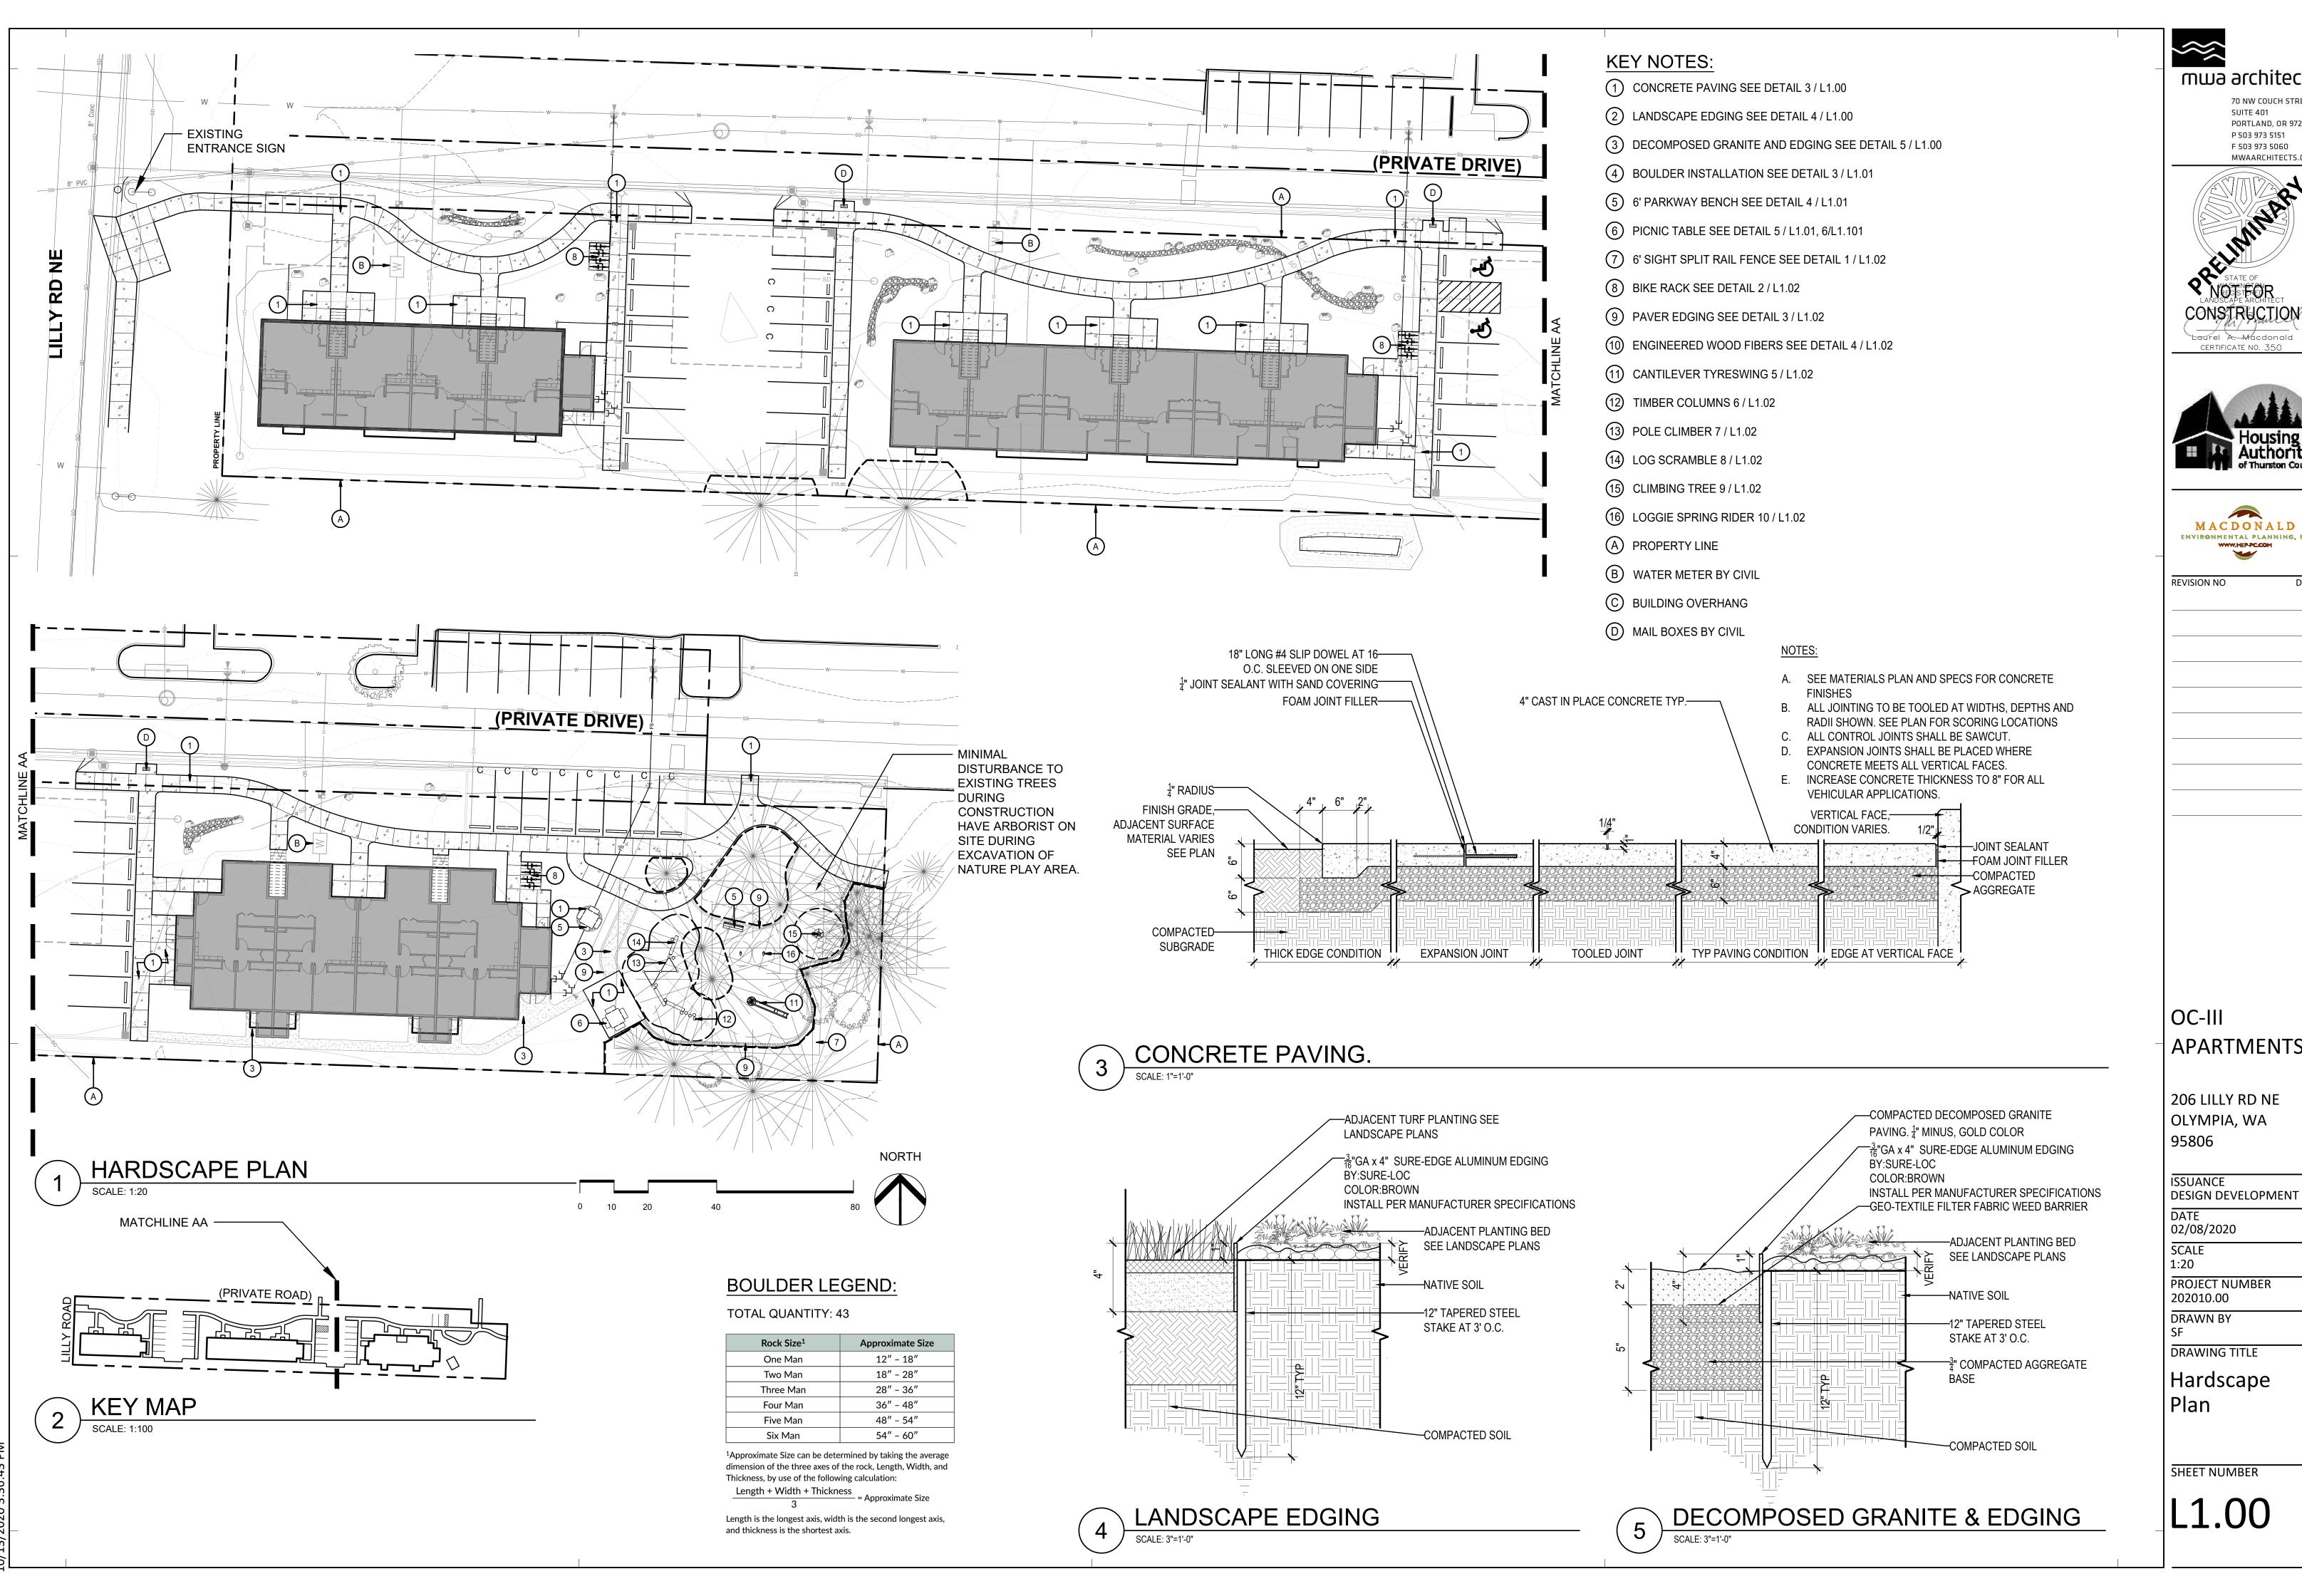

mwa architects 70 NW COUCH STREET **SUITE 401** PORTLAND, OR 97209 P 503 973 5151 F 503 973 5060 MWAARCHITECTS.COM

CONSTRUCTION Laurel A. Macdonald





APARTMENTS

206 LILLY RD NE OLYMPIA, WA

02/08/2020 SCALE PROJECT NUMBER


202010.00 **DRAWN BY**


DRAWING TITLE

Hardscape

SHEET NUMBER

L1.00

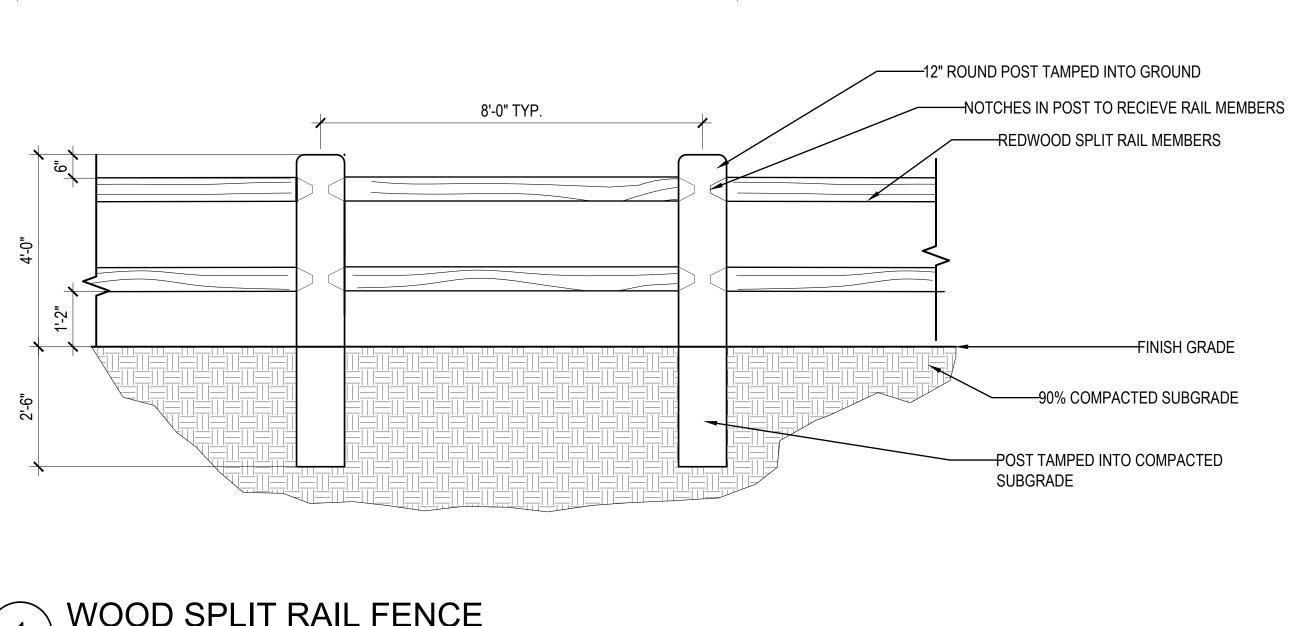

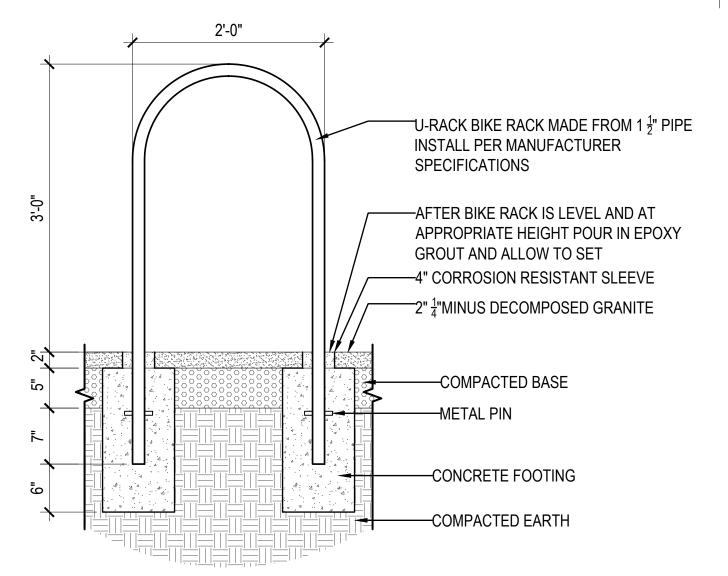

BIKE RACK

1'-0"
TOP OF POST
0'-0"
FINISHED GRADE

-1'-0"
COMPACTED GRADE

-2'-6" BOTTOM OF POST

FRONT VIEW
SCALE: 1/4"=1'-0"

2'-4" MAX. FOR 5 TO 12 YEAR OLDS

1'-10" MAX. FOR 2 TO 5 YEAR OLDS

—11" DIA. LATHE-TURNED TIMBER (TYPICAL-16)

CONCRETE FOOTING

AND NO. 4 REBAR (BY

OTHERS) PER LOCAL


SOIL CONDITIONS.

CONSULT PROJECT


REQUIREMENTS.


TIMBER COLUMNS

ENGINEER FOR EXACT

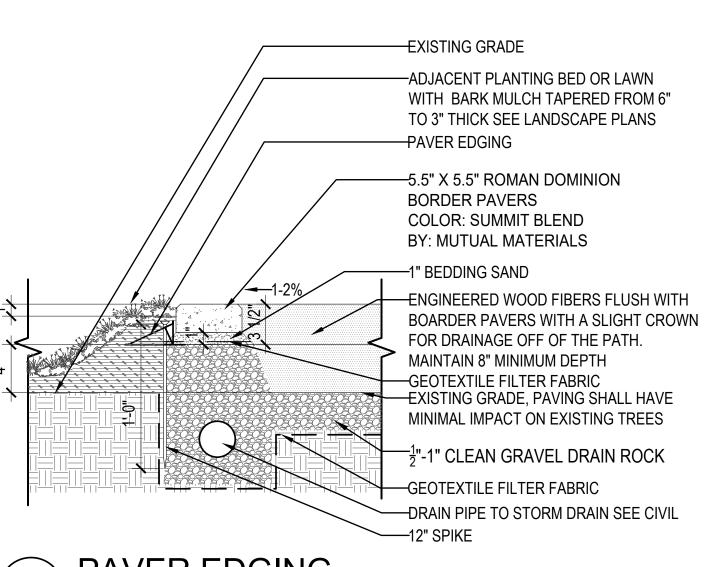



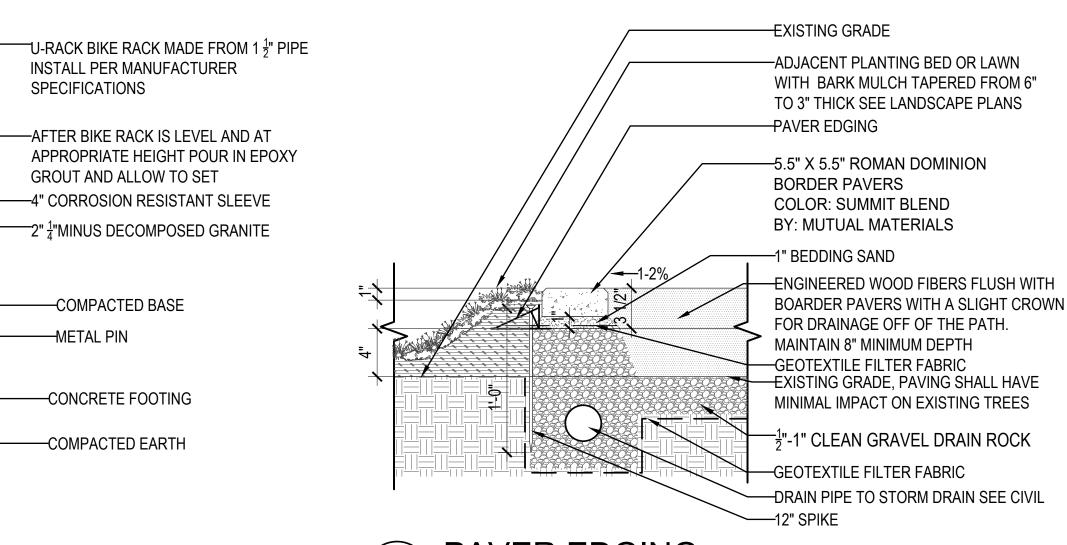

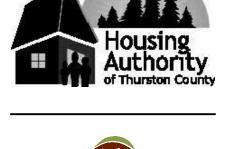

CONSTRUCTION

Laurel A. Macdonald

CERTIFICATE NO. 350

mwa architects

SUITE 401

P 503 973 5151

F 503 973 5060

70 NW COUCH STREET

PORTLAND, OR 97209

MWAARCHITECTS.COM



REVISION NO

OC-III

APARTMENTS

206 LILLY RD NE

DESIGN DEVELOPMENT

OLYMPIA, WA

95806

ISSUANCE

02/08/2020

PER PLAN

202010.00

DRAWN BY

Plan

PROJECT NUMBER

DRAWING TITLE

Hardscape

SCALE

EQUIPMENT ONLY: 9'-1" x 5'-6" MINIMUM SAFE USE ZONE: 21'-1" x 17'-6"


SAFE USE ZONE-


NOTE:
CONCRETE FOOTING AND NO. 4 REBAR (BY OTHERS) PER LOCAL SOIL CONDITIONS. CONSULT PROJECT ENGINEER FOR EXACT

FRONT VIEW

PLAN VIEW WITH USE ZONE SCALE 3/16"=1'-0"



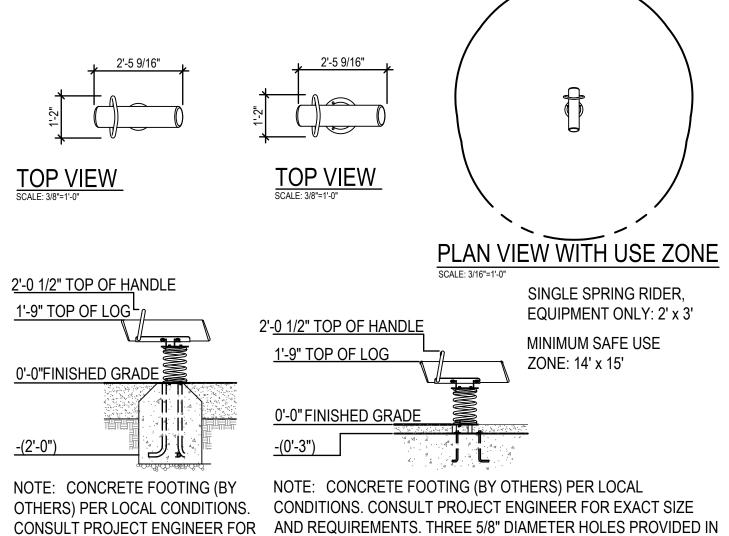

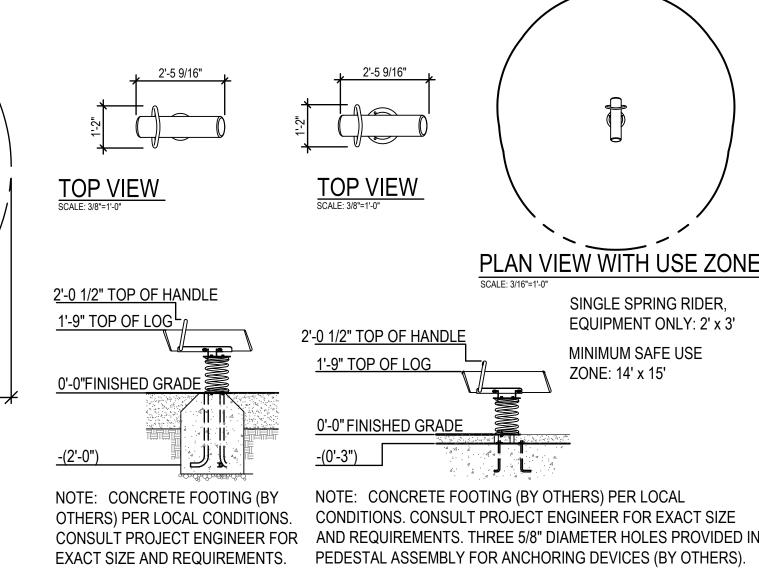


ISO VIEW SCALE: NONE BOTTOM OF POST

REQUIREMENTS.

SCALE 1/8"=1'-0"

POLE CLIMBER

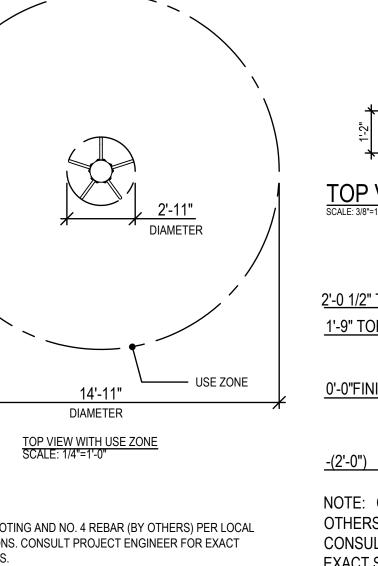

SAFE USE ZONE BORDER —

PLAN VIEW WITH USE ZONE SCALE: 1/8"=1'-0"


5 TO 12 YEAR OLDS (SHOWN) EQUIPMENT ONLY:14'-2" DIA.

EQUIPMENT ONLY:11'-2" DIA.

2 TO 5 YEAR OLDS

MINIMUM SAFE USE ZONE:26'-2" DIA.

MINIMUM SAFE USE ZONE:23'-2" DIA.

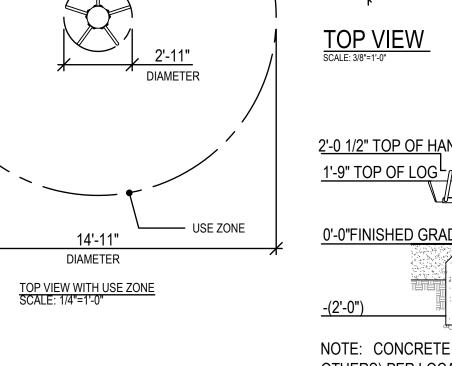

FRONT VIEW 3886-01-E (EMBEDMENT)

SCALE: NTS

FRONT VIEW


3886-01-P (PEDESTAL) LOGGIE SPRING RIDER


L1.02


SHEET NUMBER




ENGINEERED WOOD FIBERS

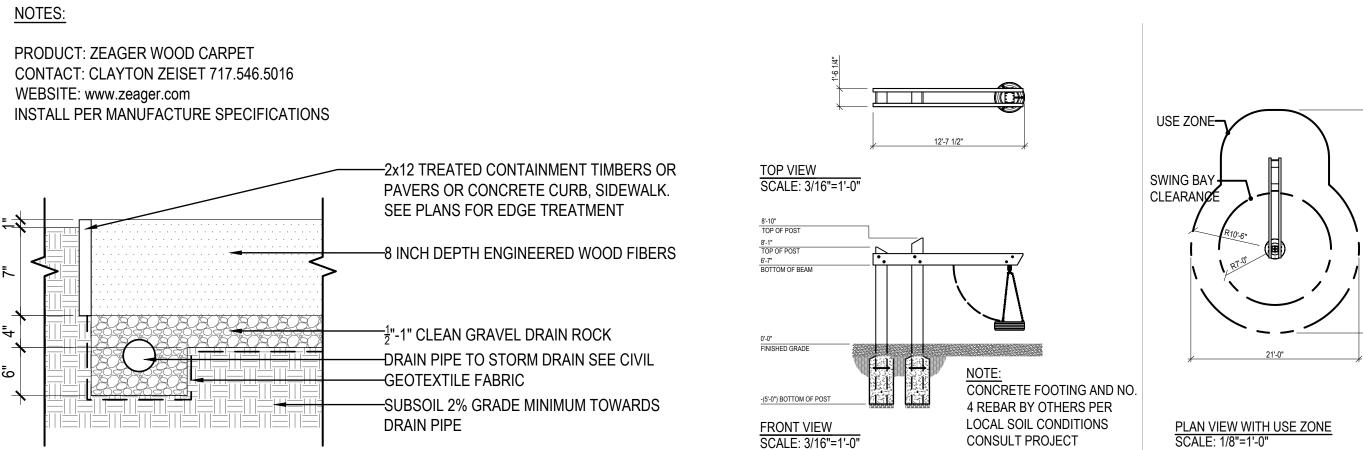


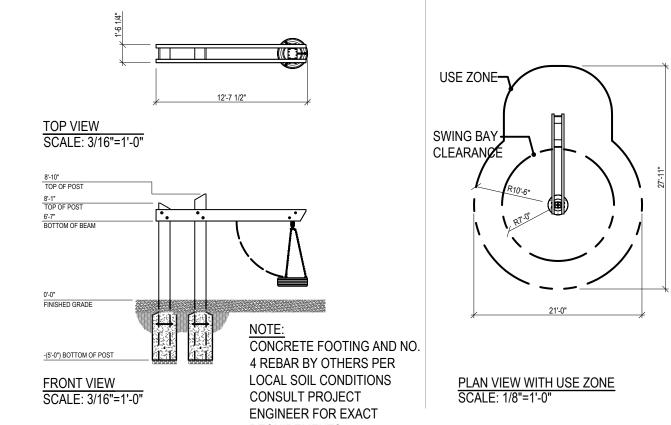


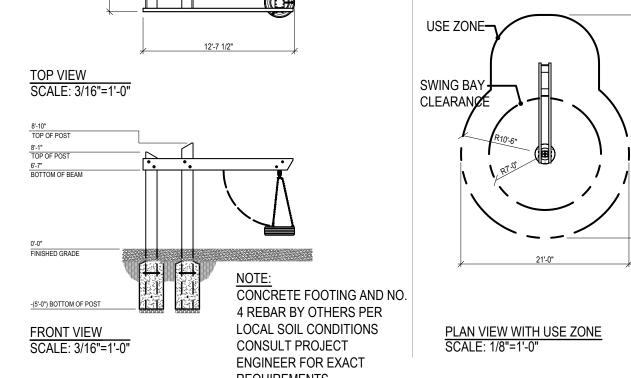



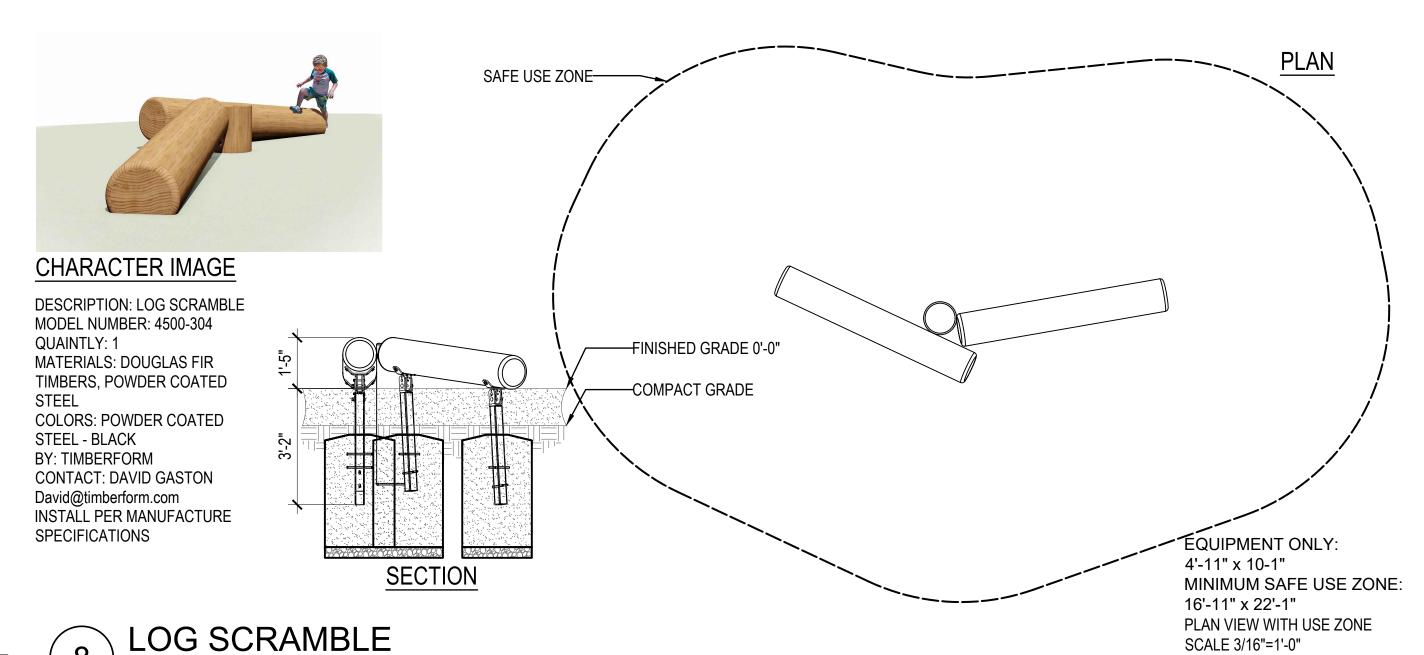

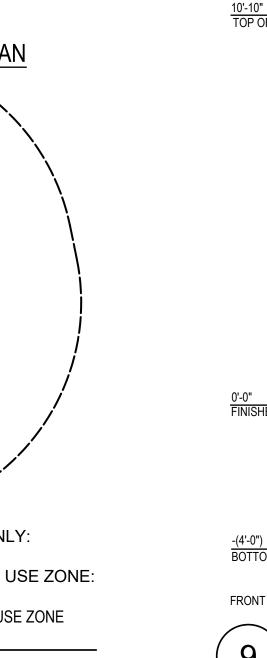


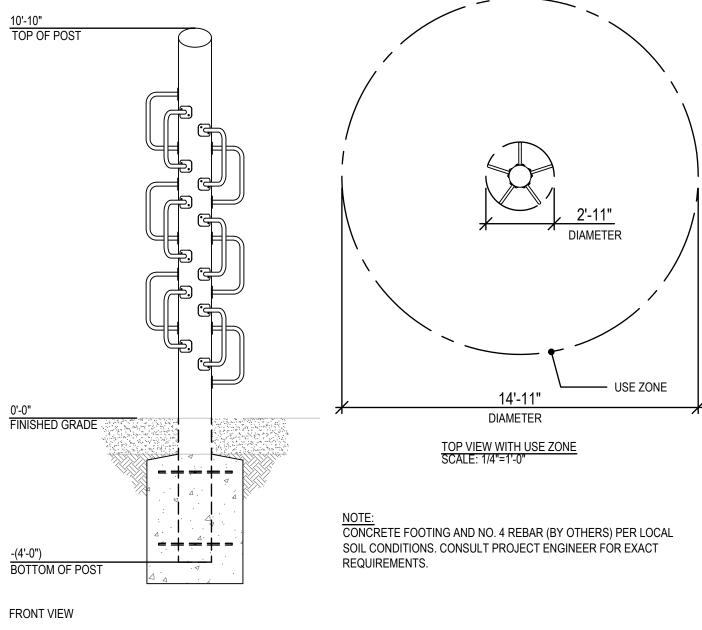

CLASSIC CLIMBING TREE SCALE: 1/4"=1'-0"


SCALE: 3/8"=1'-0"

8

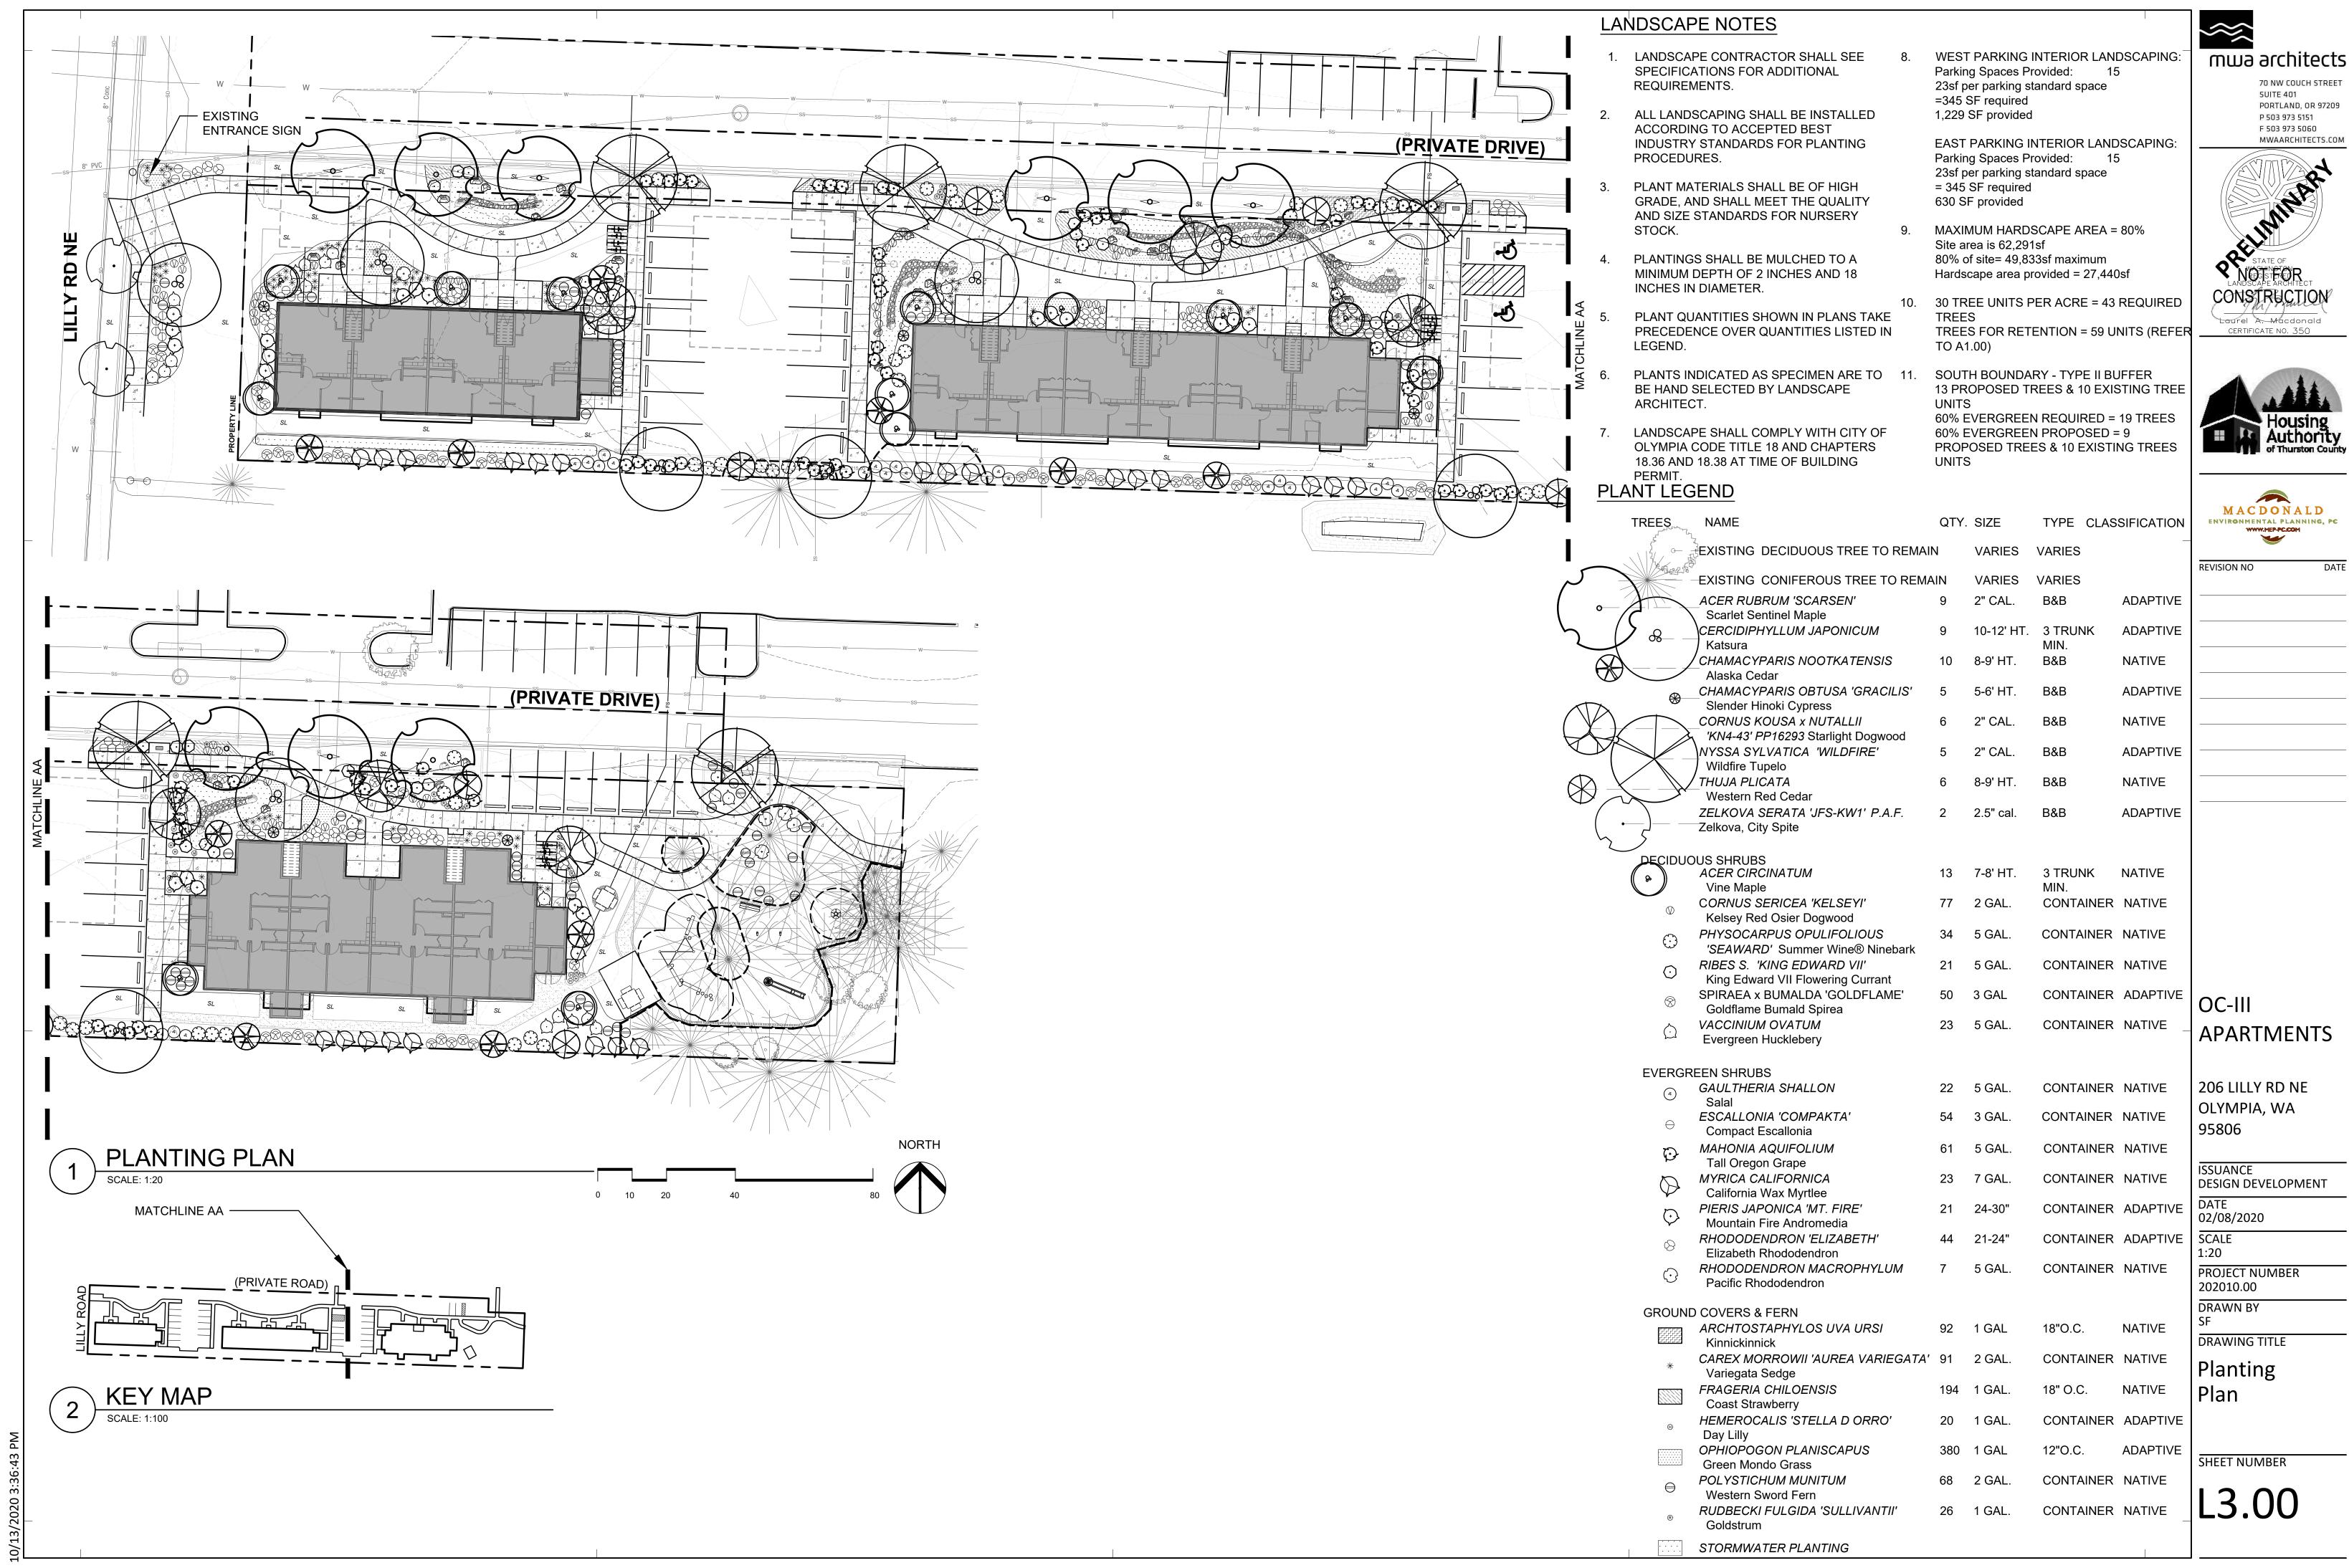







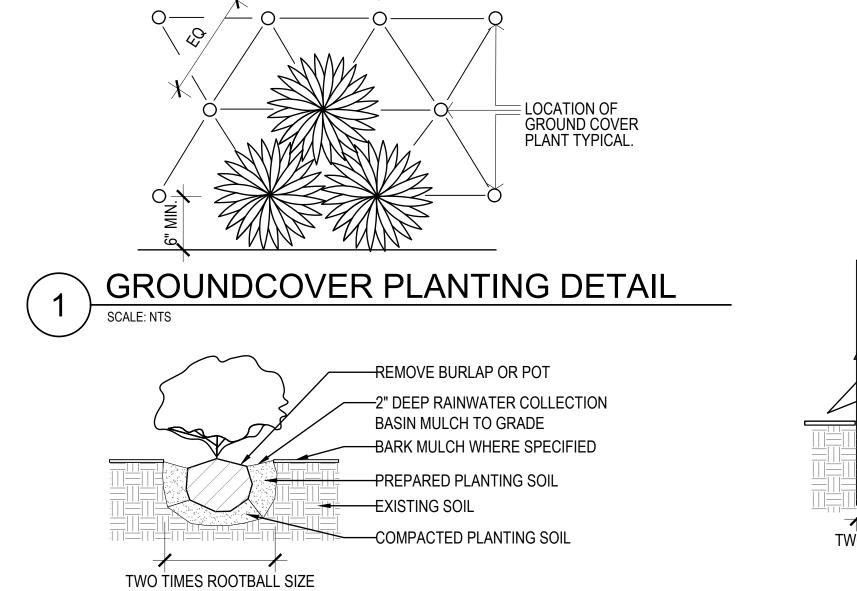


SHRUB PLANTING DETAIL

NOTE: CHECK LEGEND FOR SPACING REQ.

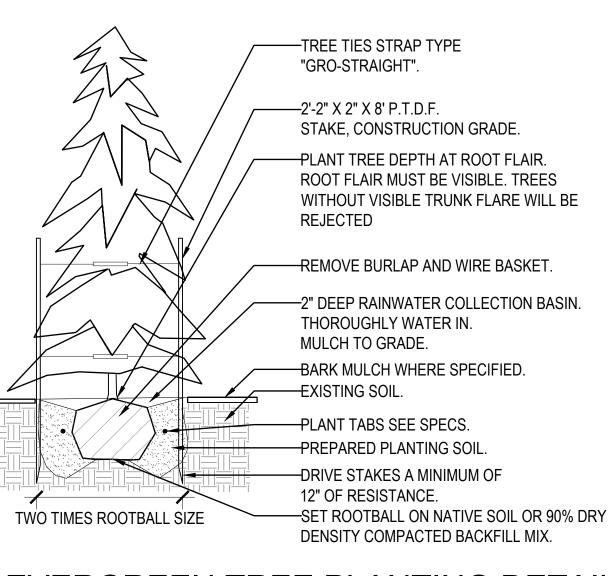

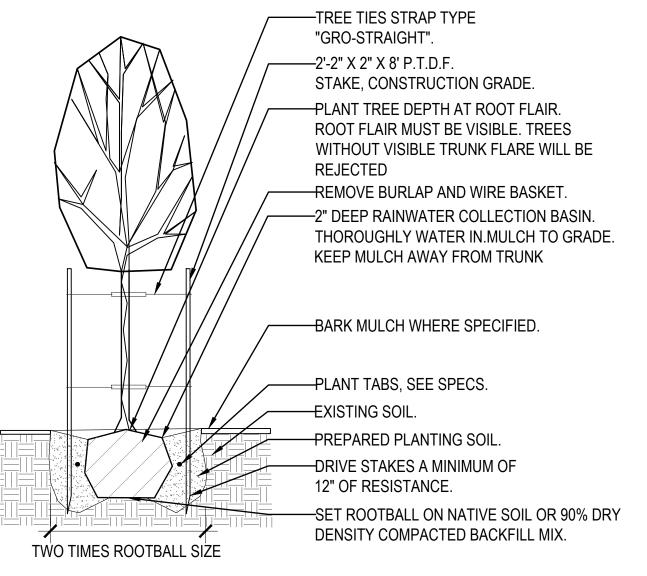

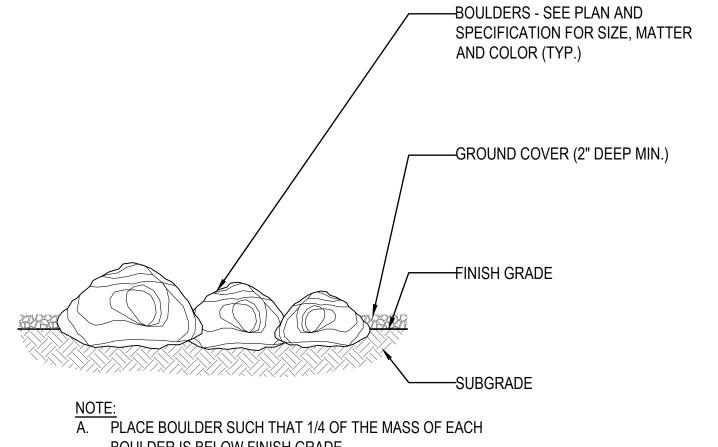

BOULDER IS BELOW FINISH GRADE

BOULDER INSTALLATION

mwa architects 70 NW COUCH STREET **SUITE 401**

PORTLAND, OR 97209 P 503 973 5151 F 503 973 5060 MWAARCHITECTS.COM



MACDONALD ENVIRONMENTAL PLANNING, PC

OC-III **APARTMENTS**

206 LILLY RD NE OLYMPIA, WA 95806

ISSUANCE DESIGN DEVELOPMENT

02/08/2020 SCALE

PROJECT NUMBER 202010.00

DRAWN BY

DRAWING TITLE


Planting Plan Details

SHEET NUMBER

L3.01

EVERGREEN TREE PLANTING DETAIL (3) EVEI SCALE: NTS

DECIDUOUS TREE PLANTING DETAIL

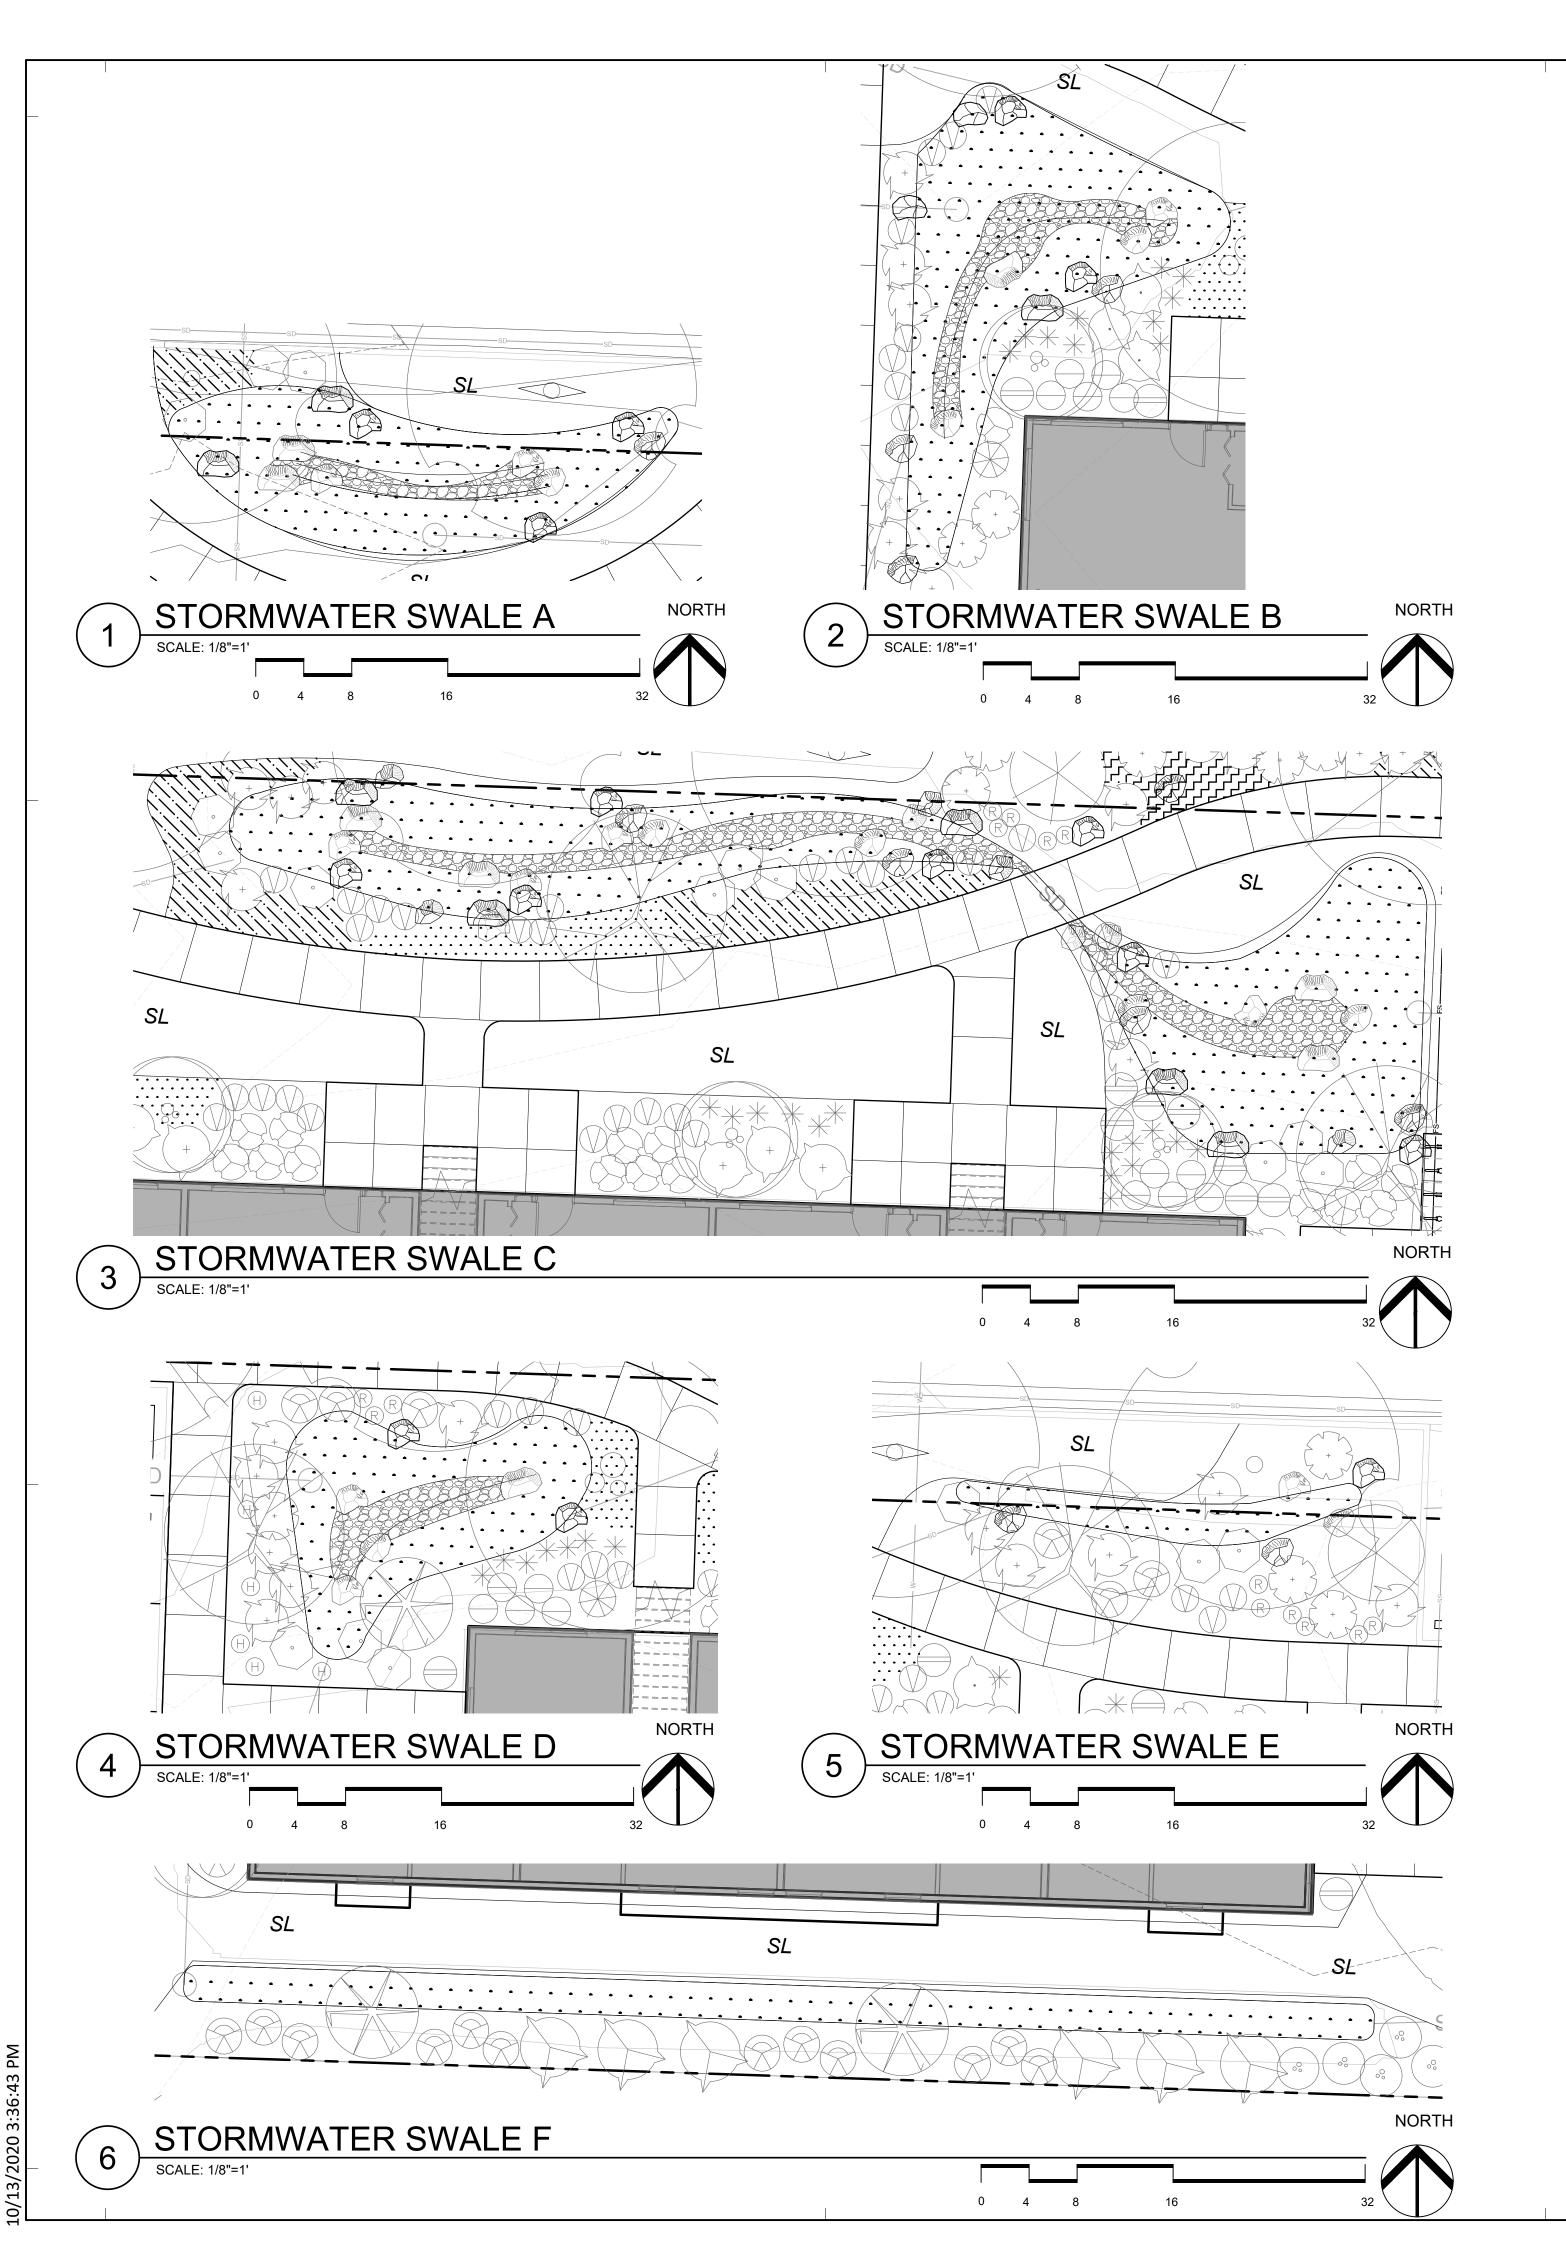

STORM WATER SWALES PLANT TABLES

·	A - PLANTER - 353sf			
<u>SYMBO</u>	L NAME	QTY	SIZE	SPACINO
	CAMASSIA LEICHTLINII Camas Lily	79	1 GAL	15"O.C.
	CAREX STIPATA Sawbeak Sedge	105	1 GAL.	15"O.C.
	JUNCUS TENUIS Slender Rush	52	1 GAL	15" O.C.
	SCRIPTUS AMERICANUS _American Bulrush	26	1 GAL	15"O.C.
	SWALE A - TOTAL PLANTS	S =262		
SWALE	B - PLANTER - 400sf			
SYMBO		QTY	SIZE	SPACINO
	CAMASSIA LEICHTLINII Camas Lily	89	1 GAL	15"O.C.
	CAREX STIPATA Sawbeak Sedge	118	1 GAL.	15"O.C.
	JUNCUS TENUIS Slender Rush	59	1 GAL	15" O.C.
	SCRIPTUS AMERICANUS	30	1 GAL	15"O.C.
	American Bulrush SWALE B - TOTAL PLANTS	S =296		
SWALE	C - PLANTER - 775sf			
<u>SYMBO</u>	L NAME	QTY	SIZE	SPACINO
	CAMASSIA LEICHTLINII Camas Lily	172	1 GAL	15"O.C.
	CAREX STIPATA Sawbeak Sedge	229	1 GAL.	15"O.C.
	JUNCUS TENUIS Slender Rush	115	1 GAL	15" O.C.
	SCRIPTUS AMERICANUS American Bulrush	57	1 GAL	15"O.C.
	SWALE C - TOTAL PLANTS	S =573		
SWALE SYMBO	D - PLANTER - 265sf L NAME	QTY	SIZE	SPACINO
	CAMASSIA LEICHTLINII	59	1 GAL	15"O.C.
	Camas Lily			
	CAREX STIPATA	78	1 GAL.	15"O.C.
	Sawbeak Sedge JUNCUS TENUIS Slender Rush	39	1 GAL	15" O.C.
	SCRIPTUS AMERICANUS	20	1 GAL	15"O.C.
	American Bulrush SWALE D - TOTAL PLANTS	S = 196		
	E - PLANTER - 93sf			
<u>SYMBO</u>		QTY	SIZE	SPACINO
• • • • • • • •	CAMASSIA LEICHTLINII Camas Lily	21	1 GAL	15"O.C.
	CAREX STIPATA Sawbeak Sedge	28	1 GAL.	15"O.C.
	JUNCUS TENUIS Slender Rush	14	1 GAL	15" O.C.
	SCRIPTUS AMERICANUS _American Bulrush	7	1 GAL	15"O.C.
	SWALE E - TOTAL PLANTS	S = 70		
SWALE SYMBO	F - PLANTER - 297sf L NAME	QTY	SIZE	SPACINO
<u></u>	CAMASSIA LEICHTLINII	66	1 GAL	15"O.C.
	Camas Lily			
	CAREX STIPATA Sawbeak Sedge	88	1 GAL.	15"O.C.
	JUNCUS TENUIS	44	1 GAL	15" O.C.

STORMWATER PLANTING NOTES

- LANDSCAPE CONTRACTOR SHALL SEE CIVIL DRAWINGS FOR STORMWATER CATCHMENTS CONSTRUCTION DETAILS AND NOTES.
- 2. PLANT MATERIALS SHALL BE OF HIGH GRADE, AND SHALL MEET THE QUALITY AND SIZE STANDARDS FOR NURSERY
- 3. STORMWATER FACILITIES SHALL BE INSTALLED, PLANTED AND MAINTAINED TO COMPLY WITH LID TECHNICAL GUIDANCE MANUAL FOR PUGET SOUND
- 4. ALL STORMWATER FACILITY PLANTING SHALL HAVE A 90% SURVIVAL RATE AT 2 YEARS FROM PLANTING. FACILITIES NOT IN COMPLIANCE AT THE 2 YEAR MARK SHALL BE REPLANTED TO COMPLY.

206 LILLY RD NE
OLYMPIA, WA
95806

ISSUANCE
DESIGN DEVELOPMENT

OC-III

APARTMENTS

mwa architects

SUITE 401

CERTIFICATE NO. 350

MACDONALD
ENVIRONMENTAL PLANNING, PC

REVISION NO

P 503 973 5151

F 503 973 5060 MWAARCHITECTS.COM

70 NW COUCH STREET

PORTLAND, OR 97209

02/08/2020 SCALE

PROJECT NUMBER

202010.00 DRAWN BY


SF SPANNING TITL

DRAWING TITLE

Stormwater Planting Plans

SHEET NUMBER

L3.02

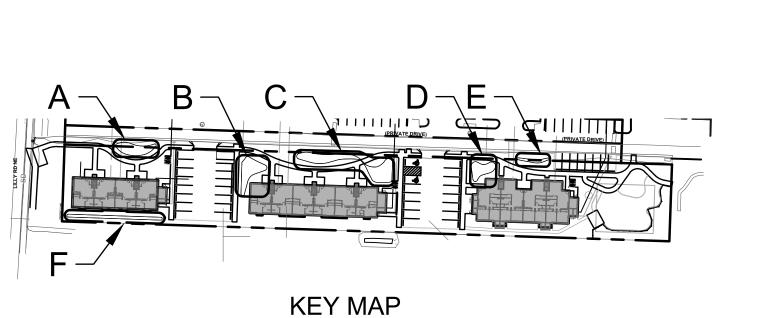

Slender Rush

American Bulrush

SCRIPTUS AMERICANUS

SWALE E - TOTAL PLANTS =220